REPLACEMENT OF SECURITY PERIMETER FENCE BALZANO MARINE TERMINAL

	LIST OF UTILITIES
WATER & SEWER:	CAMDEN WATER L.L.C. 1257 S. SECOND ST. CAMDEN, NJ 08104 856-635-1264
WATER:	NEW JERSEY AMERICAN WATER CO. 213 CARRIAGE LANE DELRAN, NJ 08075
GAS:	PSE&G GAS DISTRIBUTION DIVISION 300 CONNECTICUT DRIVE BURLINGTON, NJ 08086 856-778-6776 ATTN: GEORGE BAKER
ELECTRIC:	PSE&G ELECTRIC DISTRIBUTION DIVISION 300 NEW ALBANY ROAD MOORESTOWN, NJ 08057 856-573-2077 ATTN: BOB SODER
CABLE:	COMCAST 1250 HADDONFIELD ROAD CHERRY HILL, NJ 08034 856-272-1000
TELEPHONE:	VERIZON - NEW JERSEY 10 TANSBORO ROAD BERLIN, NJ 08009
AT&T:	TRANSCONTINENTAL CABLE ROUTE UNDERGROUND LOCATION SERVICE NEW JERSEY UTILITIES ASSOCIATION 800-252-1133

FUNDING SOURCE:

SJPC



TO CONTACT NJ ONE CALL PRIOR TO THE START OF CONSTRUCTION. CALL FOR MARKOUTS THREE (3) FULL BUSINESS DAYS IN ADVANCE AND BEGIN **EXCAVATION WITHIN 10 DAYS. ALL CONTRACTORS** ON-SITE MUST HAVE THEIR OWN MARKOUT.

THE ELECTRONIC VERSION OF THE 2019 NEW JERSEY DEPARTMENT OF TRANSPORTATION STANDARD SPECIFICATIONS FOR ROAD AND BRIDGE CONSTRUCTION, EFFECTIVE SEPTEMBER 1, 2019, AS REFERENCED IN BASELINE DOCUMENT CHANGE ANNOUNCEMENT BDC19S-01, UNLESS MODIFIED WITHIN THE TECHNICAL SPECIFICATIONS OF THIS CONTRACT, SHALL GOVERN. THE NEW JERSEY DEPARTMENT OF TRANSPORTATION "STANDARD ROADWAY CONSTRUCTION TRAFFIC CONTROL BRIDGE CONSTRUCTION DETAILS" BOOKLET DATED 2007 AND "ELECTRICAL BUREAU STANDARD DETAILS, 2007" AND ALL BASELINE DOCUMENT CHANGES MADE TO THESE CONSTRUCTION DETAILS, SHALL GOVERN, EXCEPT FOR THOSE DETAILS CONTAINED HEREIN.




OCTOBER, 2021

CITY OF CAMDEN CAMDEN COUNTY, NEW JERSEY

SCALE: 1" = 1000'

PROJECT LOCATION MAP

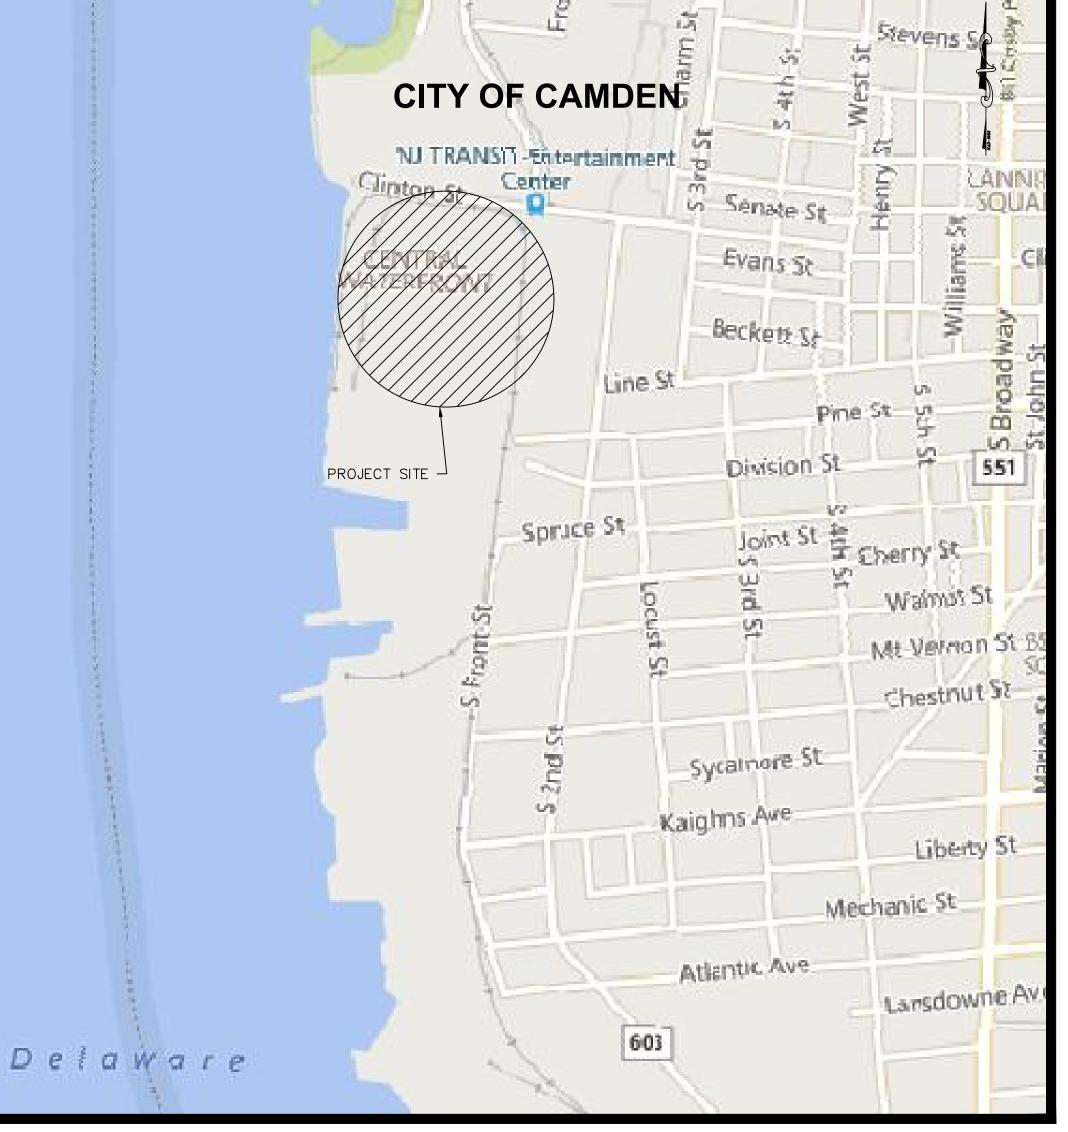

	SHEET INDEX
SHEET #	DESCRIPTION
1	TITLE
2	LEGEND
3	ESTIMATE & GENERAL NOTES
4	OVERALL SITE PLAN
5 - 7	CONSTRUCTION PLAN
8 - 11	CONSTRUCTION DETAILS

	REMINGTON BOOM REMINGTON & VERNICK BOD BOD SPRINGDALE ROAD CHERRY HILL, NJ 08003 (856) 795-9595, FAX (856) 795-1882 WEB SITE ADDRESS : WWW.RVE.COM Certification of Authorization: 24 GA 28003300 ~ENGINEERING EXCELLENCE~					
	DATE: WILLIAM M	. BISIRRI				
	NJ PROFESSIONAL ENG					
	PLANS WHICH AN EMBOSSED SEA					
	ALL DOCUMENTS PREPARED ENGINEERS AND AFFILIAT SERVICE IN RESPECT OF TH INTENDED OR REPRESENTED BY OWNER OR OTHERS ON EJ OR ON ANY OTHER PROJE WRITTEN VERIFICATION OR AI VERNICK ENGINEERS AND AF PURPOSE INTENDED WILL BE WITHOUT LIABILITY OR LEGAT & VERNICK ENGINEERS AND SHALL INDEMNIFY AND HOLD VERNICK ENGINEERS AND AF DAMAGES, LOSSES AND EXP R E S U L T I N G	ES ARE INSTRUMENTS OF IE PROJECT. THEY ARE NOT TO BE SUITABLE FOR REUSE XTENSIONS OF THE PROJECT CT. ANY REUSE WITHOUT DAPTATION BY REMINGTON & FFILIATES FOR THE SPECIFIC AT OWNERS SOLE RISK AND L EXPOSURE TO REMINGTON D AFFILIATES; AND OWNER D HARMLESS REMINGTON & FFILIATES FROM ALL CLAIMS,				
		BY CHK				
		DATE				
		No.				
	TITLE SHEET	SOUTH JERSEY PORT CORPORATION REPLACEMENT OF SECURITY PERIMETER FENCE BALZANO MARINE TERMINAL CITY OF CAMDEN COUNTY NEW JERSEY				
T-1	DRAWN BY: DESIGN BY: CFC DHS DATE:	CHECKED BY: SCALE: WMB AS NOTED				
	4/20/2021 <u>JOB No. :</u> 3965X001	1 of 11				

TEM	DESCRIPTION	EXISTING	PROPOSED	ITEM
	OVERHEAD WIRE	OHW		
	SANITARY FORCE MAIN PIPE	FM	FM	
	STORM SEWER PIPE $\leq 12"$	D	D	
	STORM SEWER PIPE > 12"	(<i>SIZE</i> & <u>TYPE</u>)	(<u>SIZE & TYPE)</u>	
	GAS SERVICE	<i>G</i>	G	
	SANITARY SEWER PIPE ≤ 12 "	S		
	SANITARY SEWER PIPE $> 12"$	(<i>SIZE & TYPE</i>) ====================================	$= \underline{(SIZE} \stackrel{\&}{=} \underline{TYPE} = \underline{=}$	
	ELECTRIC SERVICE	E	E	
	FIBER OPTIC SERVICE	F0	FO	
	TELEPHONE SERVICE	<i>T</i>	T	
	COMMUNICATIONS SERVICE	<i>c</i>	C	
	IRRIGATION PIPE	IRR	IRR	N
	WATER SERVICE	w	w	N S
	WATER SHUT-OFF	m So		
	WATER METER	w.m.	W_M	
	WATER VALVE		► NEW ► RESET	
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STANDARD LEGEND NOTE: ALL SYMBOLS MAY NOT BE USED

ITEM EXISTING DESCRIPTION PROPOSED DESCRIPTIC EDGE OF PAVEMENT CROWS FOOT Ý +AERIAL TARGET CURB ∎ (SET) CONCRETE MONUMENT · PAVEMENT / CONC. / • (SET) PK / MAG NAIL 0 DRILL HOLE SPIKE DRILL HOLE W/ WINGS - 0 -STAKE Δ ▲ (SET) HUB Δ ▲ (SET) LIMIT OF EXCAVATION PIN W/ CAP • (SET) GUIDE RAIL Θ **IRON PIPE ADWORK** • (SET) **IRON PIN** BOLLARD 🕱 (SET) MAILBOX CROSS CUT Ø DISK O SIGNS STONE 0 FLAG POLE BENCH REBAR RO BASELINE PILE DETECTABLE WARNIN CENTERLINE ____ 3 TYPICAL STRIPING EASEMENT _ _ _ _ _ _ _ _ _ _ _ _ _ _ _ _ _ _ _ SITE RIGHT-OF-WAY ADA STRIPING PROPERTY BOUNDARY TRAFFIC CONTROL BO ADJACENT PROPERTY BOUNDARY TRAFFIC LIGHT ______ DEPT. OF TRANSPORT RAILROAD TRACKS STATE BOUNDARY STATE HIGHWAY DEP MUNICIPAL / COUNTY BOUNDARY RAILROAD CROSSING CALL BOX � ^{B−}# BORING LOCATION 🔶 В-# OIL FILL ● ^{MW-}# UNDERGROUND STOF MONITORING WELL LOCATION **₽** м₩-# ∎ TP-# TEST PIT LOCATION RISER PIPE ₽*TP−*# ₿ *FW*-# FRESHWATER WETLAND FLAG RAISED PAVEMENT M FRESHWATER WETLAND LINE ______ **BBQ GRILL** FRESHWATER WETLAND BUFFER _____ EDGE OF WATER ____ . . ____ . . ____ . . ____ . WATER FOUNTAIN . _____ . . _____ . _____ STREAM CENTERLINE KIOSK ______ U MIS AIR CONDITIONER * * * * * * * * * GRASS/SOD PARKING METER ORNAMENTAL • SHADE DECIDUOUS TREE FIRE CONTROL VALVE SHRUBS / BUSH Q BARRICADE Miller Marker EVERGREENS Ø STUMP PHOTO LOCATION WOODS / TREE LINE BENCHMARK LOCATIO 4 WIRE FENCE ____//____//_____//_____ ____//____//_____//____ TYPICAL SECTION ARI CENE SPLIT RAIL FENCE ____O____O_____ ____<u>O___O__</u>__ MATCH LINE WOOD / VINYL FENCE ____O____O____ TYPICAL NORTH ARRO CHAIN-LINK FENCE _____x____x_____ _____X____X_____X_____ TOP OF BANK / DITCH ______ *TB* _____ TIONS APR. APRON BOTTOM OF BANK / DITCH _____ BB _____ BASELINE BL BM BENCH MARK CONTOUR (MAJOR) _____5 _____ BIT. BITUMINOUS BLDG. BUILDING CONTOUR (MINOR) _ _ _ _ _ _ <u>3</u> _ _ _ _ _ _ _____ 3 _____ CL CENTERLINE 4 C.I.P. CAST IRON PIPE FLOW LINE / SWALE CONC. CONCRETE Ž C.M.P. CORRUGATED METAL PIP TIME OF CONCENTRATION - **>** ____ **>** ____ ____**>** CULV. CULVERT BBRE D.C. DEPRESSED CURB χ3.48 _Х ^{3.48} DH DRILL HOLE SPOT GRADE TC5.45 DIA. DIAMETER TC5.45 GL4.95 DWY DRIVEWAY ROADWAY GRADE GL 4.95 D.I.P. DUCTILE IRON PIPE ------4 DRAINAGE FLOW EL. ELEVATION \implies \implies EX. EXISTING

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	MAX. MIN. NO. N.T.S.	MAXIMUM MINIMUM NUMBER NOT TO SCALE	R.O.W. RIGHT OF WAY R.R. RAILROAD RTE. ROUTE SAN. SANITARY	VIF VERIFY IN FIELD WM WATER METER	CFC DHS DATE : 4/20/2021 JOB No. : 3965X001	WMB AS NOTED SHEET No.: 2 of 11
	PERF.	PERFORATED	SWK. SIDEWALK	LGD-1		

ESTIMATE OF QUANTITIES				
ITEM NO.	DESCRIPTION	QUANTITY	UNIT	
001	REMOVAL OF VEGETATION	1	LS	
002	6' ORNAMENTAL ALUMINUM FENCE	175	LF	
	8' HIGH CHAIN LINK FENCE WITH			
003	BARBED WIRE TOP	1450	LF	
	10' HIGH CHAIN LINK FENCE WITH			
	BARBED WIRE TOP AND PRIVACY			
004	SLATS	1000	LF	
005	8' HIGH BI-FOLD GATE	1	EA	
006	8' HIGH RAIL GATE	1	EA	
	10' HIGH RAIL GATE WITH BARBED			
007	WIRE TOP AND PRIVACY SLATS	1	EA	
008	8' HIGH DOUBLE SWING GATE	2	EA	
009	8' HIGH SINGLE SWING GATE	1	EA	
	10' HIGH DOUBLE SWING GATE			
	WITH BARBED WIRE TOP AND			
010	PRIVACY SLATS	2	EA	

GENERAL NOTES:

- 1. CONTRACTOR SHALL VERIFY ALL DIMENSIONS AND EXISTING CONDITIONS IN THE FIELD PRIOR TO THE START OF THE CONSTRUCTION, ANY ERRORS OR DISCREPANCIES SHALL BE BROUGHT TO THE ATTENTION OF THE ENGINEER IMMEDIATELY.
- 2. LOCATION OF EXISTING UTILITIES ARE APPROXIMATE AND MUST BE VERIFIED IN THE FIELD PRIOR TO THE START OF CONSTRUCTION.
- 3. THE CONTRACTOR SHALL USE EXCAVATED MATERIALS FOR BACKFILL UNLESS OTHERWISE DIRECTED BY THE ENGINEER.
- 4. ALL PAVED AND CONCRETE AREAS DISTRIBUTED DURING CONSTRUCTION SHALL BE RESTORED TO EXISTING CONDITION AT LEAST EQUAL TO THAT WHICH EXISTED PRIOR TO THE START OF CONSTRUCTION.
- 5. ALL GRASSED OR WOODED AREAS DISTRIBUTED DURING CONSTRUCTION SHALL BE TOPSOILED AND SEEDED.
- 6. ALL FILL SHALL BE PLACED IN 12" LAYERS AND THOROUGHLY COMPACTED TO THE SATISFACTION OF THE ENGINEER. IF BORROW FILL IS REQUIRED, IT SHALL BE SUBJECT TO THE APPROVAL OF THE ENGINEER.
- 7. THE CONTRACTOR SHALL BE RESPONSIBLE FOR THE LOCATION AND PRESERVATION OF THE UNDERGROUND AND SURFACE UTILITIES AND STRUCTURES AT OR ADJACENT TO THE SITE OF CONSTRUCTION AND IT SHALL BE AT HIS OWN EXPENSE TO REPAIR OR REPLACE ANYTHING THAT HE DAMAGES.
- 8. APPROXIMATE DEPTH OF ALL WATER MAINS ARE \pm 4 FEET.
- 9. APPROXIMATE DEPTH OF ALL GAS MAINS ARE \pm 3 FEET.
- 10. ALL UNUSED MATERIAL EXCAVATED FROM THE PROJECT SITE ARE TO BE DISPOSED OF AT AN APPROVED FACILITY.
- 11. FENCING TO COMPLY WITH UNITED FACILITIES CRITERIA (UFC) 4-022-03, SECURITY FENCES AND GATES.
- 12. GATE IDENTIFICATION PLACARDS AND ALL FENCE SIGNS SHALL BE REMOVED PRIOR TO CONSTRUCTION AND
- PRESERVED BY THE CONTRACTOR FOR THE DURATION OF CONSTRUCTION. 13. CONTRACTOR SHALL REPLACE ALL GATE IDENTIFICATION PLACARDS AND FENCE SIGNS UPON COMPLETION OF CONSTRUCTION.
- 14. CONTRACTOR SHALL RESTORE ALL GATE ALARMS AND OTHER FENCE SECURITY DEVICES TO FULL WORKING ORDER UPON COMPLETION OF CONSTRUCTION.

REMARKS
SEE PLAN NOTES FOR
LOCATION
G4
G6
G1
G5, G7
G8
G2, G3

CONSTRUCTION STAGING REQUIREMENTS:


<u>option a:</u>


- SECURITY FENCE REPLACEMENT SHALL BE LIMITED TO ONE (1), 400' (FEET) LENGTH OF FENCE MAXIMUM AT A TIME.
- 2. WHEN FENCE SECTIONS ARE REMOVED, A PORT SECURITY GUARD SHALL BE POSTED AT THAT LOCATION FOR THE DURATION OF THE WORK AND/OR UNTIL FENCE SECTION HAS BEEN REPLACED AND THE SECURITY PERIMETER FENCE IS DEEMED SECURE.
- THE INTENT OF THIS PROCEDURE IS TO ENSURE THAT NO SECTION OF THE FENCE IS REMOVED BEYOND THAT WHICH CANNOT BE FULLY REPLACED DURING ONE WORK DAY.
- 4. AT THE END OF EACH WORK DAY, THE PORT PERIMETER SECURITY FENCING SHALL BE FULLY INTACT AND SECURE IN ACCORDANCE WITH USCG REQUIREMENTS.

<u>option B:</u>

- 1. SHOULD THE CONTRACTOR ELECT TO USE TEMPORARY FENCING/BARRIERS TO ALLOW FOR MORE THAN 400' (FEET) OF FENCE REMOVAL AT A TIME, THE FOLLOWING WILL BE REQUIRED: TEMPORARY FENCING LAYOUT, MATERIALS AND LENGTH OF FENCE REMOVAL SUBJECT TO ENGINEER APPROVAL.
- 2. TEMPORARY FENCING SHALL MEET USCG STANDARDS AND REQUIREMENTS.
- 3. POSTS FOR TEMPORARY FENCING SHALL BE ADEQUATELY ANCHORED INTO THE GROUND. FENCE POST STANDS ON GRADE ARE NOT ACCEPTABLE.
- 4. AN APPROVED TEMPORARY FENCING SYSTEM SHALL BE INSTALLED SUCH THAT IT REMAINS IN PLACE AT ALL TIMES AND THE PORT REMAINS SECURE. ANY OPENINGS IN THE SECURITY PERIMETER, HOWEVER TEMPORARY, SHALL BE APPROVED BY THE ENGINEER AND SHALL HAVE A PORT SECURITY GUARD POSTED FOR THE DURATION OF THE OPENING.


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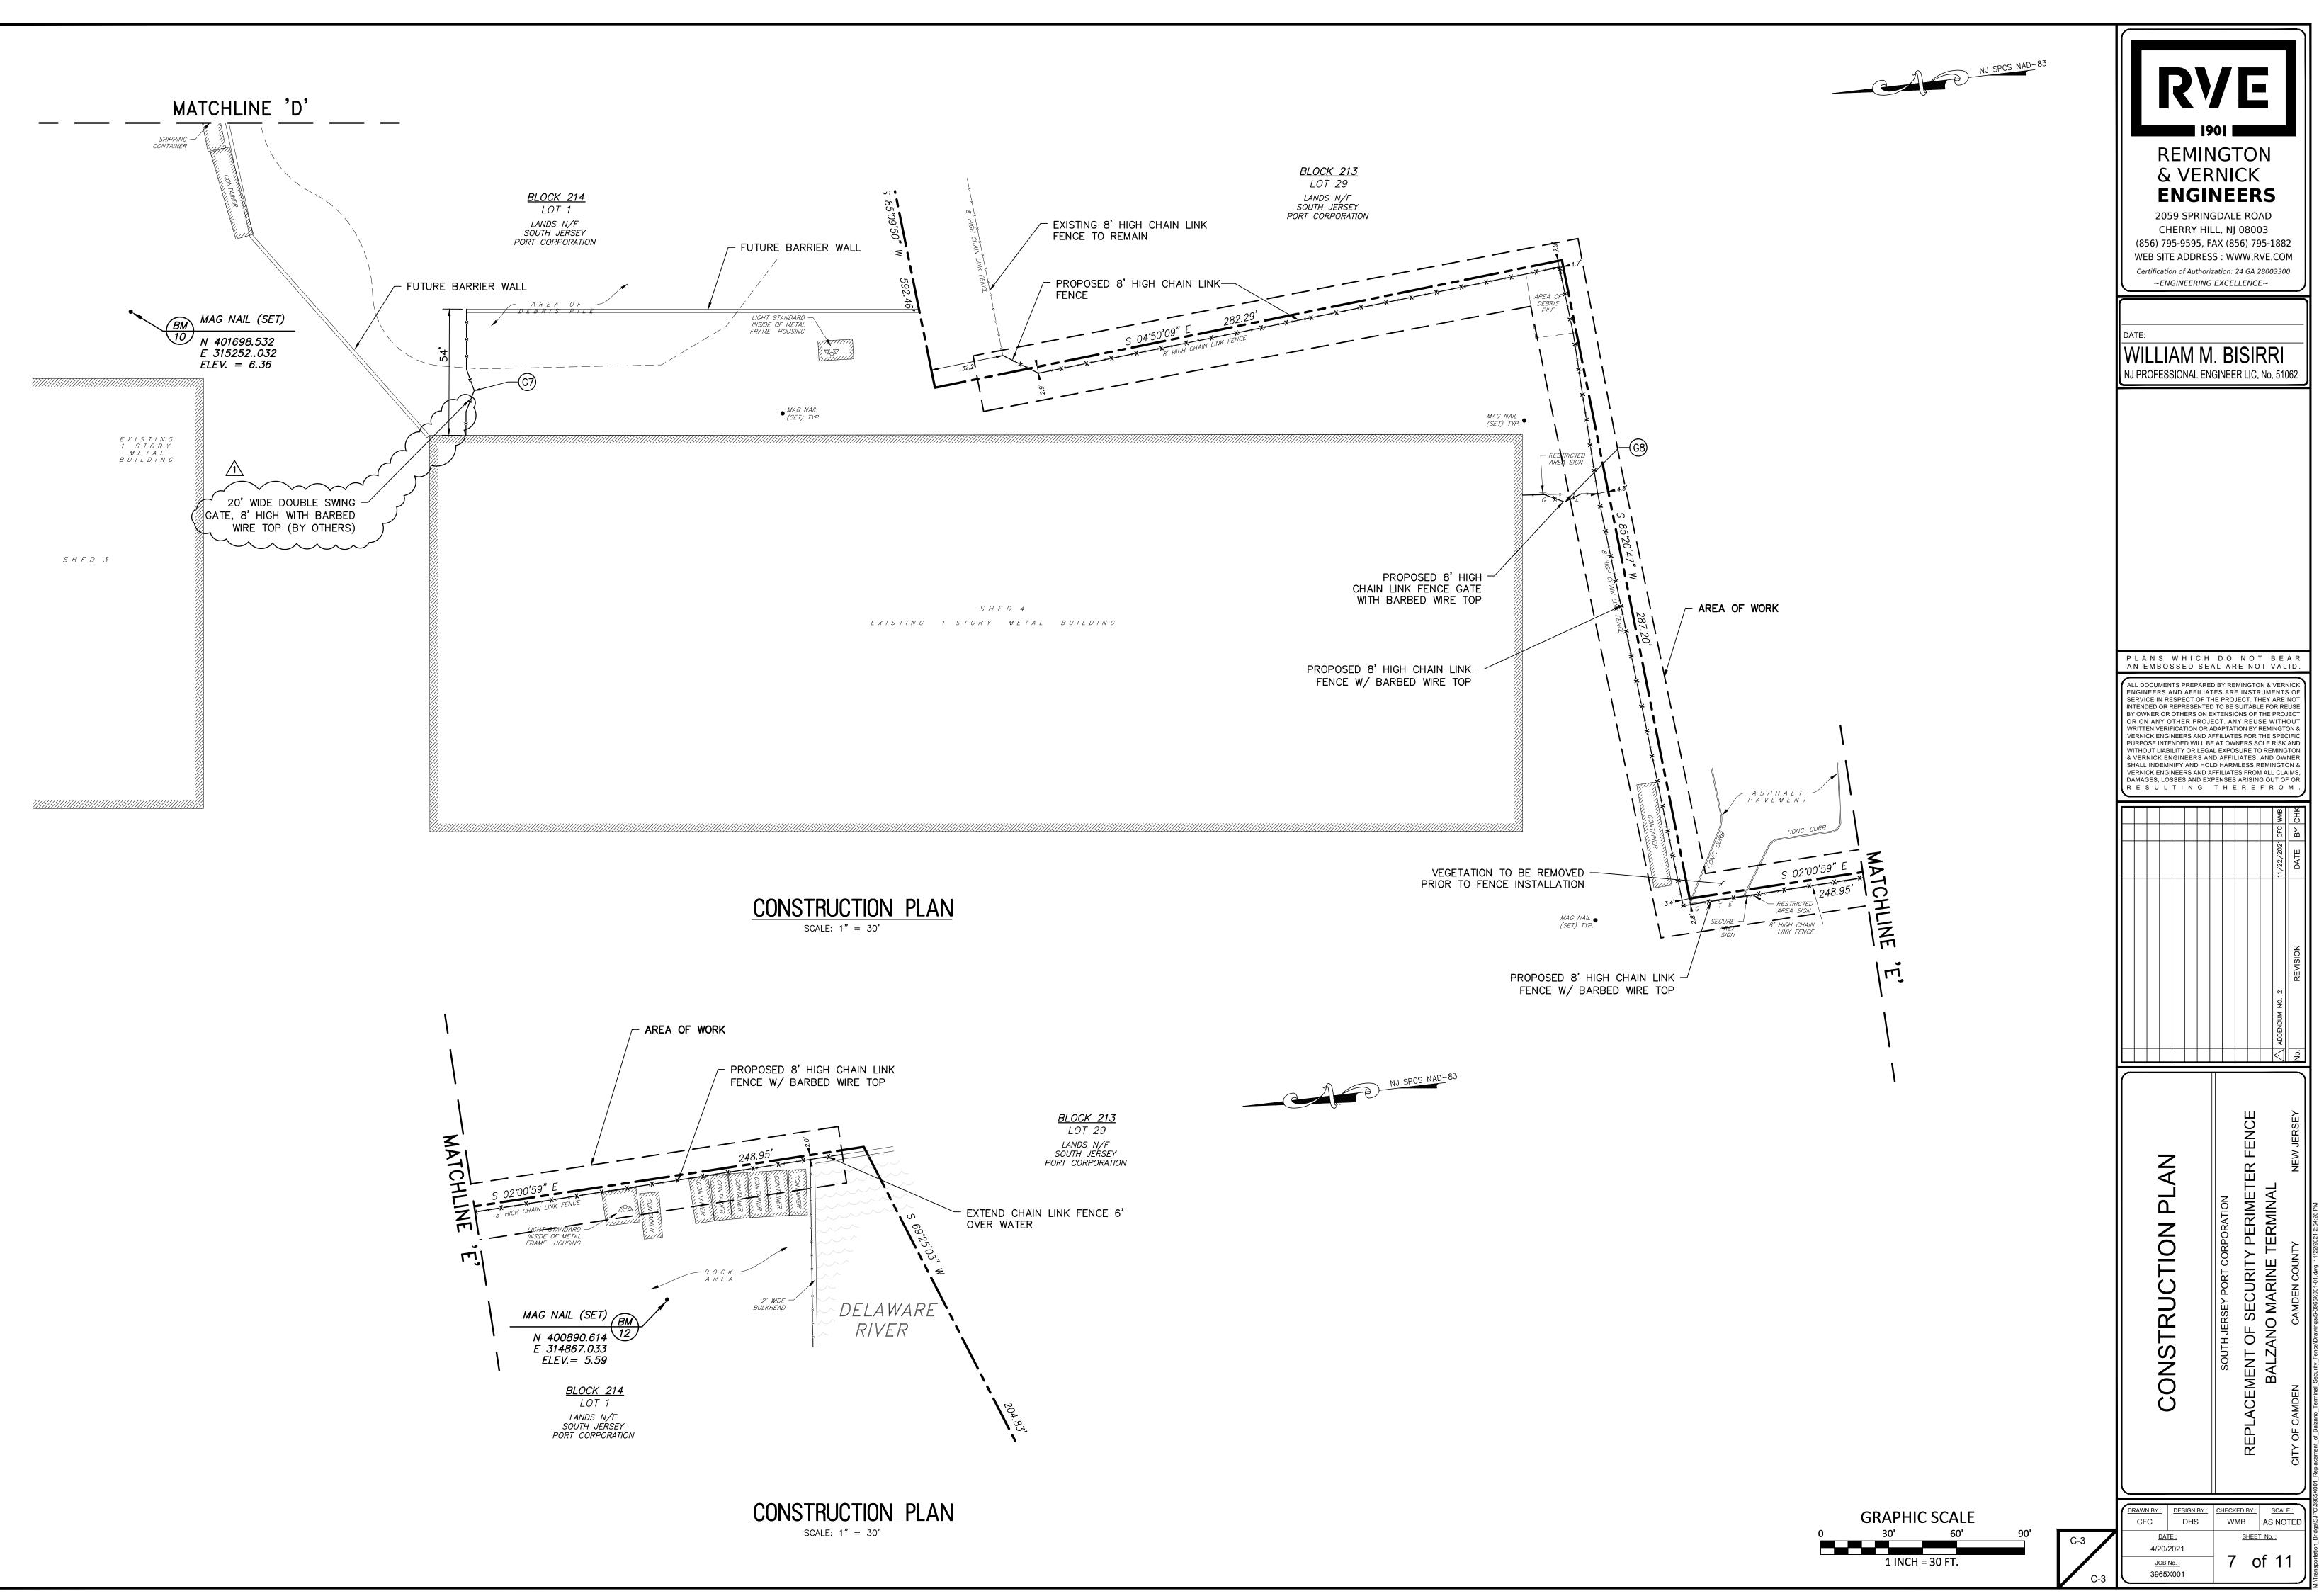


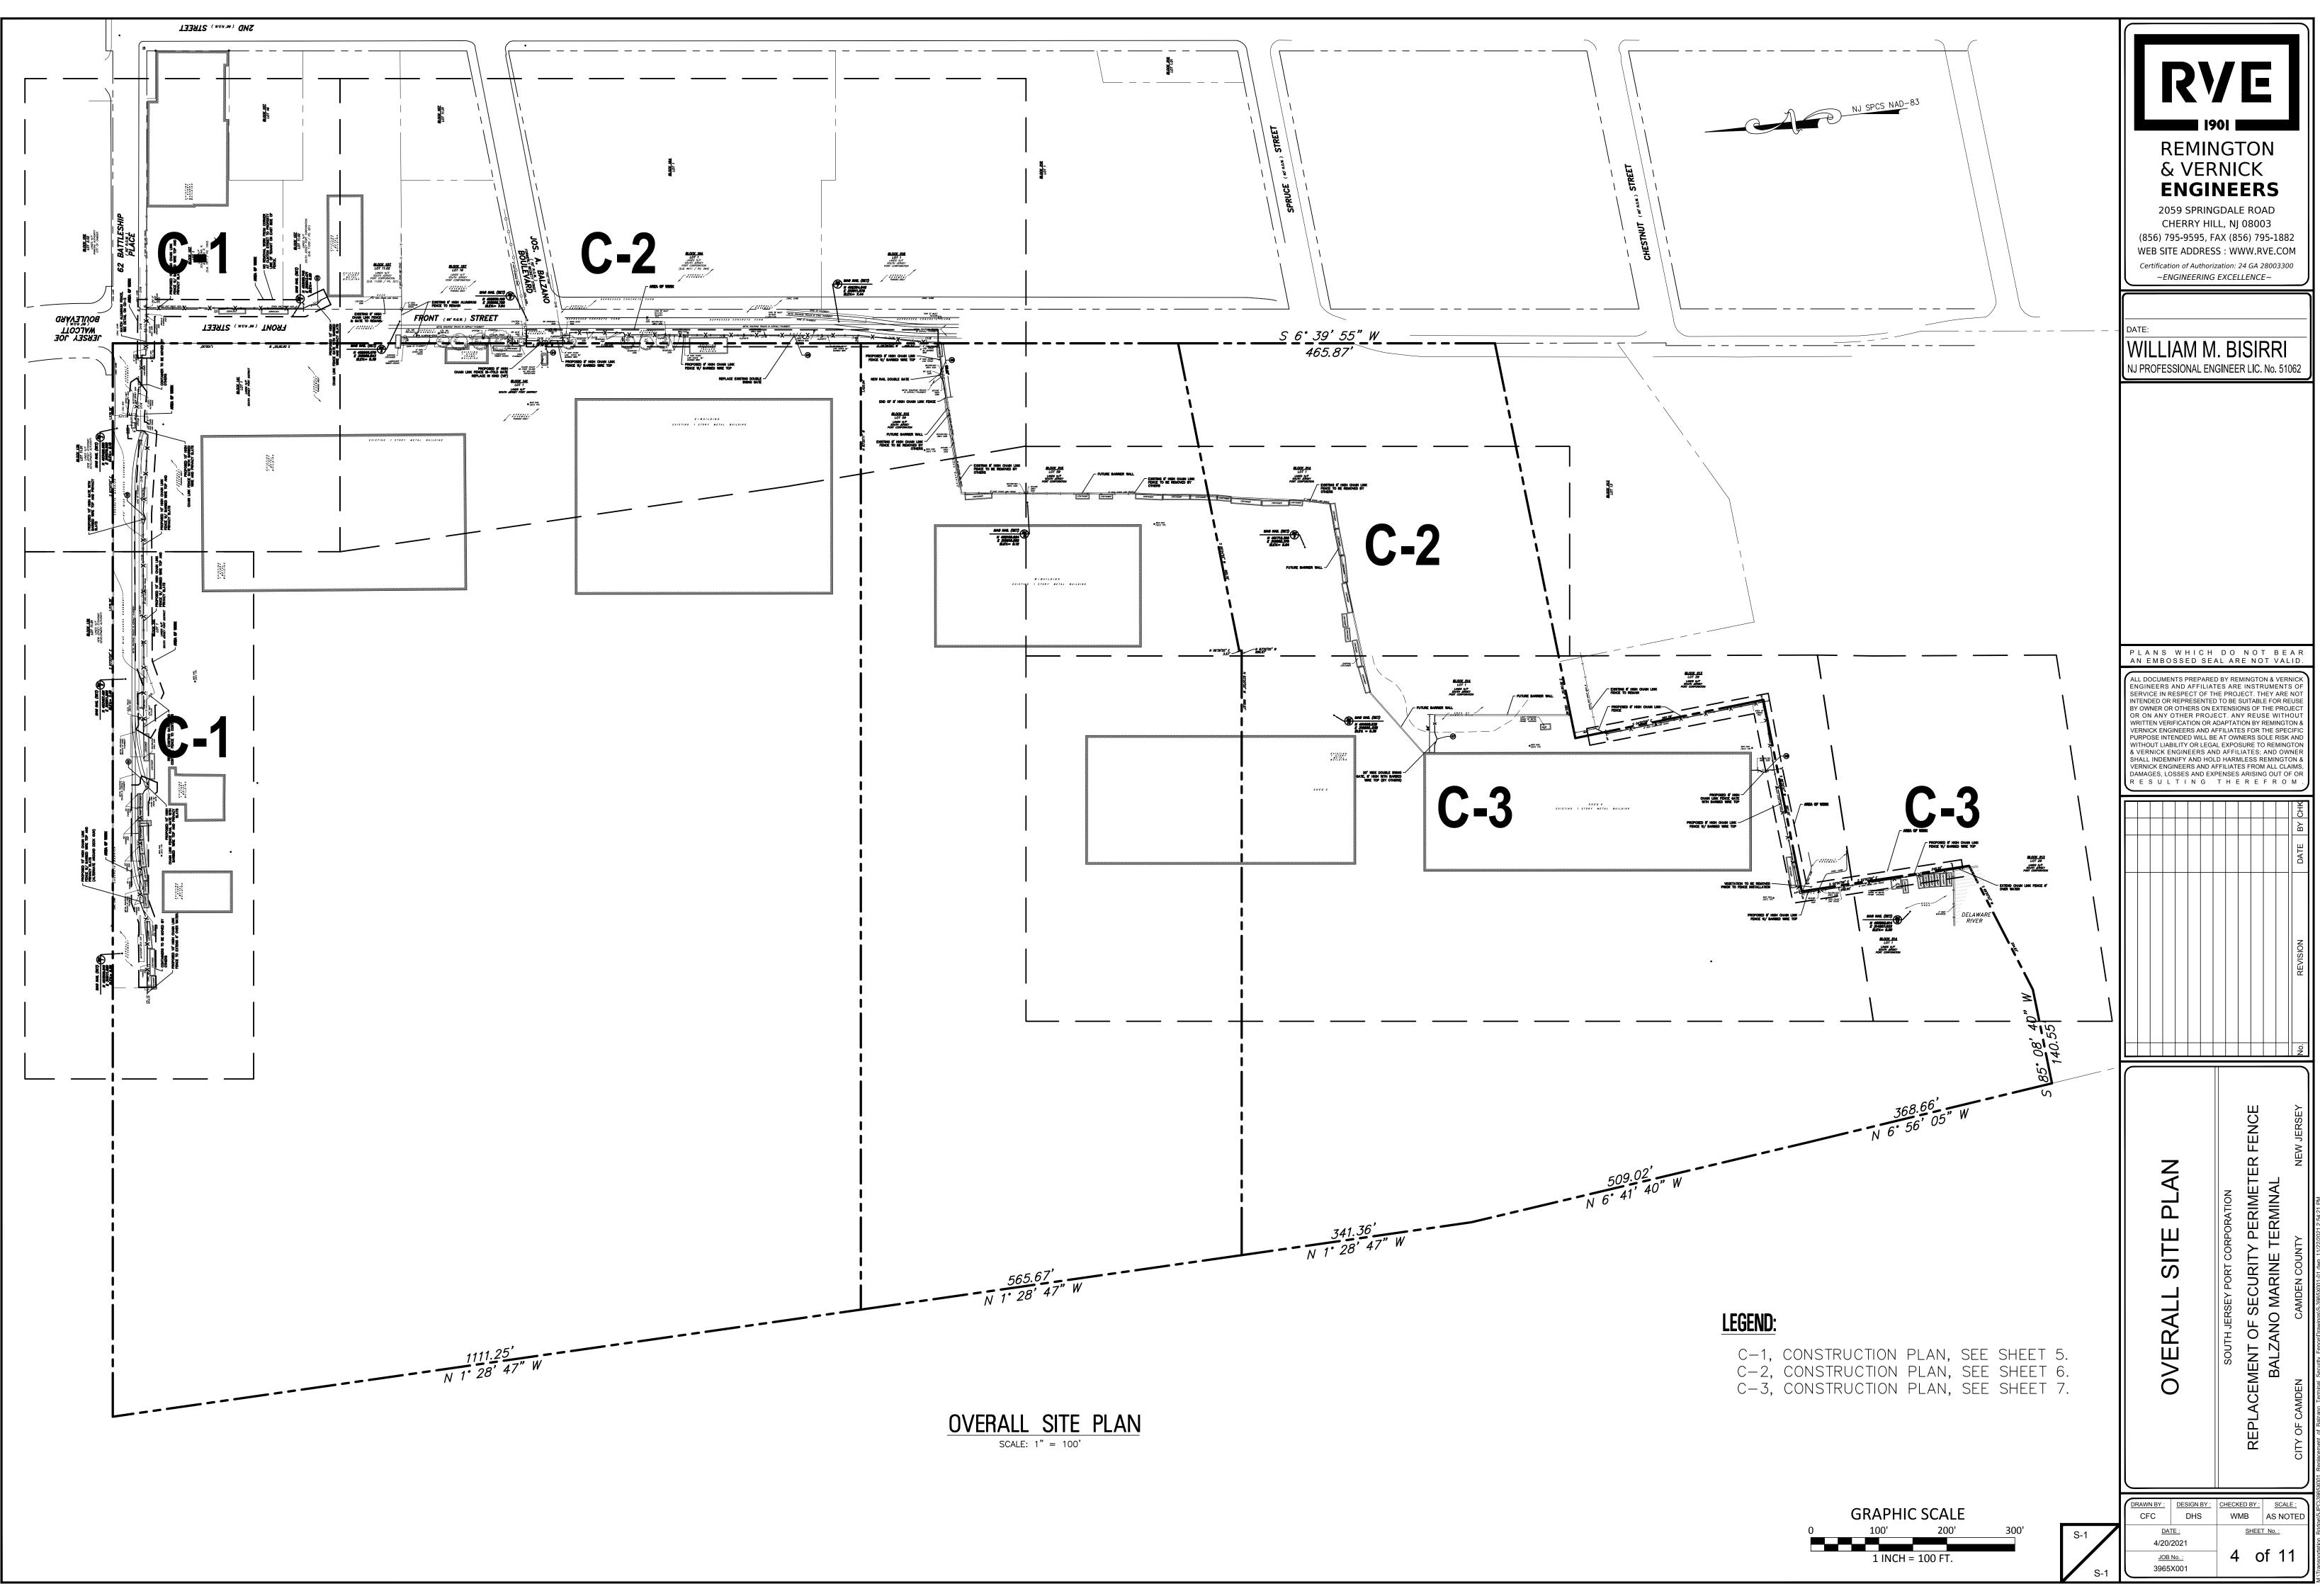
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GRAPHIC SCALE 0 30' 60' 90' 1 INCH = 30 FT.	C-1 C-3	DRAWN BY: DESIGN BY: CFC DHS DATE: 4/20/2021 JOB No.: 3965X001	CHECKED BY : SCALE : WMB AS NOTED SHEET No. : 5 Of 11

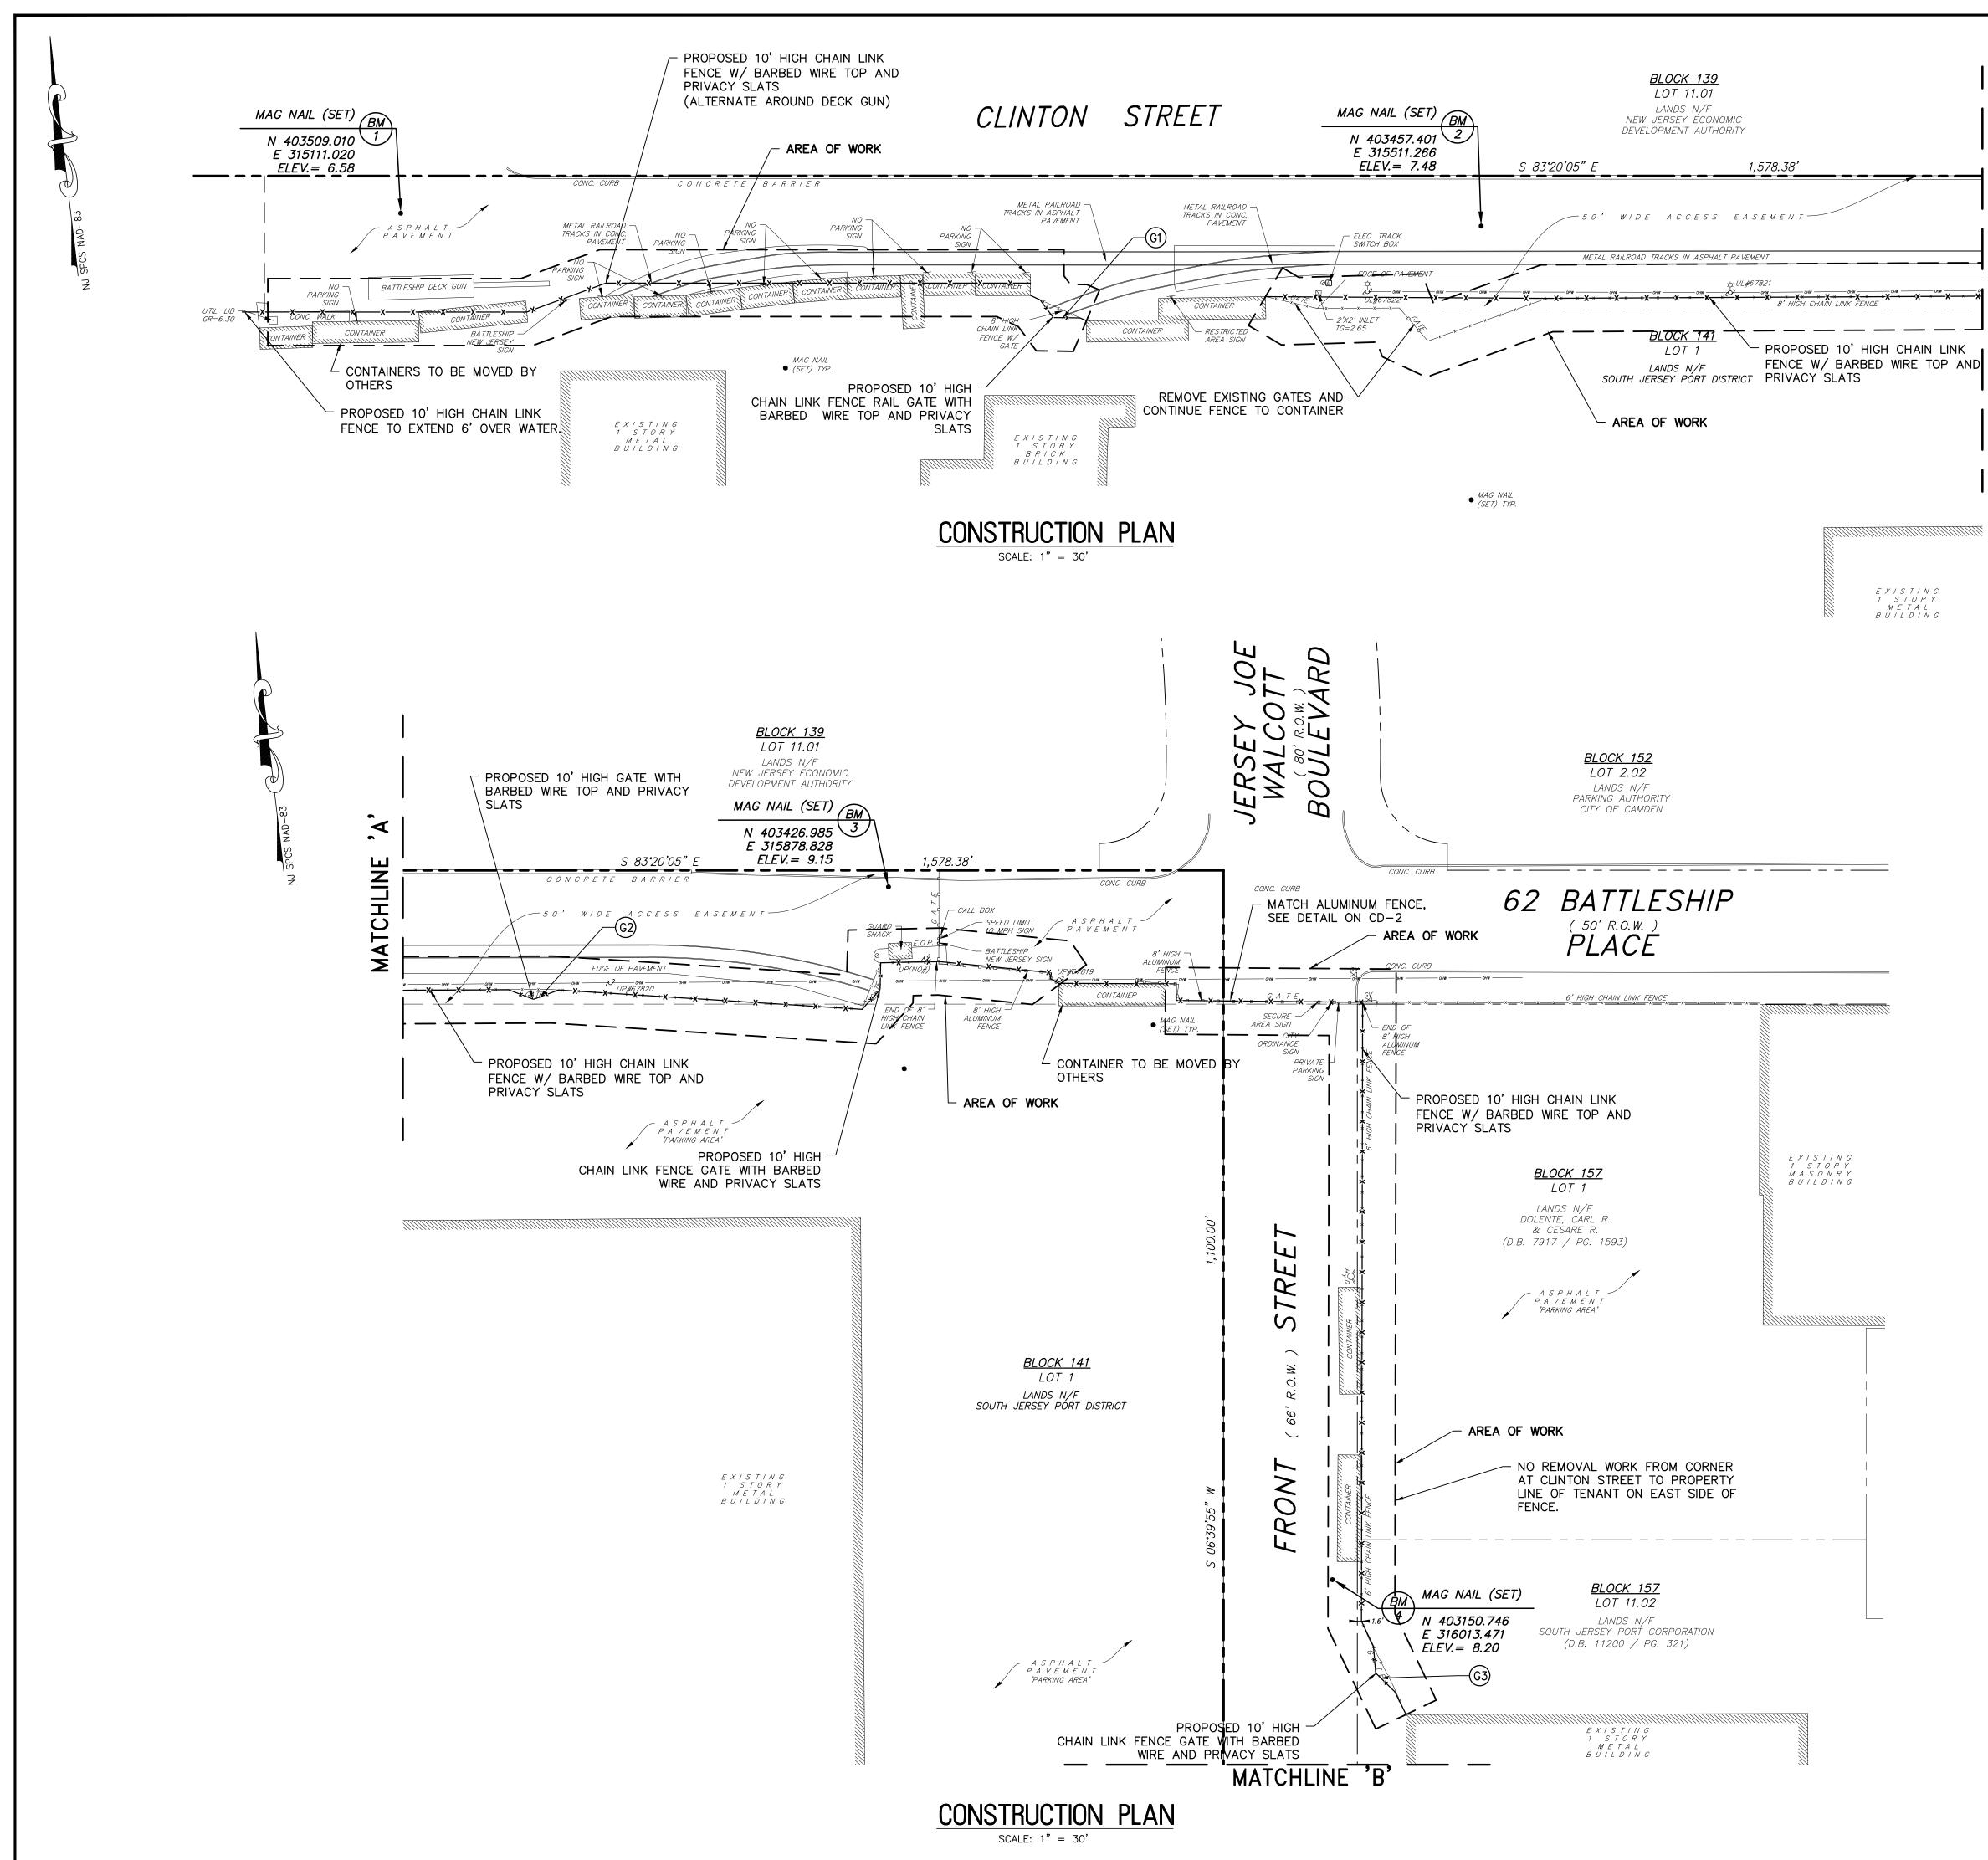
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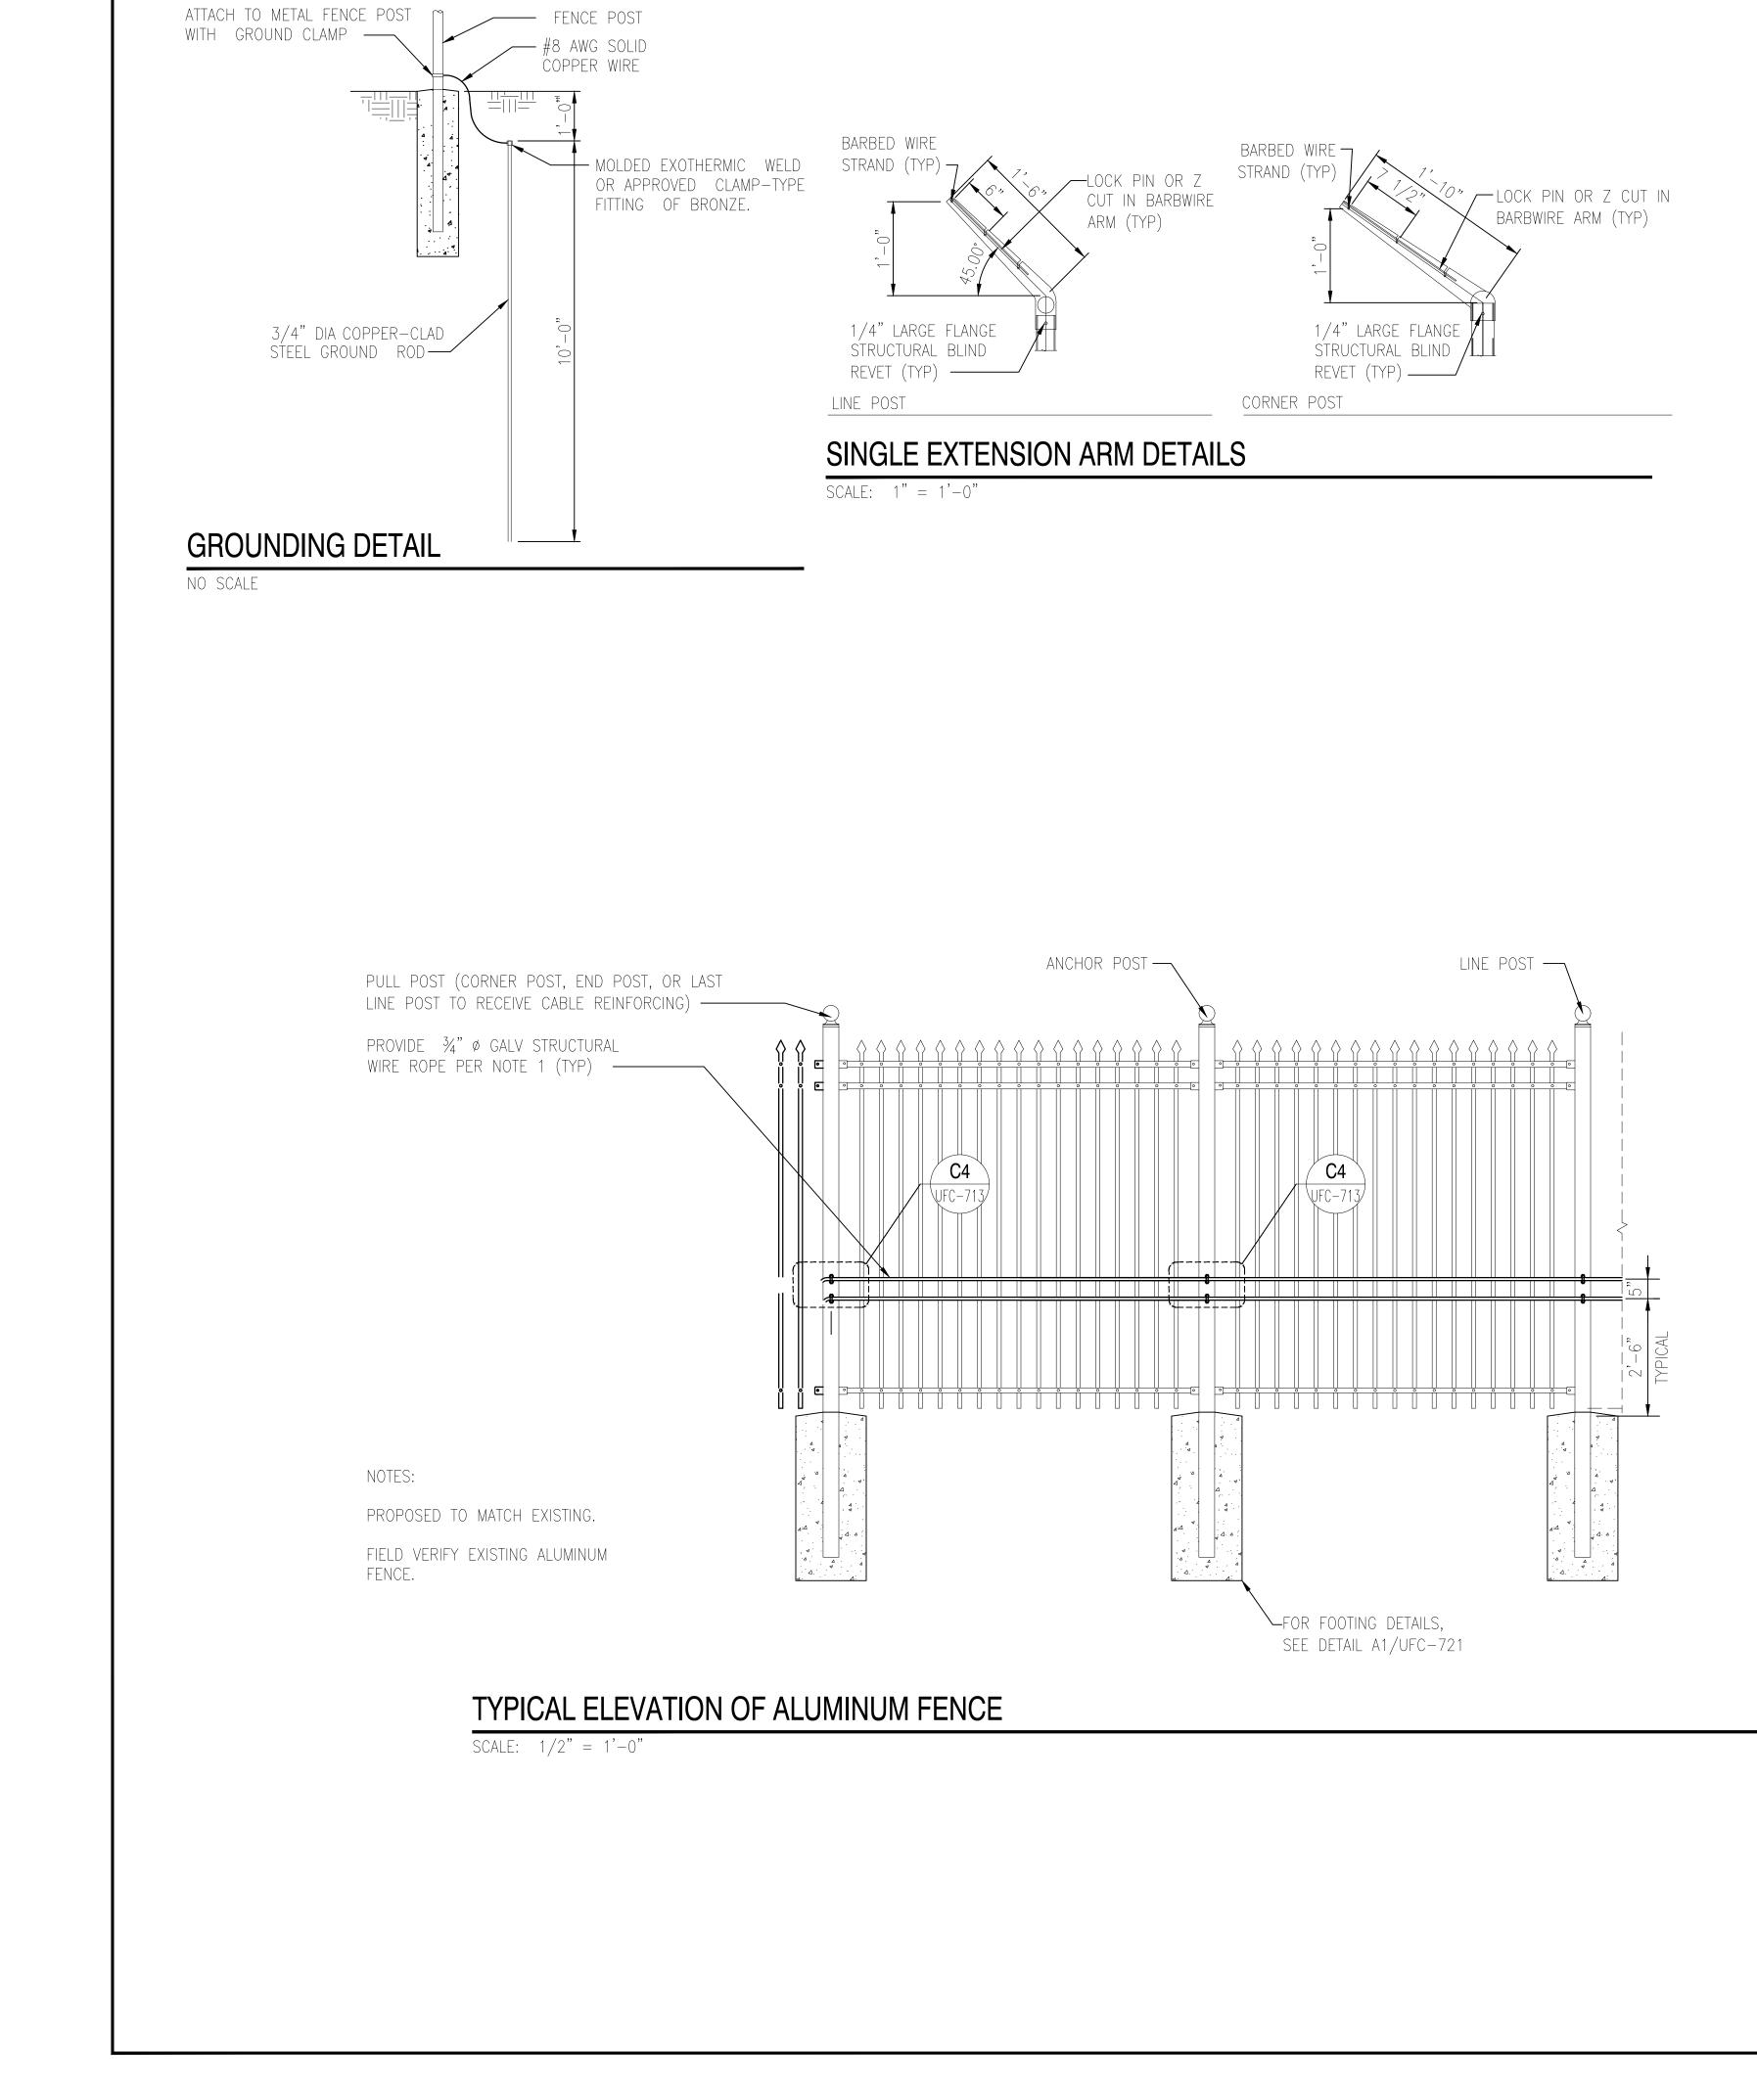


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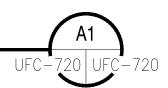




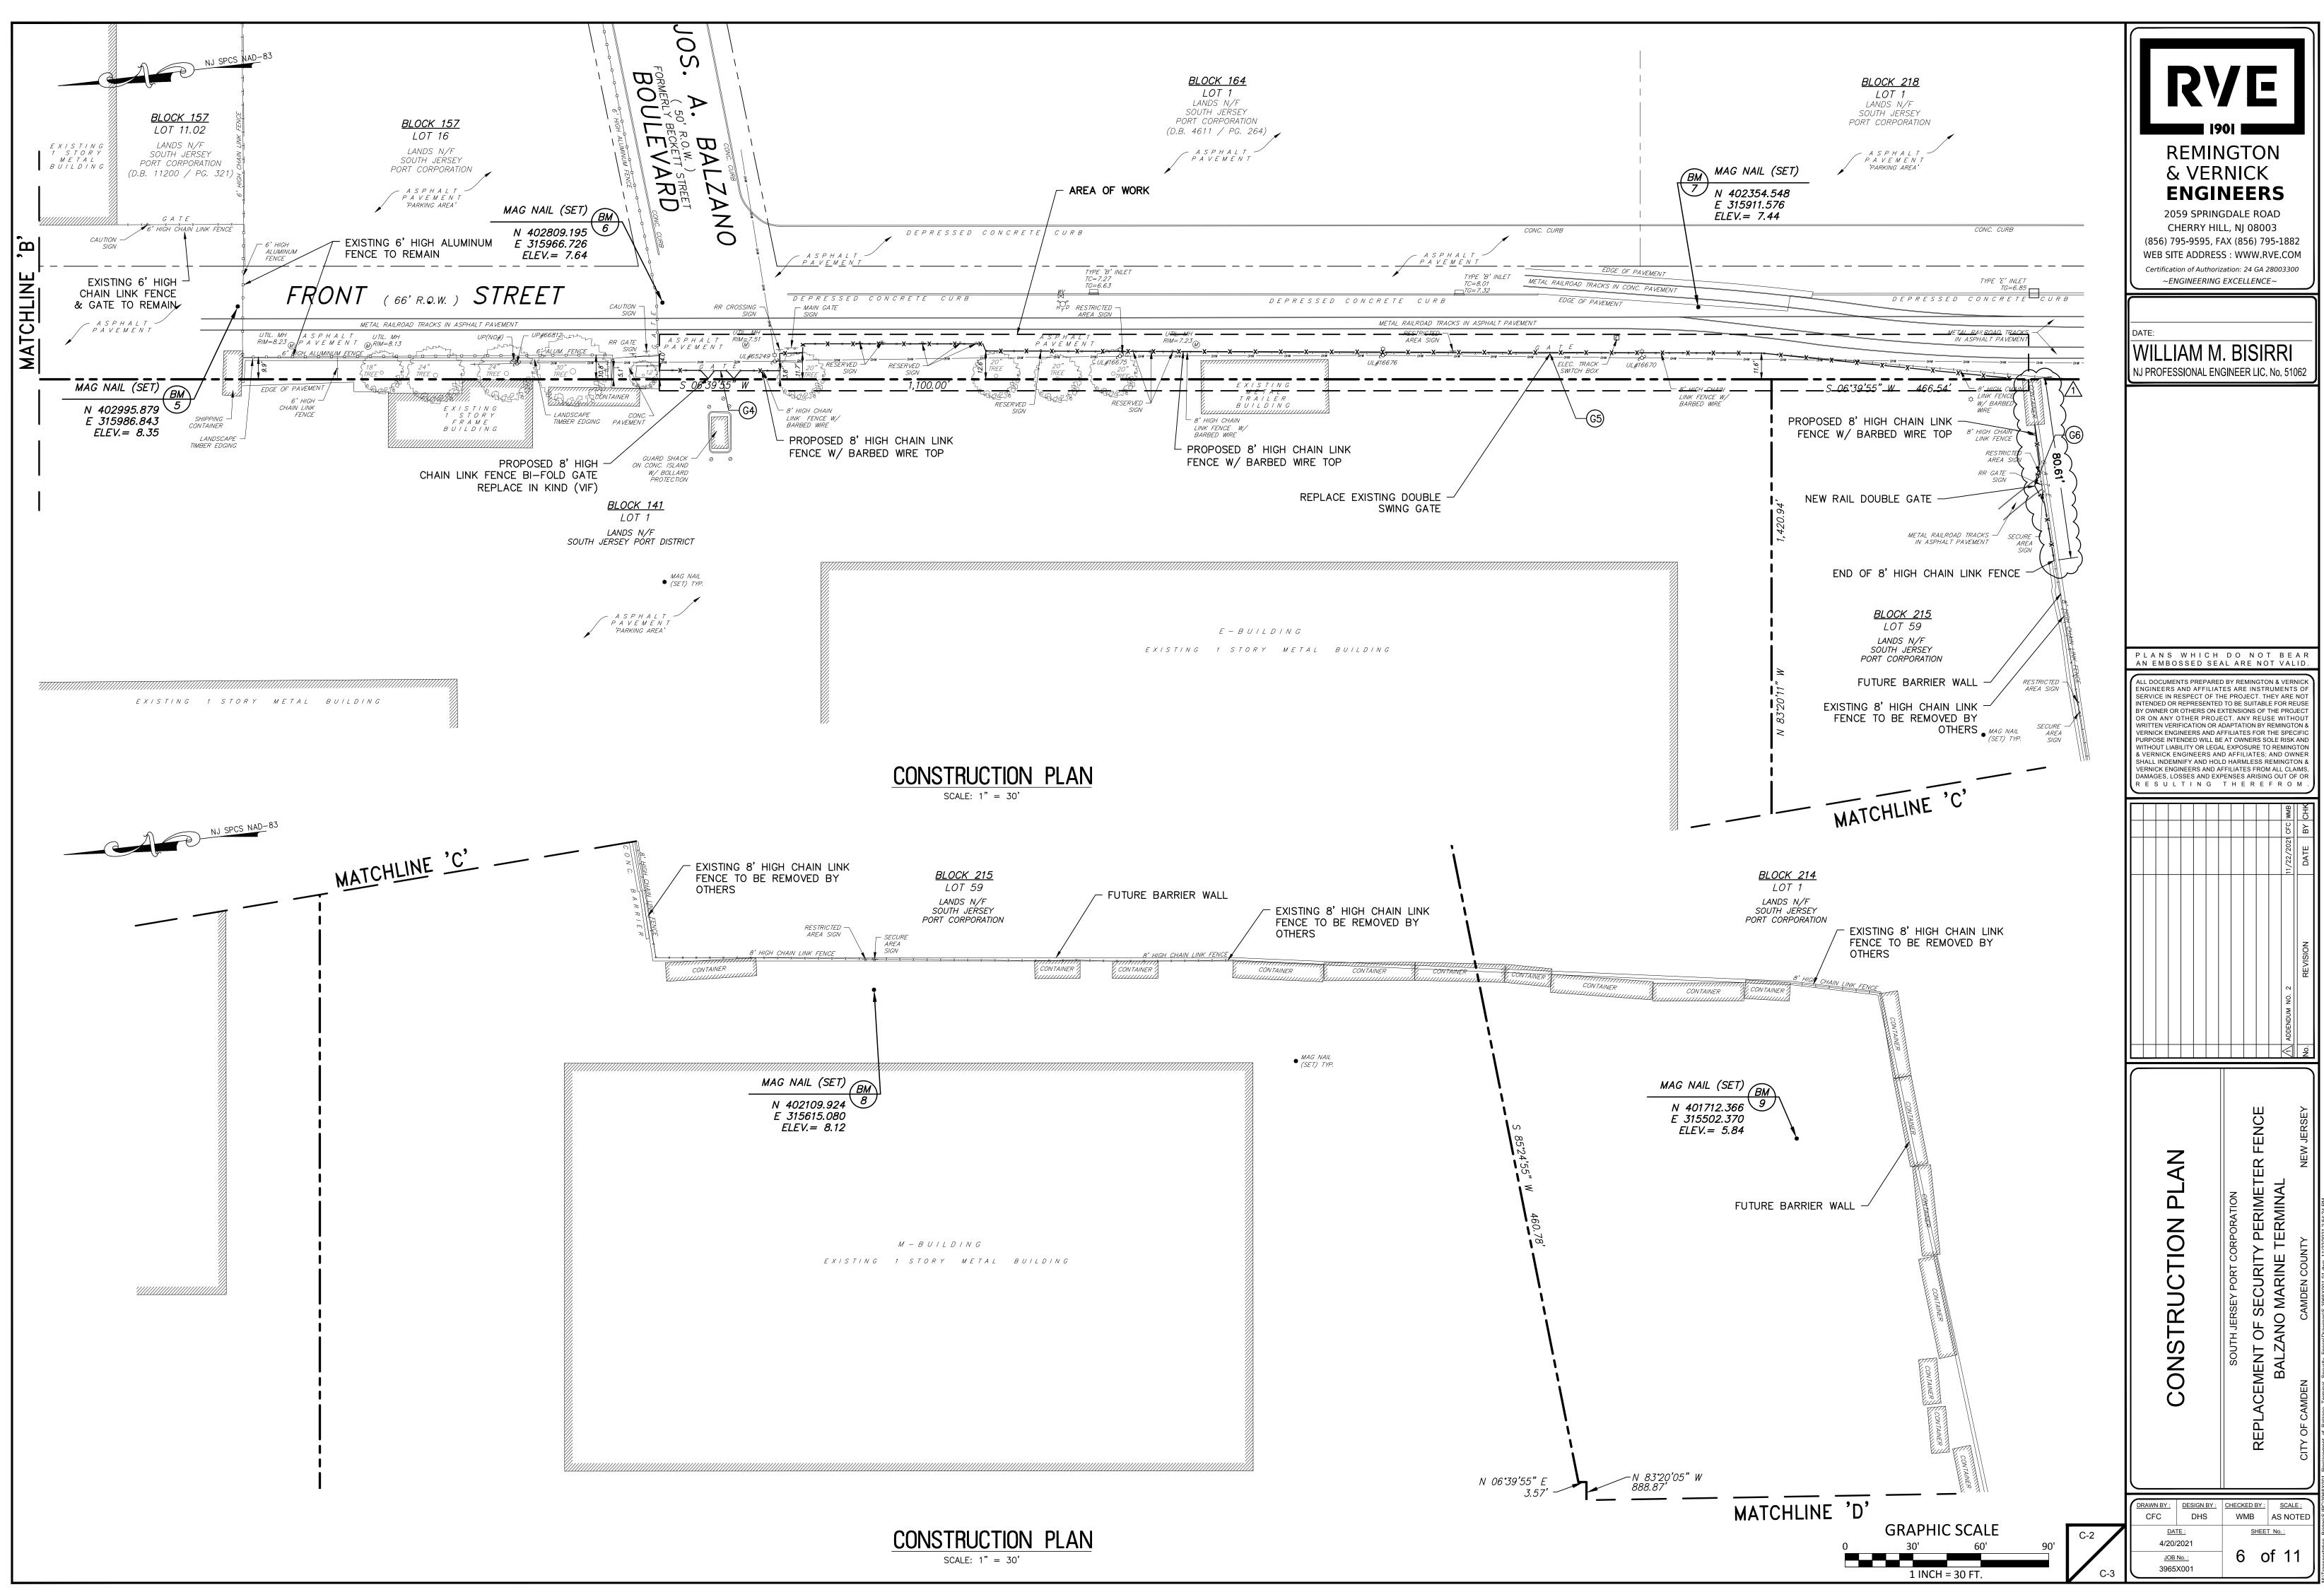


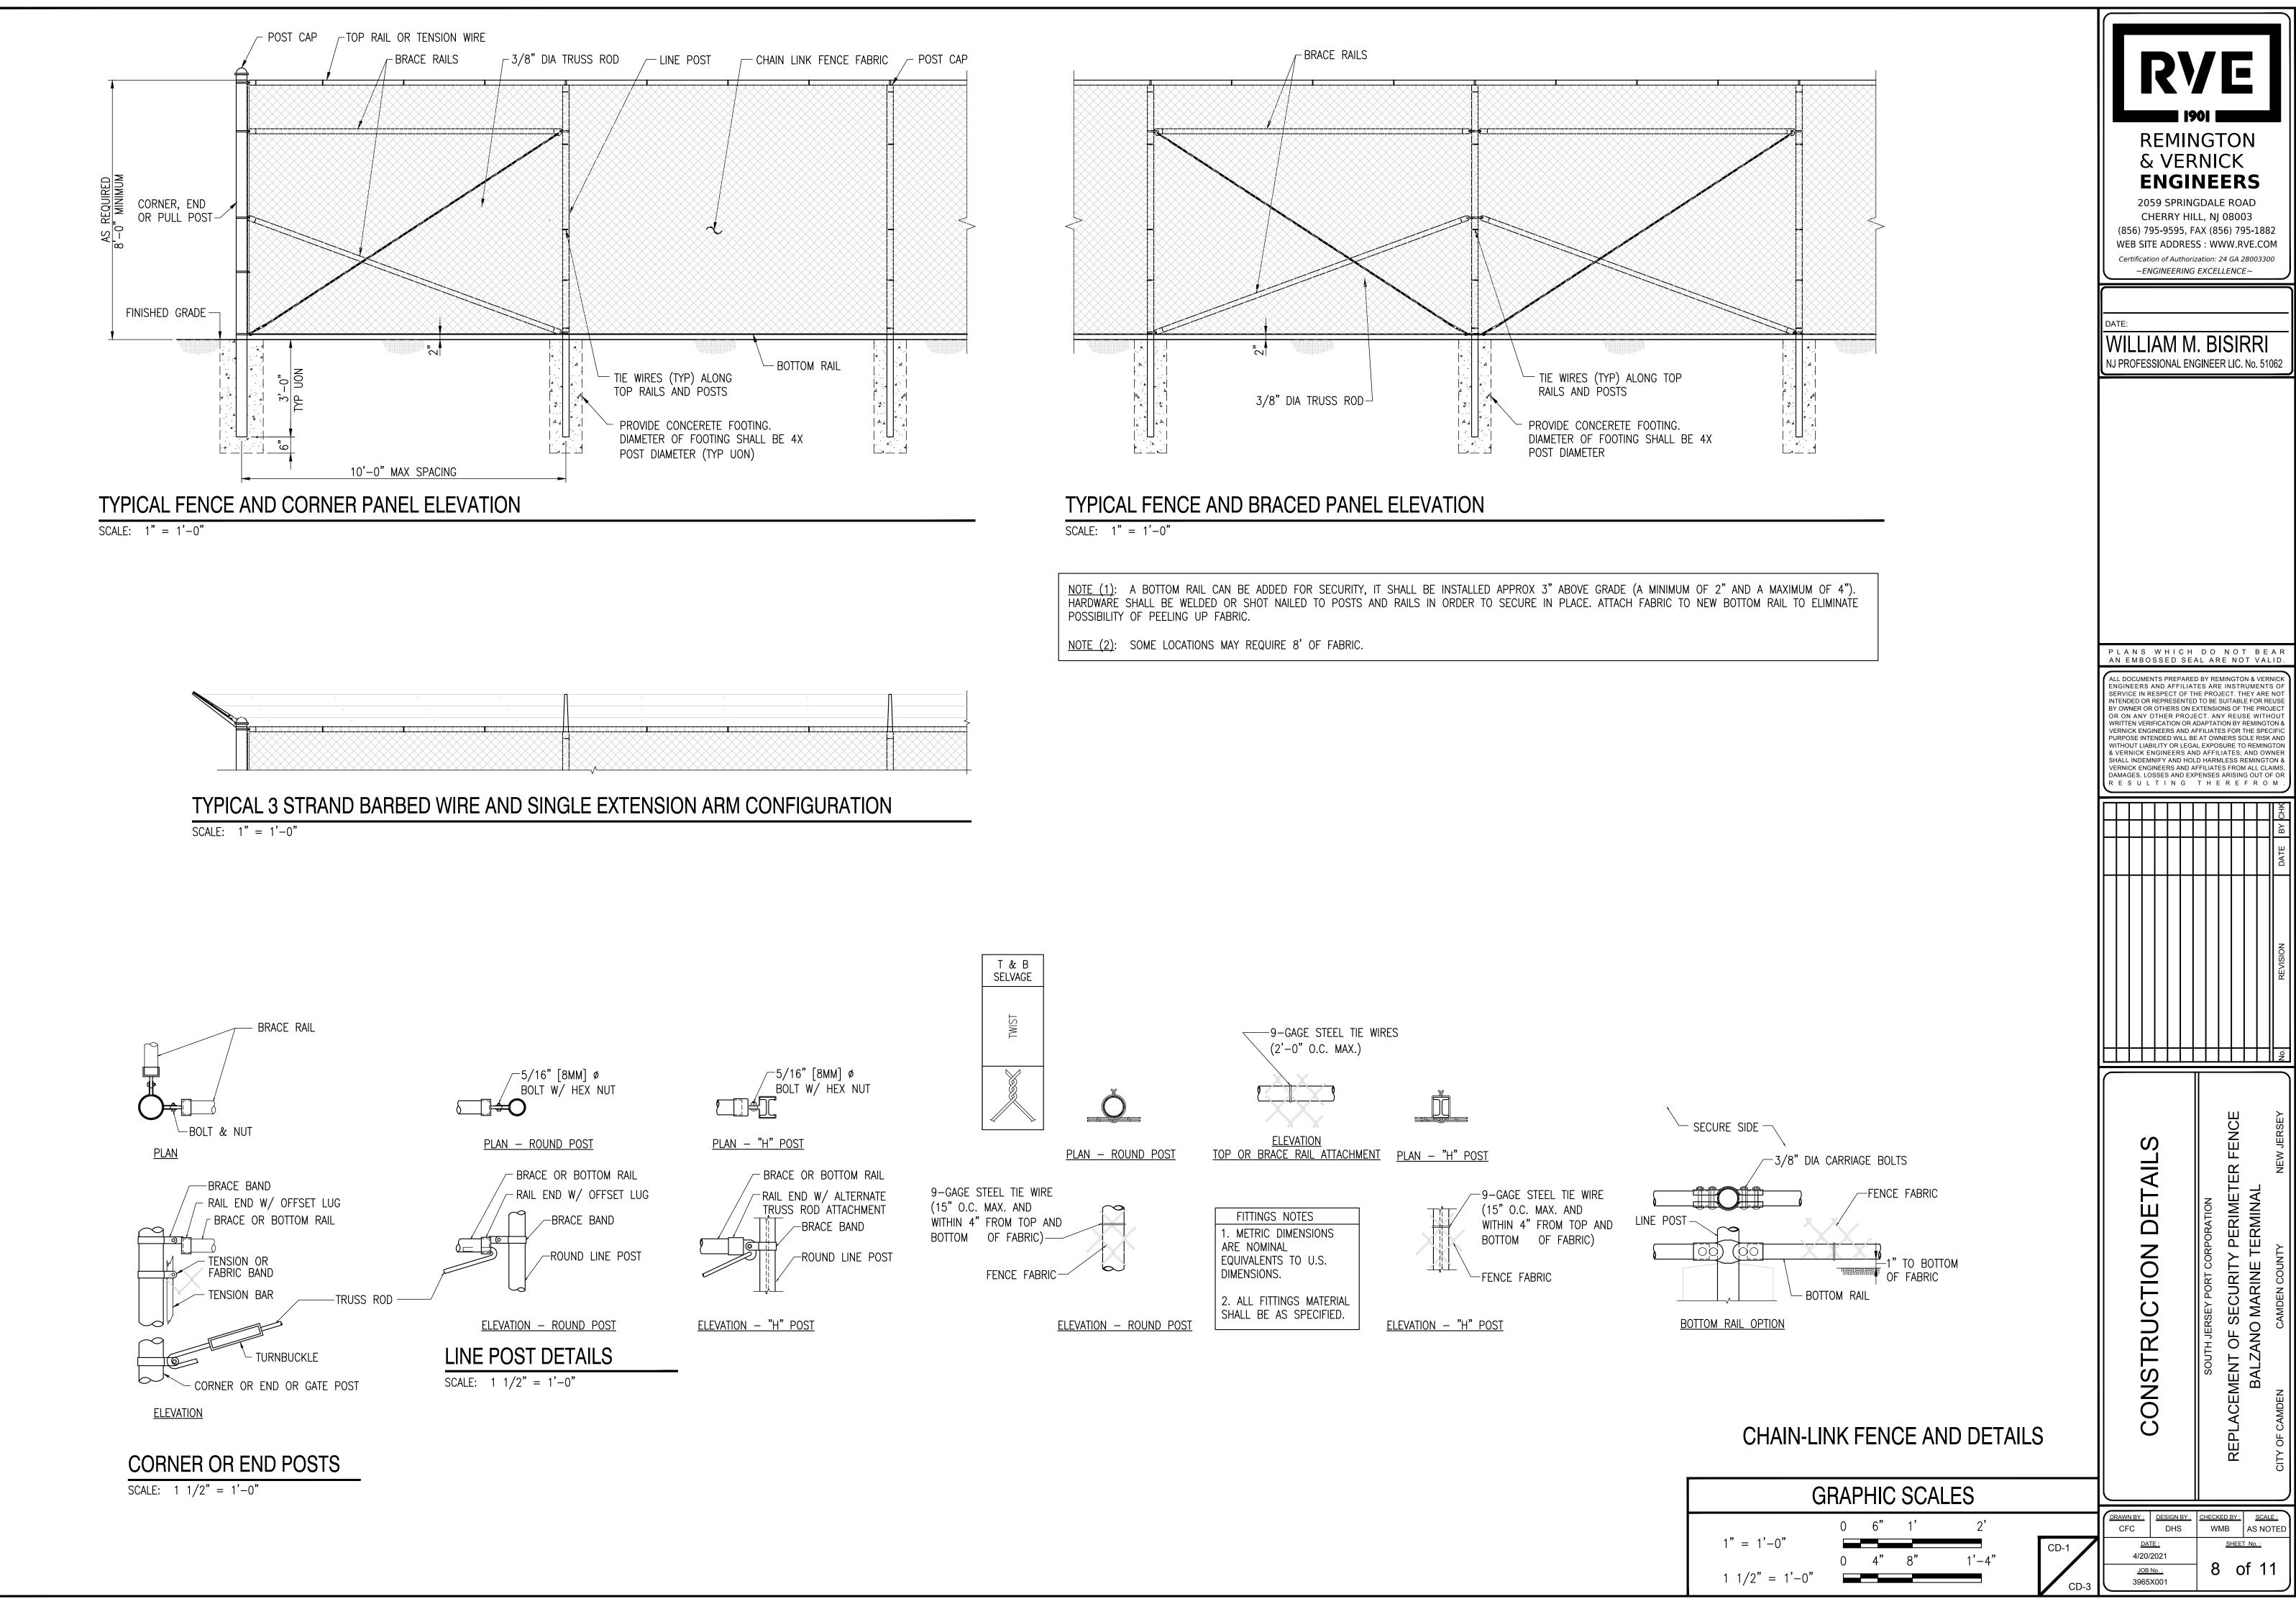

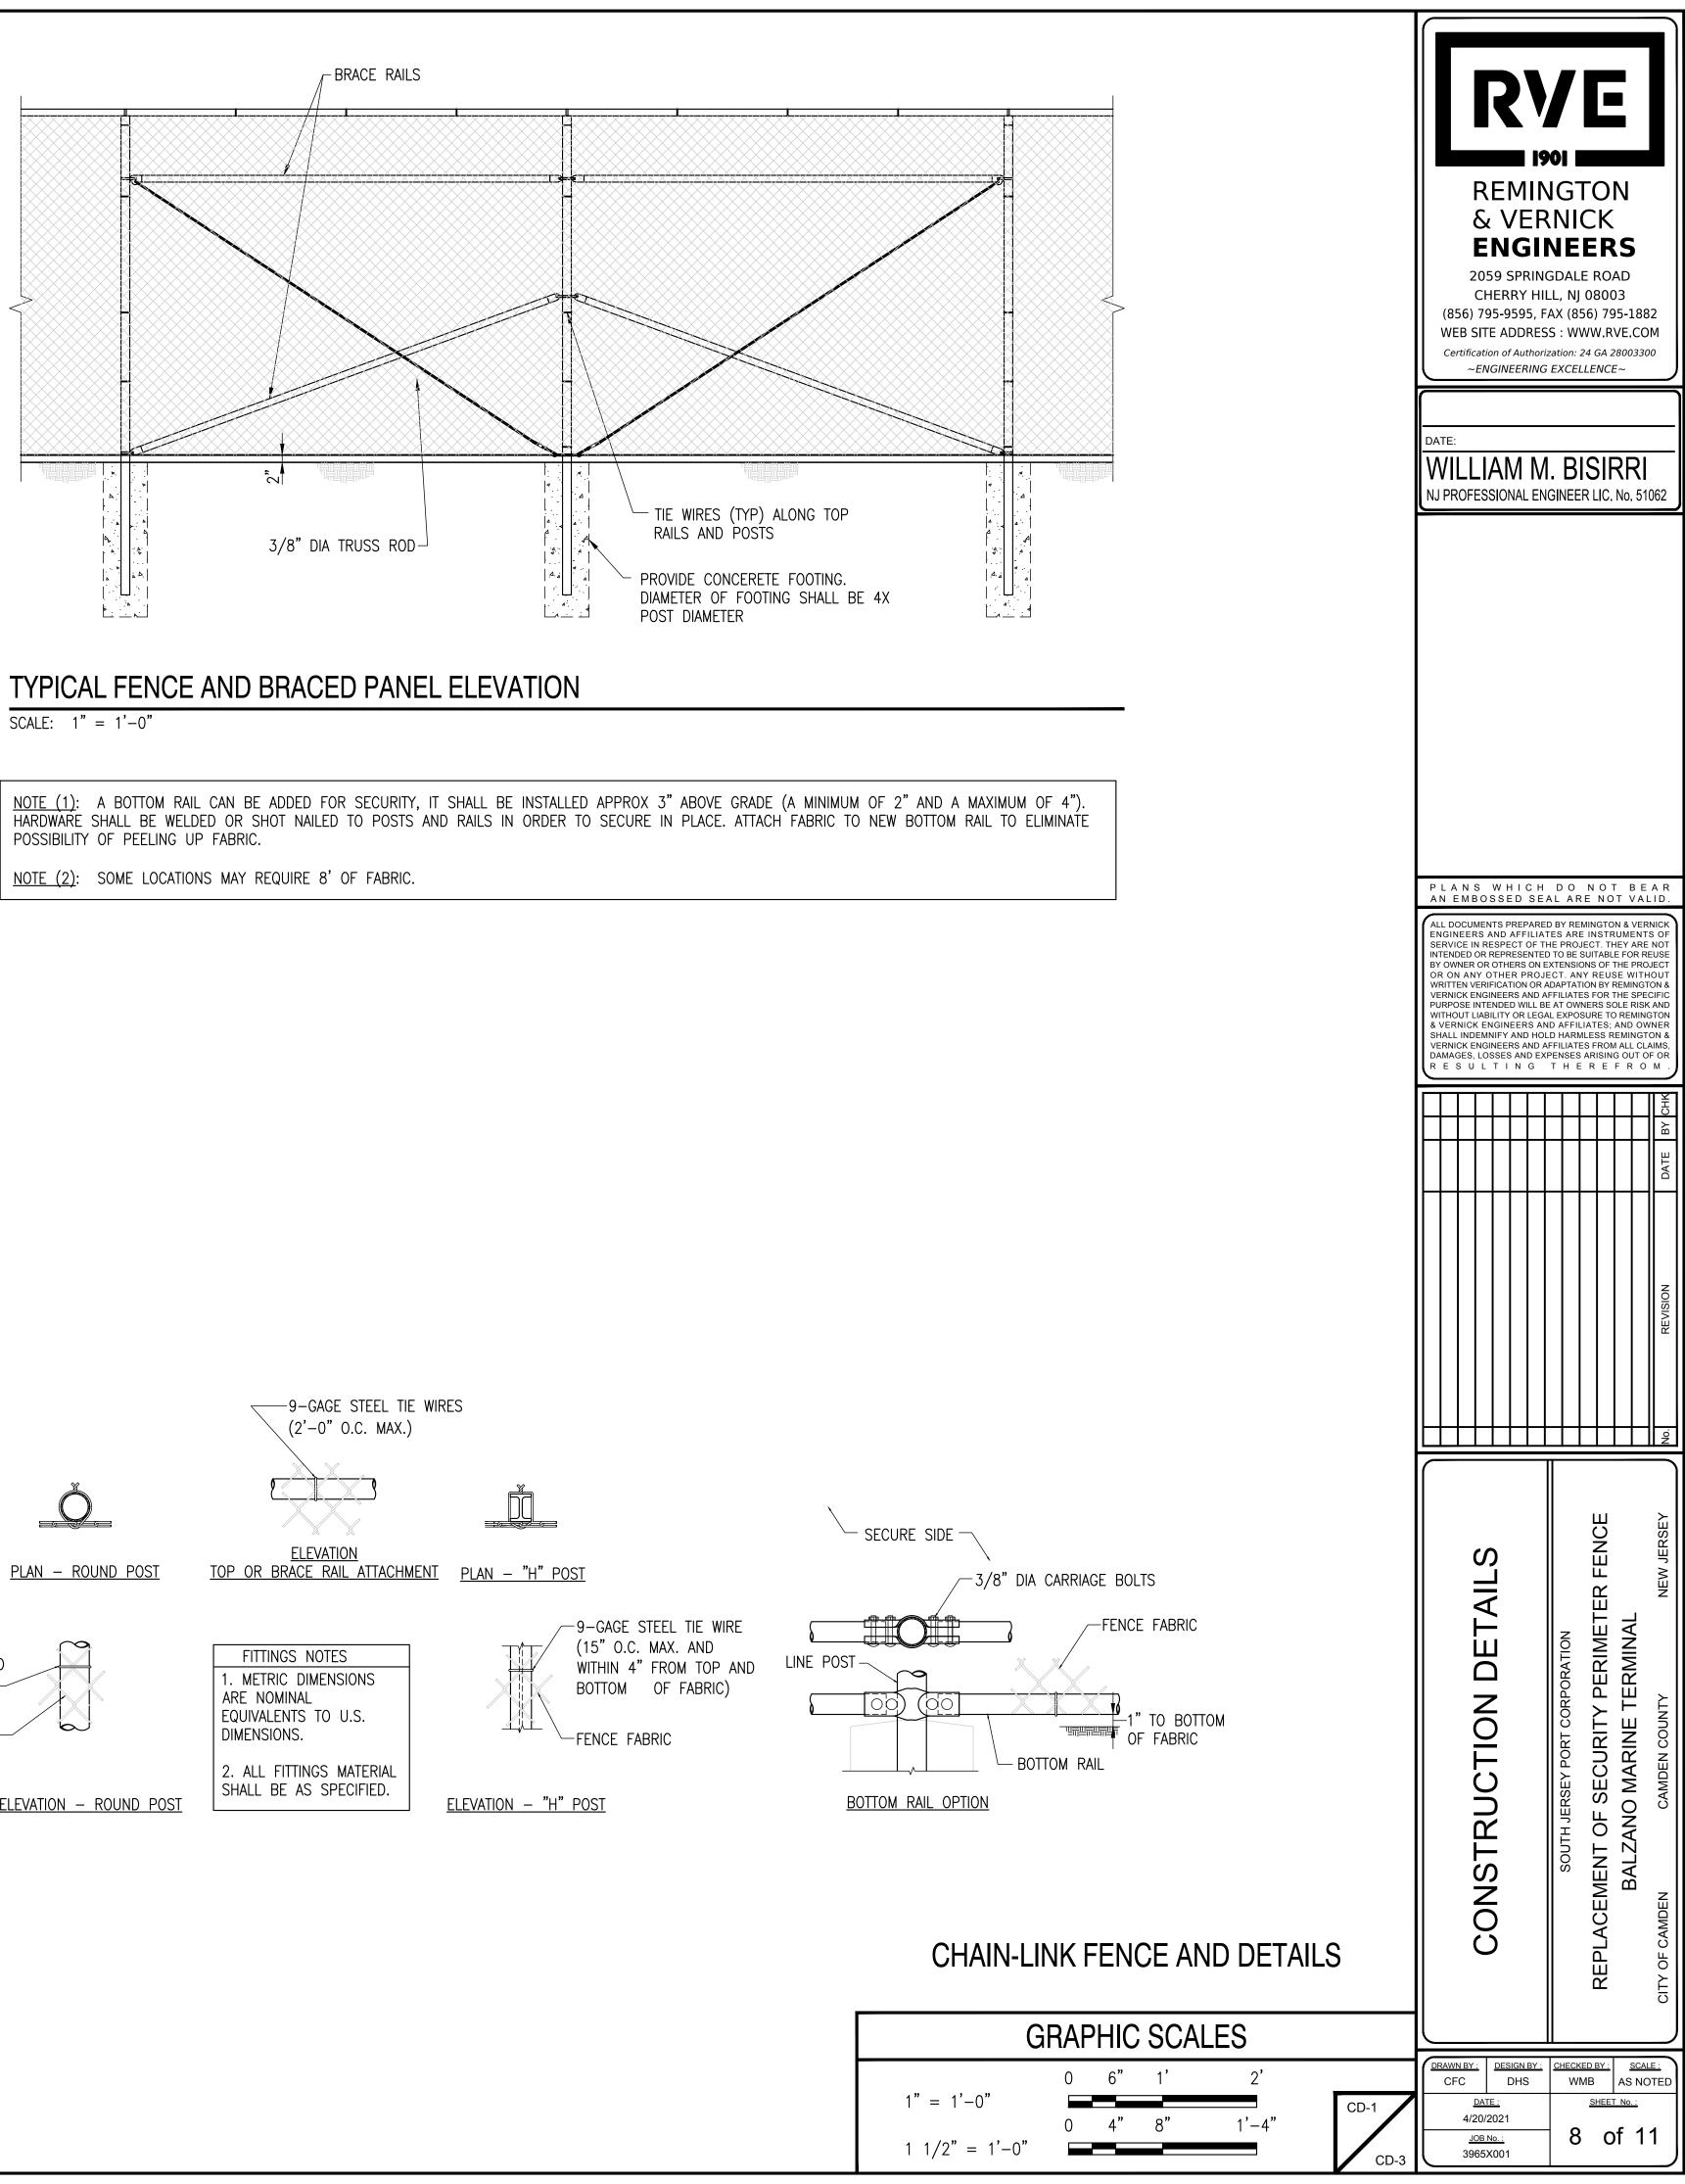
FENCE POST



	REMIN & VER ENGII 2059 SPRING CHERRY HIL (856) 795-9595, F. WEB SITE ADDRES	AGTON NICK NICK NEERS GDALE ROAD L, NJ 08003 AX (856) 795-1882 S : WWW.RVE.COM zation: 24 GA 28003300 EXCELLENCE~
	AN EMBOSSED SEA ALL DOCUMENTS PREPARED ENGINEERS AND AFFILIAT SERVICE IN RESPECT OF TH INTENDED OR REPRESENTED BY OWNER OR OTHERS ON E OR ON ANY OTHER PROJE WRITTEN VERIFICATION OR A VERNICK ENGINEERS AND A PURPOSE INTENDED WILL BE WITHOUT LIABILITY OR LEGA & VERNICK ENGINEERS AND SHALL INDEMNIFY AND HOL VERNICK ENGINEERS AND A	D O N O T B E A R AL ARE NOT VALID. DBY REMINGTON & VERNICK FES ARE INSTRUMENTS OF TE PROJECT. THEY ARE NOT D TO BE SUITABLE FOR REUSE XTENSIONS OF THE PROJECT ECT. ANY REUSE WITHOUT DAPTATION BY REMINGTON & FFILIATES FOR THE SPECIFIC EAT OWNERS SOLE RISK AND U EXPOSURE TO REMINGTON & FFILIATES; AND OWNER D AFFILIATES; AND OWNER D AFFILIATES; AND OWNER T H E R E F R O M WHO A B HUND A B
BARBED WIRE ARRANGEMENT DETAILS CHAIN LINK CANTILEVERED GATE DETAILS GRAPHIC SCALES	CONSTRUCTION DETAILS	SOUTH JERSEY PORT CORPORATION REPLACEMENT OF SECURITY PERIMETER FENCE BALZANO MARINE TERMINAL CITY OF CAMDEN CITY OF CAMDEN CONT Replacement_of_Balzano_Terminal_Security_FenceIDrawings/CD-3965X001-01.dwg 11/22/2021 2:54:38 FM
$\begin{array}{c} \text{CD-2} \\ 1 & \text{CD-2} \\ 1 & 1/2 & \text{CD-3} \end{array}$	DRAWN BY: DESIGN BY: CFC DHS DATE: 4/20/2021 JOB No.: 3965X001	CHECKED BY: SCALE : WMB AS NOTED SHEET No. : 9 of 11

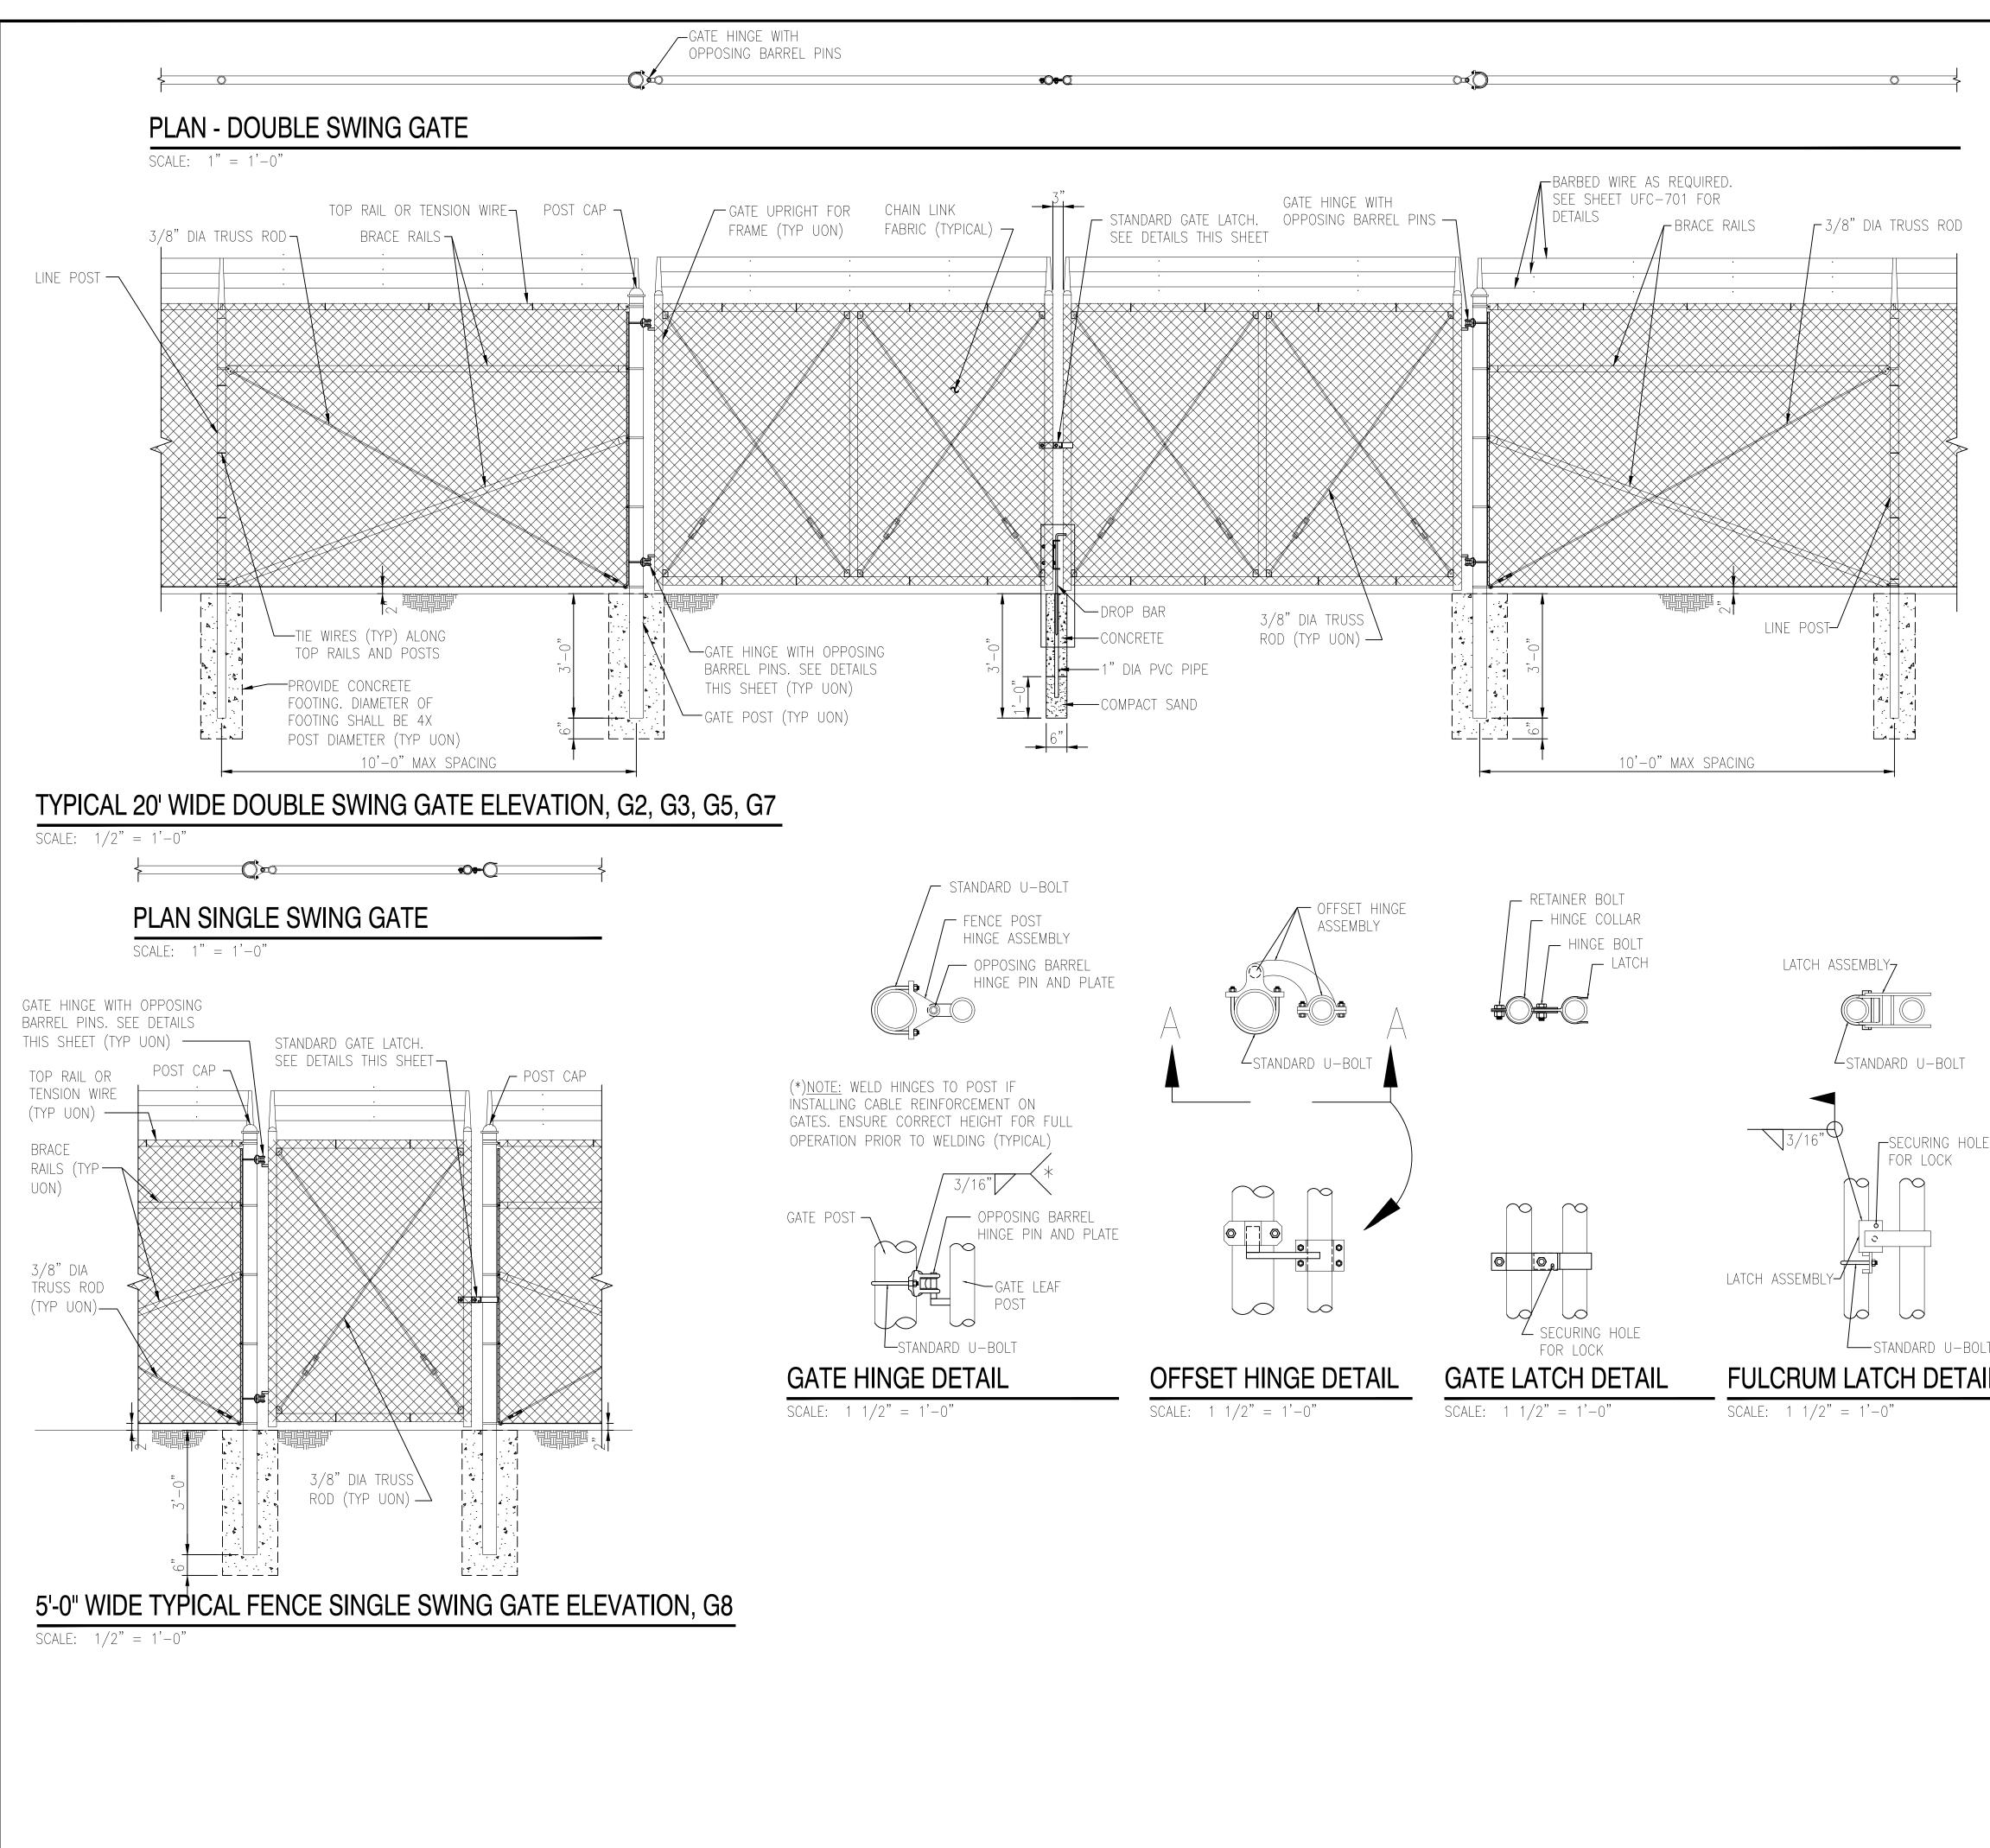

	NOTE: PROVIDE ONE DROP BAR FOR EACH LEAF (TYP). ASSOCIATED GALV SLEEVES TO BE INSTALLED FLUSH WILL GRADE AT FULLY OPEN AND CLOSED POSITIONS. CONTRACTOR SHALL PROVIDE 6" LAYER OF #10 STONE BELOW BOTTOM OF SLEEVE TO ALLOW FOR DRAINAGE.	REMIN & VEP ENGI	/E MGTON NICK NEERS GDALE ROAD
		CHERRY HI (856) 795-9595, F WEB SITE ADDRES	LL, NJ 08003 AX (856) 795-1882 SS : WWW.RVE.COM zation: 24 GA 28003300 EXCELLENCE~
	DETAIL: DROP BAR		
	NOT TO SCALE	AN EMBOSSED SE ALL DOCUMENTS PREPARE ENGINEERS AND AFFILIA' SERVICE IN RESPECT OF T INTENDED OR REPRESENTED BY OWNER OR OTHERS ON E OR ON ANY OTHER PROJ WRITTEN VERIFICATION OR / VERNICK ENGINEERS AND A PURPOSE INTENDED WILL B WITHOUT LIABILITY OR LEG/ & VERNICK ENGINEERS AN	D O N O T B E A R AL ARE NOT VALID. D BY REMINGTON & VERNICK TES ARE INSTRUMENTS OF HE PROJECT. THEY ARE NOT D TO BE SUITABLE FOR REUSE EXTENSIONS OF THE PROJECT ECT. ANY REUSE WITHOUT ADAPTATION BY REMINGTON & FFILIATES FOR THE SPECIFIC E AT OWNERS SOLE RISK AND AL EXPOSURE TO REMINGTON AD AFFILIATES; AND OWNER
	SINGLE OR DOUBLE LEAF GATESNOM HEIGHT (H)UPRIGHT HT (U)FRAME HT (F)NOM HT INCLUDING BARBED WIREACTUAL DIMACTUAL DIM8'-0" [2438MM]7'-10" [2388MM]6'-8 1/2" [2045MM]	VERNICK ENGINEERS AND A	LD HARMLESS REMINGTON & FFILIATES FROM ALL CLAIMS, PENSES ARISING OUT OF OR T H E R E F R O M . H H H H H H H H H H H H H H H H H H H
Ē	SINGLE LEAF GATESOPENINGGATE POSTSHINGE SPACE (S)FACE TO FACESQUARE & ROUND SIZESPOST TO UPRIGHT3'-0" [914MM] THROUGH2.5"[63.5MM]SQ x 3/16"TH ORFOR SQUARE & ROUND GATE POSTS: 2 1/4" [57MM]6'-0" [1829MM]2.875" [73MM] OD2 1/4" [57MM]6'-0" [1829MM]4" [102MM] SQ x 3/16"TH OR THROUGH THROUGHFOR SQUARE & ROUND GATE POSTS: 2 1/4" [57MM]12'-0" [3657MM]4" [102MM] OD2 1/4" [57MM]		No.
_⊤ IL —	12'-0" [3657MM] THROUGH6" [153MM] SQ x 3/16"TH ORFOR SQUARE & ROUND GATE POSTS: 2 1/4" [57MM]19'-0" [5790MM] THROUGH6.625" [168MM] OD2 1/4" [57MM]19'-0" [5790MM] THROUGH8" [203MM] SQ x 1/4"TH OR ORFOR SQUARE & ROUND GATE POSTS: 2 1/4" [57MM]23'-0" [7010MM]8" [203MM] SQ x 1/4"TH OR S.625" [219MM] ODFOR SQUARE & ROUND GATE POSTS: 2 1/4" [57MM]GATE POSTS & FOUNDATIONS: FOOTING DIAMETER TO BE DETERMINED BY MANUFACTURER, BASED ON LEAF WEIGHT & DIMENSION, BUT NOT LESS THAN DIAMETER SHOWN ON THESE DRAWINGS. MINIMUM FOOTING DIAMETERS (TO BE FILLED W/4000 PSI CONC): 40" Ø FOR 8" POST; 36" Ø FOR 6" POST; 24" Ø FOR 4" POST; OTHER SIZES TO BE DESIGNED DX MED OD VITA	ON DETAILS	RT CORPORATION RITY PERIMETER FENCE INE TERMINAL COUNTY NEW JERSEY
	BY MFR OR KTR. NO FOOTING WIDTH SHALL BE LESS THAN 4(X) THE POST WIDTH. <u>NOTE</u> : IF GATE HINGES ARE NOT OPPOSING (AS SHOWN ABOVE) OR LEAF IS NOT LOCKED MECHANICALLY TO THE HINGES, WELD AN ANGLE, PLATE, OR BLOCK ABOVE HINGE TO RESTRICT LEAF FROM BEING REMOVED OR LIFTED OFF. RESTRICTION SHALL NOT HINDER OPERATION OF GATE.	CONSTRUCTIC	SOUTH JERSEY PORT O REPLACEMENT OF SECURIT BALZANO MARINE CITY OF CAMDEN COL
	BARBED WIRE ARRANGEMENT DETAILS GRAPHIC SCALES		0
	$\begin{array}{c} 0 & 6" & 1' & 2' \\ 1" = 1' - 0" & & & \\ 0 & 4" & 8" & 1' - 4" \\ 1 & 1/2" = 1' - 0" & & & \\ \end{array}$	DRAWN BY : DESIGN BY : CFC DHS DATE : 4/20/2021 JOB No. : 3965X001	CHECKED BY: WMB AS NOTED SHEET No.: 10 of 11

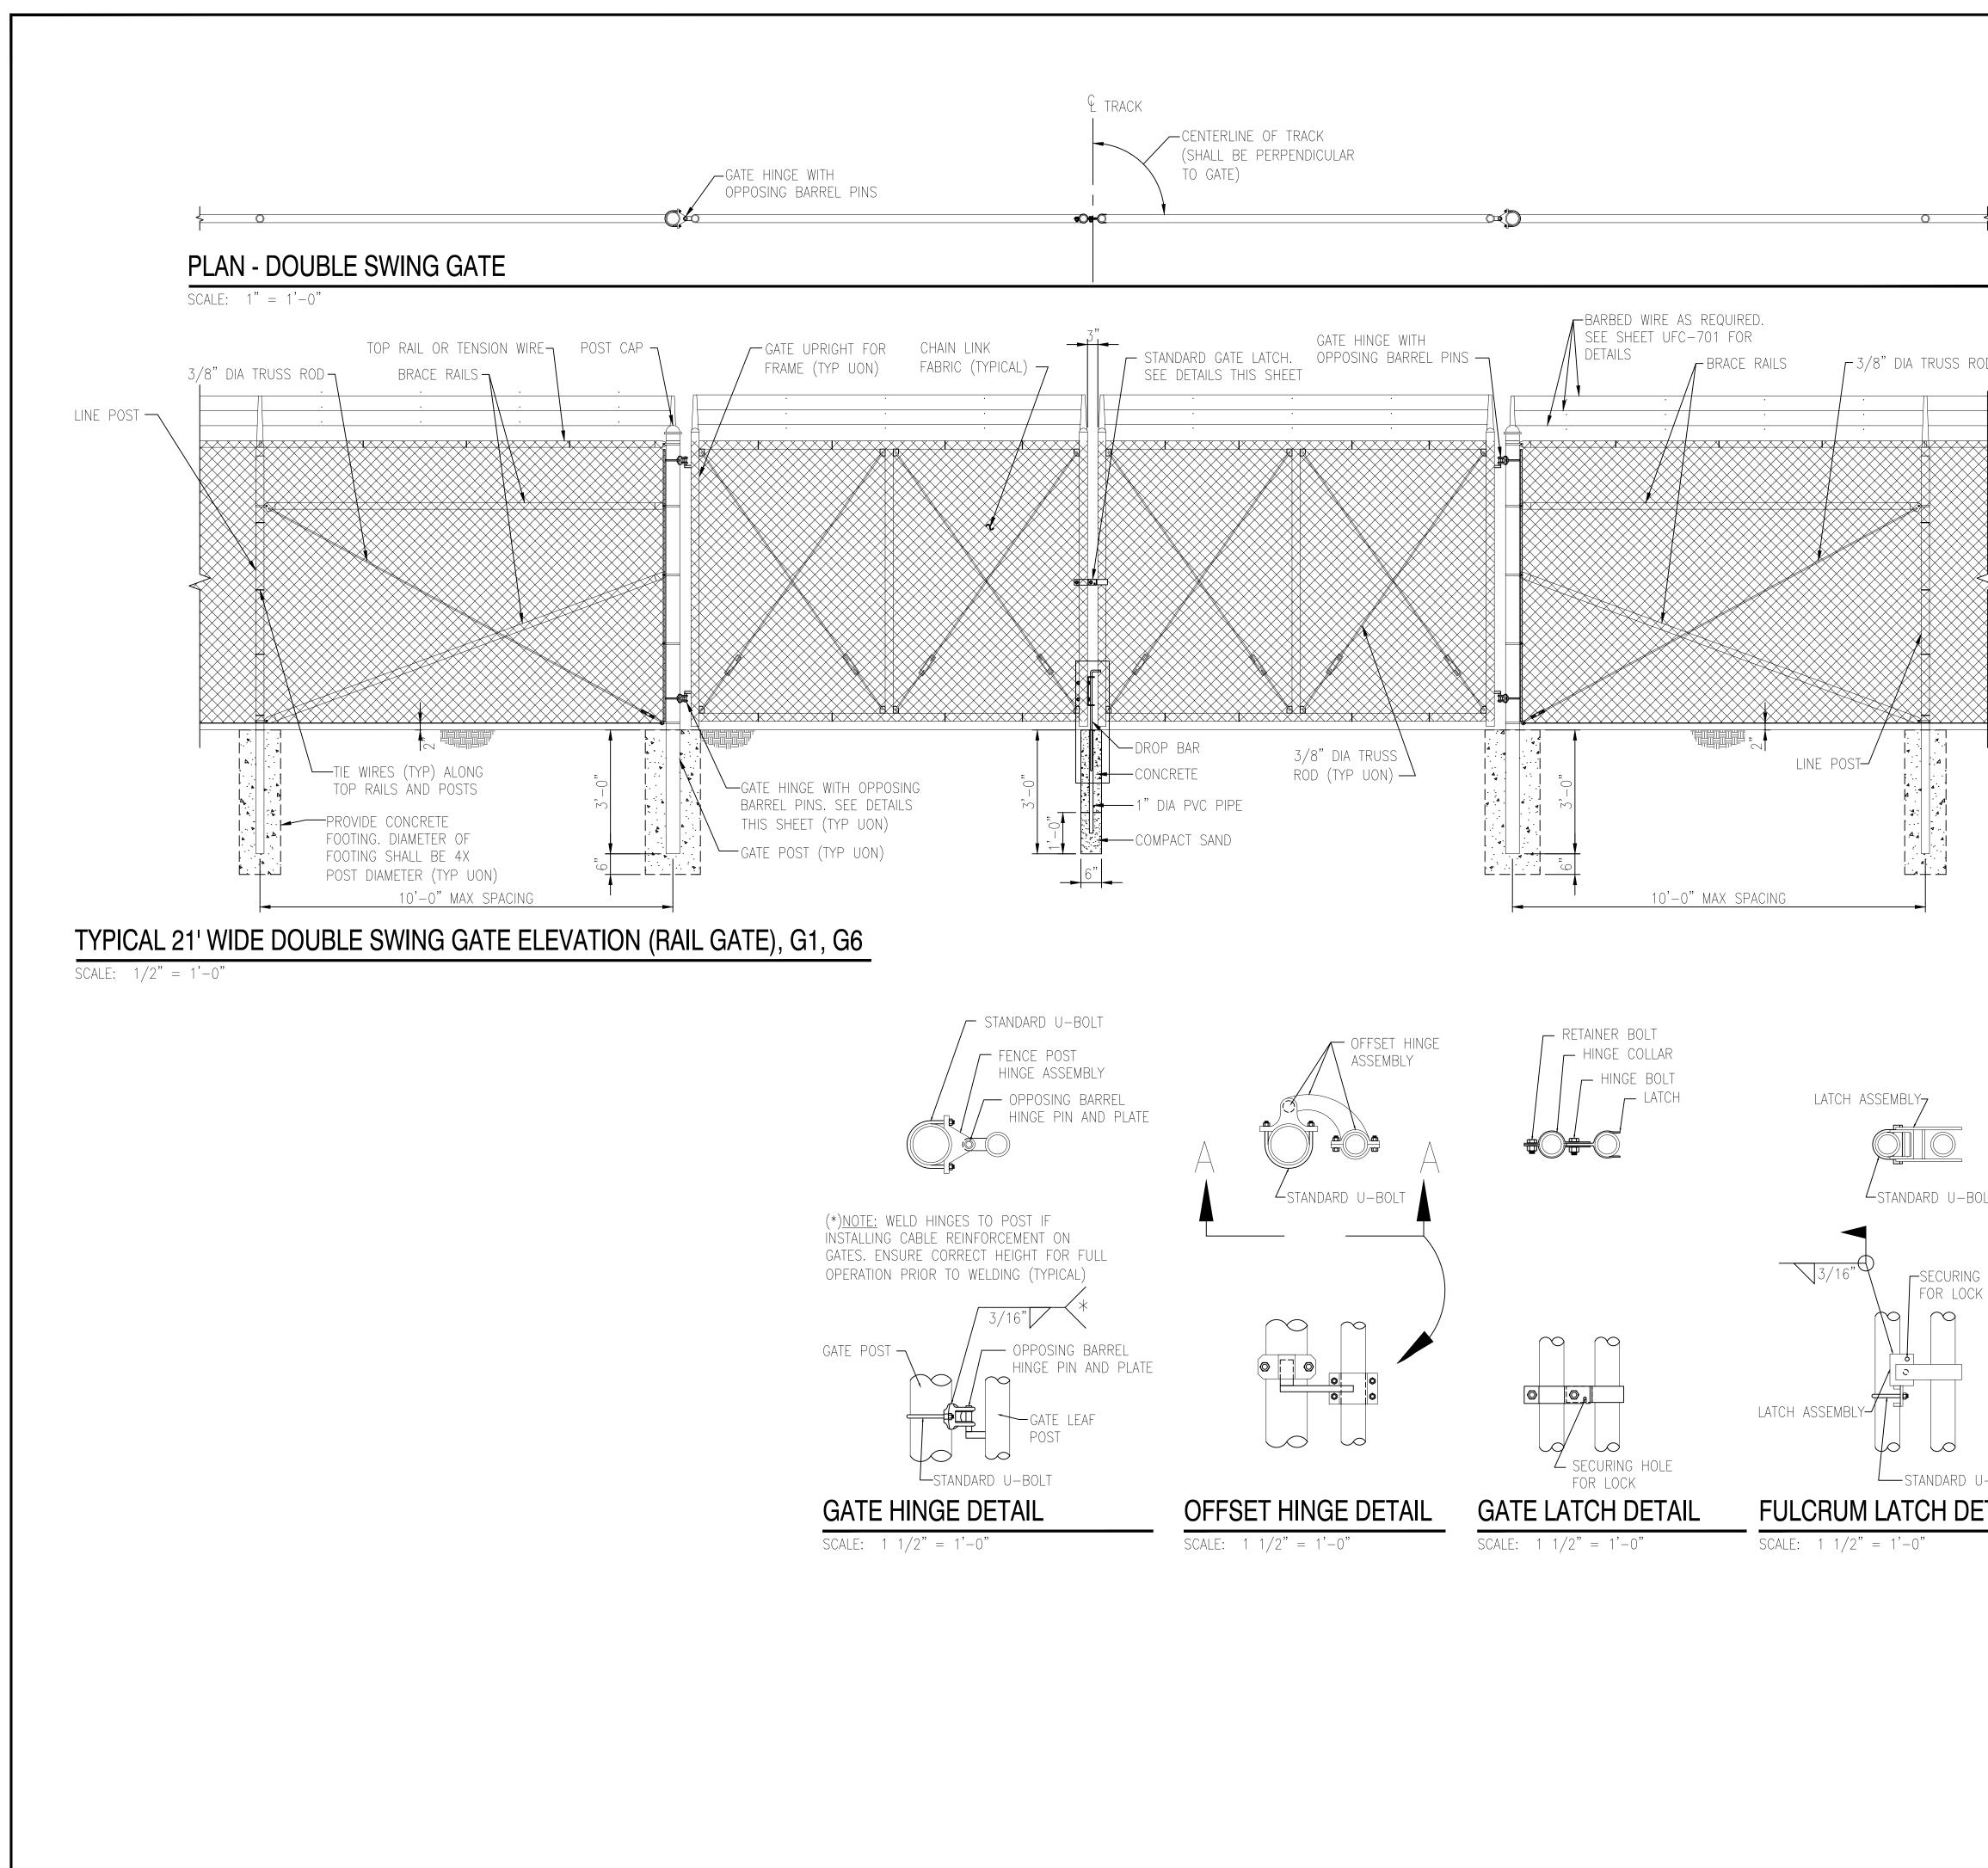

	NOTE: PROVIDE ONE DROP BAR FOR EACH LEAF (TYP). ASSOCIATED GALV SLEEVES TO BE INSTALLED FLUSH WILL GRADE AT FULLY OPEN AND CLOSED POSITIONS. CONTRACTOR SHALL PROVIDE 6" LAYER OF #10 STONE BELOW BOTTOM OF SLEEVE TO ALLOW FOR DRAINAGE.	I9 REMIN & VER ENGI 2059 SPRING CHERRY HIL (856) 795-9595, F. WEB SITE ADDRES	DALE ROAD LL, NJ 08003 AX (856) 795-1882 S : WWW.RVE.COM eation: 24 GA 28003300 EXCELLENCE~
	DETAIL: DROP BAR NOT TO SCALE	AN EMBOSSED SEA ALL DOCUMENTS PREPARED ENGINEERS AND AFFILIAT SERVICE IN RESPECT OF TH INTENDED OR REPRESENTED BY OWNER OR OTHERS ON E OR ON ANY OTHER PROJE	D BY REMINGTON & VERNICK TES ARE INSTRUMENTS OF TE PROJECT. THEY ARE NOT
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OLT S HOLE	8'-0" [2438MM] 7'-10" [2388MM] 6'-8 1/2" [2045MM] SINGLE LEAF GATES OPENING GATE POSTS HINGE SPACE (S) FACE TO FACE SQUARE & ROUND SIZES POST TO UPRIGHT 3'-0" [914MM] 2.5"[63.5MM]SQ × 3/16"TH FOR SQUARE & ROUND GATE POSTS: 6'-0" [1829MM] 2.875" [73MM] OD 2 1/4" [57MM] 6'-0" [1829MM] 4" [102MM] SQ × 3/16"TH FOR SQUARE & ROUND GATE POSTS: 12'-0" [3657MM] 4" [102MM] OD 2 1/4" [57MM]		No. REVISION DATE
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	GRAPHIC SCALES		ō
	$ \begin{array}{cccccccccccccccccccccccccccccccccccc$	DRAWN BY: DESIGN BY: CFC DHS DATE : 4/20/2021 JOB No. : 3965X001	CHECKED BY: WMB AS NOTED SHEET No.: 11 of 11

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