REPLACEMENT OF SECURITY PERIMETER FENCE BALZANO MARINE TERMINAL

	LIST OF UTILITIES
WATER & SEWER:	CAMDEN WATER L.L.C. 1257 S. SECOND ST. CAMDEN, NJ 08104 856-635-1264
WATER:	NEW JERSEY AMERICAN WATER CO. 213 CARRIAGE LANE DELRAN, NJ 08075
GAS:	PSE&G GAS DISTRIBUTION DIVISION 300 CONNECTICUT DRIVE BURLINGTON, NJ 08086 856-778-6776 ATTN: GEORGE BAKER
ELECTRIC:	PSE&G ELECTRIC DISTRIBUTION DIVISION 300 NEW ALBANY ROAD MOORESTOWN, NJ 08057 856-573-2077 ATTN: BOB SODER
CABLE:	COMCAST 1250 HADDONFIELD ROAD CHERRY HILL, NJ 08034 856-272-1000
TELEPHONE:	VERIZON - NEW JERSEY 10 TANSBORO ROAD BERLIN, NJ 08009
AT&T:	TRANSCONTINENTAL CABLE ROUTE UNDERGROUND LOCATION SERVICE NEW JERSEY UTILITIES ASSOCIATION 800-252-1133

	CITY OF CAMDEN STEVENS
	CITY OF CAMDEN
	NJ TRANSIT -Fintertainment 5
	NJ TRANSIT -Entertainment & Canter Clinton St. Center & Senate St. # SQUAL
	Evans St. CN
	Evans St. Full St. Children St. For St.
	\/////////////////////////////////////
	Line St Pine St Vi Co
	Pine St VI m 7
	PROJECT SITE -
	Spruce St Joint St #
	Spruce St Joint St 🛱 Cherry St.
	Fig. 2 Walmus St. 85
	9 6
	Chestnut St o
	Z St
	Sycalnore: St. Sycaln
	K-21/111110-0-1
	Liberty St
	Mechanic St
	Atlantic Ave
	Lansdowne Av.
	603
Delaware	

2	LEGEND
3	ESTIMATE & GENERAL NOTES
4	OVERALL SITE PLAN
5 - 7	CONSTRUCTION PLAN
8 - 11	CONSTRUCTION DETAILS

SHEET INDEX

SHEET#

DESCRIPTION

TITLE

PLANS WHICH DONOT BEAF
AN EMBOSSED SEAL ARE NOT VALID

ALL DOCUMENTS PREPARED BY REMINGTON & VERNICE
ENGINEERS AND AFFILIATES ARE INSTRUMENTS
SERVICE IN RESPECT OF THE PROJECT. THEY ARE NOT SERVICE IN RESPECT OF DE SUITABLE FOR REUSI

SERVICE IN RESPECT OF THE PROJECT. THEY ARE NOT INTENDED OR REPRESENTED TO BE SUITABLE FOR REUSE BY OWNER OR OTHERS ON EXTENSIONS OF THE PROJECT OR ON ANY OTHER PROJECT. ANY REUSE WITHOUT WRITTEN VERIFICATION OR ADAPTATION BY REMINGTON & VERNICK ENGINEERS AND AFFILIATES FOR THE SPECIFIC PURPOSE INTENDED WILL BE AT OWNERS SOLE RISK AND WITHOUT LIABILITY OR LEGAL EXPOSURE TO REMINGTON & VERNICK ENGINEERS AND AFFILIATES; AND OWNER SHALL INDEMNIFY AND HOLD HARMLESS REMINGTON & VERNICK ENGINEERS AND AFFILIATES FROM ALL CLAIMS DAMAGES, LOSSES AND EXPENSES ARISING OUT OF OR R E S U L T I N G T H E R E F R O M

REMINGTON

2059 SPRINGDALE ROAD CHERRY HILL, NJ 08003 (856) 795-9595, FAX (856) 795-1882 WEB SITE ADDRESS: WWW.RVE.COM

~ENGINEERING EXCELLENCE~

NJ PROFESSIONAL ENGINEER LIC. No. 5106

& VERNICK

No. REVISION DATE BY CHI

SHEET

SOUTH JERSEY PORT CORPORATION

EMENT OF SECURITY PERIMETER

BALZANO MARINE TERMINAL

 DRAWN BY:
 DESIGN BY:
 CHECKED BY:
 SCALE:

 CFC
 DHS
 WMB
 AS NOTED

 DATE:
 SHEET No.:

 4/20/2021
 1
 Of 11

PROJECT LOCATION MAP

SCALE: 1" = 1000'

THE ELECTRONIC VERSION OF THE 2019 NEW JERSEY DEPARTMENT OF TRANSPORTATION STANDARD SPECIFICATIONS FOR ROAD AND BRIDGE CONSTRUCTION, EFFECTIVE SEPTEMBER 1, 2019, AS REFERENCED IN BASELINE DOCUMENT CHANGE ANNOUNCEMENT BDC19S-01, UNLESS MODIFIED WITHIN THE TECHNICAL SPECIFICATIONS OF THIS CONTRACT, SHALL GOVERN.

THE NEW JERSEY DEPARTMENT OF TRANSPORTATION "STANDARD ROADWAY CONSTRUCTION\TRAFFIC CONTROL\BRIDGE CONSTRUCTION DETAILS" BOOKLET DATED 2007 AND "ELECTRICAL BUREAU STANDARD DETAILS, 2007" AND ALL BASELINE DOCUMENT CHANGES MADE TO THESE CONSTRUCTION DETAILS, SHALL GOVERN, EXCEPT FOR THOSE DETAILS CONTAINED HEREIN.

CITY OF CAMDEN CAMDEN COUNTY, NEW JERSEY

OCTOBER, 2021

FUNDING SOURCE:

SJPC



IT IS THE RESPONSIBILITY OF THE CONTRACTOR
TO CONTACT NJ ONE CALL PRIOR TO THE START
OF CONSTRUCTION. CALL FOR MARKOUTS THREE
(3) FULL BUSINESS DAYS IN ADVANCE AND BEGIN
EXCAVATION WITHIN 10 DAYS. ALL CONTRACTORS
ON-SITE MUST HAVE THEIR OWN MARKOUT.

STANDARD LEGEND

					NOTE: AI	LL SYMBOLS MAY NOT BE	USED					∐IKAF
И	DESCRIPTION	EXISTING	PROPOSED	ITEM	DESCRIPTION	EXISTING	PROPOSED	ITEM	DESCRIPTION	EXISTING	PROPOSED	REMINGTO
	OVERHEAD WIRE				CROWS FOOT	Ý			EDGE OF PAVEMENT			& VERNICK ENGINEER
	SANITARY FORCE MAIN PIPE	FM	FM		AERIAL TARGET		+		CURB			2059 SPRINGDALE RO
	STORM SEWER PIPE ≤12"				CONCRETE MONUMENT	•	■ (SET)		PAVEMENT / CONC. / SIDEWALK	BITUMINOUS/ASPHALT	ASPHALT DRIVEWAY	CHERRY HILL, NJ 08 (856) 795-9595, FAX (856)
	STORM SEWER PIPE > 12"	(SIZE & TYPE)	<u>(SIZE & TYPE)</u> =		PK / MAG NAIL DRILL HOLE	0	• (SET)			CONCRETE	CONCRETE	WEB SITE ADDRESS: WWW. Certification of Authorization: 24 GA
	GAS SERVICE		G		SPIKE					BRICK/PAVERS	BRICK/PAVERS	~ENGINEERING EXCELLEN
	SANITARY SEWER PIPE ≤12"	s			DRILL HOLE W/ WINGS	- <mark> </mark> -				STONE	STONE	
	SANITARY SEWER PIPE > 12"	(SIZE & TYPE) 	<u>(SIZE & TYPE)</u> =		STAKE	Δ	▲ (SET)				MILLING	WILLIAM M. BIS
	ELECTRIC SERVICE	E	——————————————————————————————————————		HUB	Δ	Δ (SET)		LIMIT OF EXCAVATION			NJ PROFESSIONAL ENGINEER L
	FIBER OPTIC SERVICE	FO	F0		PIN W/ CAP IRON PIPE	©	• (SET)		GUIDE RAIL		 	
	TELEPHONE SERVICE	Т —	——т		IRON PIN		• (SET)	WORK	BOLLARD	0	Ø	
	COMMUNICATIONS SERVICE	c	c		CROSS CUT	×	★ (SET)		MAILBOX	М	M	
	IRRIGATION PIPE		IRR	\	DISK				SIGNS		 +	
	WATER SERVICE		——————————————————————————————————————	S	STONE	0			FLAG POLE	\sim	←	
	WATER SHUT-OFF	w.Sc			REBAR	⊗			BENCH			
	WATER METER	w _w	₩₩		BASELINE	-	+		PILE			
	WATER VALVE	wv ⊠	M NEW M RESET		CENTERLINE				DETECTABLE WARNING SURFACE	m.	283	
	WATER HYDRANT	HŸD	▼ NEW ▼ RESET		EASEMENT			ર્જ	TYPICAL STRIPING			
	WELL	@	•		RIGHT-OF-WAY				ADA STRIPING	Ł	<u></u>	DIANO WILLOW
	YARD HYDRANT	Ø			PROPERTY BOUNDARY				TRAFFIC CONTROL BOX	[TCB]		PLANS WHICH DO N AN EMBOSSED SEAL ARE
	METER PIT	0			ADJACENT PROPERTY BOUNDARY				TRAFFIC LIGHT		(ARM TO SCALE)	ALL DOCUMENTS PREPARED BY REMIN ENGINEERS AND AFFILIATES ARE IN SERVICE IN RESPECT OF THE PROJEC: INTENDED OR REPRESENTED TO BE SUIT
	GAS SHUT-OFF	c.So			RAILROAD TRACKS				DEPT. OF TRANSPORTATION MANHOLE	<i>∞</i>		BY OWNER OR OTHERS ON EXTENSIONS OR ON ANY OTHER PROJECT. ANY F WRITTEN VERIFICATION OR ADAPTATION VERNICK ENGINEERS AND AFFILIATES F
	GAS METER	e n			STATE BOUNDARY				STATE HIGHWAY DEPARTMENT	™ MANHOLE SHD BOX		PURPOSE INTENDED WILL BE AT OWNEF WITHOUT LIABILITY OR LEGAL EXPOSUF & VERNICK ENGINEERS AND AFFILIAT
	GAS VALVE	×	M NEW M RESET		MUNICIPAL / COUNTY BOUNDARY				RAILROAD CROSSING BEACON	⊗		SHALL INDEMNIFY AND HOLD HARMLE VERNICK ENGINEERS AND AFFILIATES I DAMAGES, LOSSES AND EXPENSES AF R E S U L T I N G T H E R
	GAS LINE MARKER	<u>-6</u>		 _ 					CALL BOX	②		
	CLEANOUT	\mathscr{C}	•	A	BORING LOCATION	♦ <i>B−#</i>	♦ B−#		OIL FILL	€		
	SEWER VENT	$\overset{\mathfrak{F}}{\oplus}$		<u> </u>	MONITORING WELL LOCATION	⊕ MW-#	→ MW-#		UNDERGROUND STORAGE TANK LID	UST		
	INLET TYPE A		RESET RECONSTRUCT		TEST PIT LOCATION	₽ 7 <i>P−#</i>	■ TP-#		RISER PIPE	8°		
	INLET TYPE B		RESET RECONSTRUCT		FRESHWATER WETLAND FLAG	▼ FW-#			RAISED PAVEMENT MARKER	В	•	
	INLET TYPE E		RESET RECONSTRUCT		FRESHWATER WETLAND LINE							-
	AREA DRAIN		•	&	FRESHWATER WETLAND BUFFER				BBQ GRILL			
	MANHOLES	S SANITARY @ DRAINAGE ® TELEPHONE			EDGE OF WATER				WATER FOUNTAIN	WF.		
		W WA TER © CA TV @ UNDERDRAIN E ELECTRIC © GAS W UNKNOWN	NEW RESET RECONSTRUCT		STREAM CENTERLINE				KIOSK	KIO B		
	IRRIGATION CONTROL VALVE	×	M NEW M RESET					<u> </u>	AIR CONDITIONER	AD		
	IRRIGATION BOX				GRASS/SOD	grann-ty			PARKING METER	e _M		
	IRRIGATION CONTROL BOX	IR C		<u>0</u>	DECIDUOUS TREE	A CONTRACTOR OF THE CONTRACTOR	SHADE ORNAMEN	TAL	FIRE CONTROL VALVE	FV ⊠		
	SPRINKLER HEAD	©	•		SHRUBS / BUSH		white.		BARRICADE		- 	
	UNKNOWN VALVE	\bowtie		Q	EVERGREENS		The state of the s					_
	COMMUNICATIONS PEDESTAL	Ø		0	STUMP				PHOTO LOCATION		#	
	COMMUNICATIONS LINE MARKER	<u>-ç</u>			WOODS / TREE LINE		·	AL	BENCHMARK LOCATION	(BM)	•	SATION
	TELEPHONE PEDESTAL	7			WIRE FENCE	//////	 ////		TYPICAL SECTION ARROW		A	
	TELEPHONE LINE MARKER	_		 	SPLIT RAIL FENCE		 0	GENER	MATCH LINE			
	ELEC. BOX			-	WOOD / VINYL FENCE				TYPICAL NORTH ARROW	NAD-1983		∥
	ELEC. METER	5"			CHAIN-LINK FENCE	XX	xx	~			ON STANDARD CONSTRUCTION SHEETS O STATE PLANE COORDINATE SYSTEM.	H H
	ELEC. TRANSFORMER PAD	ET)			TOP OF BANK / DITCH							——————————————————————————————————————
	ELEC. VAULT	EN			BOTTOM OF BANK / DITCH	——————————————————————————————————————		<u>S</u>		BOUND, SOUTHBOUND PC POIN	STATE HIGHWAY T OF CURVATURE S.H.D. DEPARTMENT	l os
	ELEC. LINE MARKER	<u>-£</u>		9	CONTOUR (MAJOR)		5		BL BASELINE G GUTTER BM BENCH MARK GR GRATE	PT POIN	T OF INFLECTION SHLD. SHOULDER T OF TANGENCY STY. STORY TER KAYLON MASONEY NAIL TO BE ARANDONED.	i
	UTILITY POLE	STANDARD W/ LIGHT W/ SOLAR			CONTOUR (MINOR)		3			ENSITY POLYETHYLENE PIPE PROP. PROF		
	GUY ANCHOR	,, - 			FLOW LINE / SWALE	>>-	— — > — — > —		CL CENTERLINE INV. INVERT C.I.P. CAST IRON PIPE IP IRON PI CONC. CONCRETE J.B. JUNCTI	N PVC POIN	VINYL CHLORIDE PIPE TC TOP OF CURB T OF VERTICAL CURVATURE TEL TELEPHONE T OF VERTICAL INTERSECTION TEMP. TEMPORARY	
	ELEC. OUTLET	⊜	G	MA	TIME OF CONCENTRATION		>		C.M.P. CORRUGATED METAL PIPE L.S.T. LANDSO		T OF VERTICAL TANGENCY TYP. TYPICAL	
	LIGHTS	[©] POLE [™] AREA	* \	5	SPOT GRADE	x ^{3.48}	_X 3.48	BBRE		PAVING R.C.P. REINI	FORCED CONCRETE PIPE U.P. UTILITY POLE METALLIC CONDUIT VAR. VARIES	DRAWN BY: DESIGN BY: CHECKED
	VENT	W7			ROADWAY GRADE	TC5.45 GL 4.95	TC5.45 GL4.95		DIA. DIAMETER MAX. MAXIMU DWY DRIVEWAY MIN. MINIMU	M R.O.W. RIGH	T OF WAY VIF VERIFY IN FIELD	CFC DHS WMB
1		19			DRAINAGE FLOW	——————————————————————————————————————	\Rightarrow	AB	D.I.P. DUCTILE IRON PIPE NO. NUMBE EL. ELEVATION N.T.S. NOT TO	R RTE. ROUT	E	4/20/2021 <u>JOB No. :</u> 2

FOTIMATE OF OURNITITIES									
	ESTIMATE OF QUANTITIES								
ITEM NO.	DESCRIPTION	QUANTITY	UNIT	REMARKS					
				SEE PLAN NOTES FOR					
001	REMOVAL OF VEGETATION	1	LS	LOCATION					
002	6' ORNAMENTAL ALUMINUM FENCE	175	LF						
	8' HIGH CHAIN LINK FENCE WITH								
003	BARBED WIRE TOP	1450	LF						
	10' HIGH CHAIN LINK FENCE WITH								
	BARBED WIRE TOP AND PRIVACY								
004	SLATS	1000	LF						
005	8' HIGH BI-FOLD GATE	1	EA	G4					
006	8' HIGH RAIL GATE	1	EA	G6					
	10' HIGH RAIL GATE WITH BARBED								
007	WIRE TOP AND PRIVACY SLATS	1	EA	G1					
800	8' HIGH DOUBLE SWING GATE	2	EA	G5, G7					
009	8' HIGH SINGLE SWING GATE	1	EA	G8					
	10' HIGH DOUBLE SWING GATE								
	WITH BARBED WIRE TOP AND								
010	PRIVACY SLATS	2	EA	G2, G3					

GENERAL NOTES:

- 1. CONTRACTOR SHALL VERIFY ALL DIMENSIONS AND EXISTING CONDITIONS IN THE FIELD PRIOR TO THE START OF THE CONSTRUCTION, ANY ERRORS OR DISCREPANCIES SHALL BE BROUGHT TO THE ATTENTION OF THE ENGINEER IMMEDIATELY.
- 2. LOCATION OF EXISTING UTILITIES ARE APPROXIMATE AND MUST BE VERIFIED IN THE FIELD PRIOR TO THE START OF CONSTRUCTION.
- 3. THE CONTRACTOR SHALL USE EXCAVATED MATERIALS FOR BACKFILL UNLESS OTHERWISE DIRECTED BY THE ENGINEER.
- 4. ALL PAVED AND CONCRETE AREAS DISTRIBUTED DURING CONSTRUCTION SHALL BE RESTORED TO EXISTING CONDITION AT LEAST EQUAL TO THAT WHICH EXISTED PRIOR TO THE START OF CONSTRUCTION.
- 5. ALL GRASSED OR WOODED AREAS DISTRIBUTED DURING CONSTRUCTION SHALL BE TOPSOILED AND SEEDED.
- 6. ALL FILL SHALL BE PLACED IN 12" LAYERS AND THOROUGHLY COMPACTED TO THE SATISFACTION OF THE ENGINEER. IF BORROW FILL IS REQUIRED, IT SHALL BE SUBJECT TO THE APPROVAL OF THE ENGINEER.
- 7. THE CONTRACTOR SHALL BE RESPONSIBLE FOR THE LOCATION AND PRESERVATION OF THE UNDERGROUND AND SURFACE UTILITIES AND STRUCTURES AT OR ADJACENT TO THE SITE OF CONSTRUCTION AND IT SHALL BE AT HIS OWN EXPENSE TO REPAIR OR REPLACE ANYTHING THAT HE DAMAGES.
- 8. APPROXIMATE DEPTH OF ALL WATER MAINS ARE \pm 4 FEET.
- 9. APPROXIMATE DEPTH OF ALL GAS MAINS ARE \pm 3 FEET.
- 10. ALL UNUSED MATERIAL EXCAVATED FROM THE PROJECT SITE ARE TO BE DISPOSED OF AT AN APPROVED FACILITY.
- 11. FENCING TO COMPLY WITH UNITED FACILITIES CRITERIA (UFC) 4-022-03, SECURITY FENCES AND GATES.
- 12. GATE IDENTIFICATION PLACARDS AND ALL FENCE SIGNS SHALL BE REMOVED PRIOR TO CONSTRUCTION AND PRESERVED BY THE CONTRACTOR FOR THE DURATION OF CONSTRUCTION.
- 13. CONTRACTOR SHALL REPLACE ALL GATE IDENTIFICATION PLACARDS AND FENCE SIGNS UPON COMPLETION OF CONSTRUCTION.
- 14. CONTRACTOR SHALL RESTORE ALL GATE ALARMS AND OTHER FENCE SECURITY DEVICES TO FULL WORKING ORDER UPON COMPLETION OF CONSTRUCTION.

CONSTRUCTION STAGING REQUIREMENTS:

<u>OPTION A:</u>

- 1. SECURITY FENCE REPLACEMENT SHALL BE LIMITED TO ONE (1), 400' (FEET) LENGTH OF FENCE MAXIMUM AT A TIME.
- 2. WHEN FENCE SECTIONS ARE REMOVED, A PORT SECURITY GUARD SHALL BE POSTED AT THAT LOCATION FOR THE DURATION OF THE WORK AND/OR UNTIL FENCE SECTION HAS BEEN REPLACED AND THE SECURITY PERIMETER FENCE IS DEEMED SECURE.
- 3. THE INTENT OF THIS PROCEDURE IS TO ENSURE THAT NO SECTION OF THE FENCE IS REMOVED BEYOND THAT WHICH CANNOT BE FULLY REPLACED DURING ONE WORK DAY.
- 4. AT THE END OF EACH WORK DAY, THE PORT PERIMETER SECURITY FENCING SHALL BE FULLY INTACT AND SECURE IN ACCORDANCE WITH USCG REQUIREMENTS.

<u>OPTION B:</u>

- 1. SHOULD THE CONTRACTOR ELECT TO USE TEMPORARY FENCING/BARRIERS TO ALLOW FOR MORE THAN 400' (FEET) OF FENCE REMOVAL AT A TIME, THE FOLLOWING WILL BE REQUIRED: TEMPORARY FENCING LAYOUT, MATERIALS AND LENGTH OF FENCE REMOVAL SUBJECT TO ENGINEER APPROVAL.
- 2. TEMPORARY FENCING SHALL MEET USCG STANDARDS AND REQUIREMENTS.
- 3. POSTS FOR TEMPORARY FENCING SHALL BE ADEQUATELY ANCHORED INTO THE GROUND. FENCE POST STANDS ON GRADE ARE NOT ACCEPTABLE.
- 4. AN APPROVED TEMPORARY FENCING SYSTEM SHALL BE INSTALLED SUCH THAT IT REMAINS IN PLACE AT ALL TIMES AND THE PORT REMAINS SECURE. ANY OPENINGS IN THE SECURITY PERIMETER, HOWEVER TEMPORARY, SHALL BE APPROVED BY THE ENGINEER AND SHALL HAVE A PORT SECURITY GUARD POSTED FOR THE DURATION OF THE OPENING.

REMINGTON & VERNICK **ENGINEERS**

CHERRY HILL, NJ 08003 (856) 795-9595, FAX (856) 795-1882 WEB SITE ADDRESS: WWW.RVE.COM Certification of Authorization: 24 GA 28003300


~ENGINEERING EXCELLENCE~

2059 SPRINGDALE ROAD

WILLIAM M. BISIRRI NJ PROFESSIONAL ENGINEER LIC. No. 51062


PLANS WHICH DO NOT BEAR AN EMBOSSED SEAL ARE NOT VALID ALL DOCUMENTS PREPARED BY REMINGTON & VERNICK


ENGINEERS AND AFFILIATES ARE INSTRUMENTS O SERVICE IN RESPECT OF THE PROJECT. THEY ARE NO INTENDED OR REPRESENTED TO BE SUITABLE FOR REUS BY OWNER OR OTHERS ON EXTENSIONS OF THE PROJECT OR ON ANY OTHER PROJECT. ANY REUSE WITHOU WRITTEN VERIFICATION OR ADAPTATION BY REMINGTON 8 VERNICK ENGINEERS AND AFFILIATES FOR THE SPECIFIC PURPOSE INTENDED WILL BE AT OWNERS SOLE RISK AND WITHOUT LIABILITY OR LEGAL EXPOSURE TO REMINGTON & VERNICK ENGINEERS AND AFFILIATES; AND OWNER SHALL INDEMNIFY AND HOLD HARMLESS REMINGTON (VERNICK ENGINEERS AND AFFILIATES FROM ALL CLAIMS DAMAGES, LOSSES AND EXPENSES ARISING OUT OF OF RESULTING THEREFROM

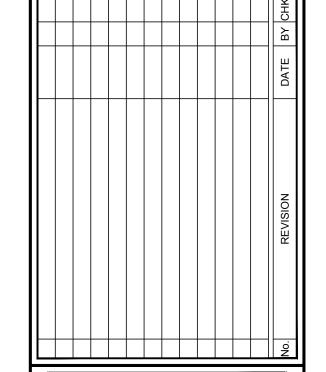



TH JERSEY PORT COF

DRAWN BY: DESIGN BY: CHECKED BY: SCALE: CFC DHS WMB AS NOTED SHEET No.: EOQ-1 4/20/2021 3 of 11 JOB No.: 3965X001

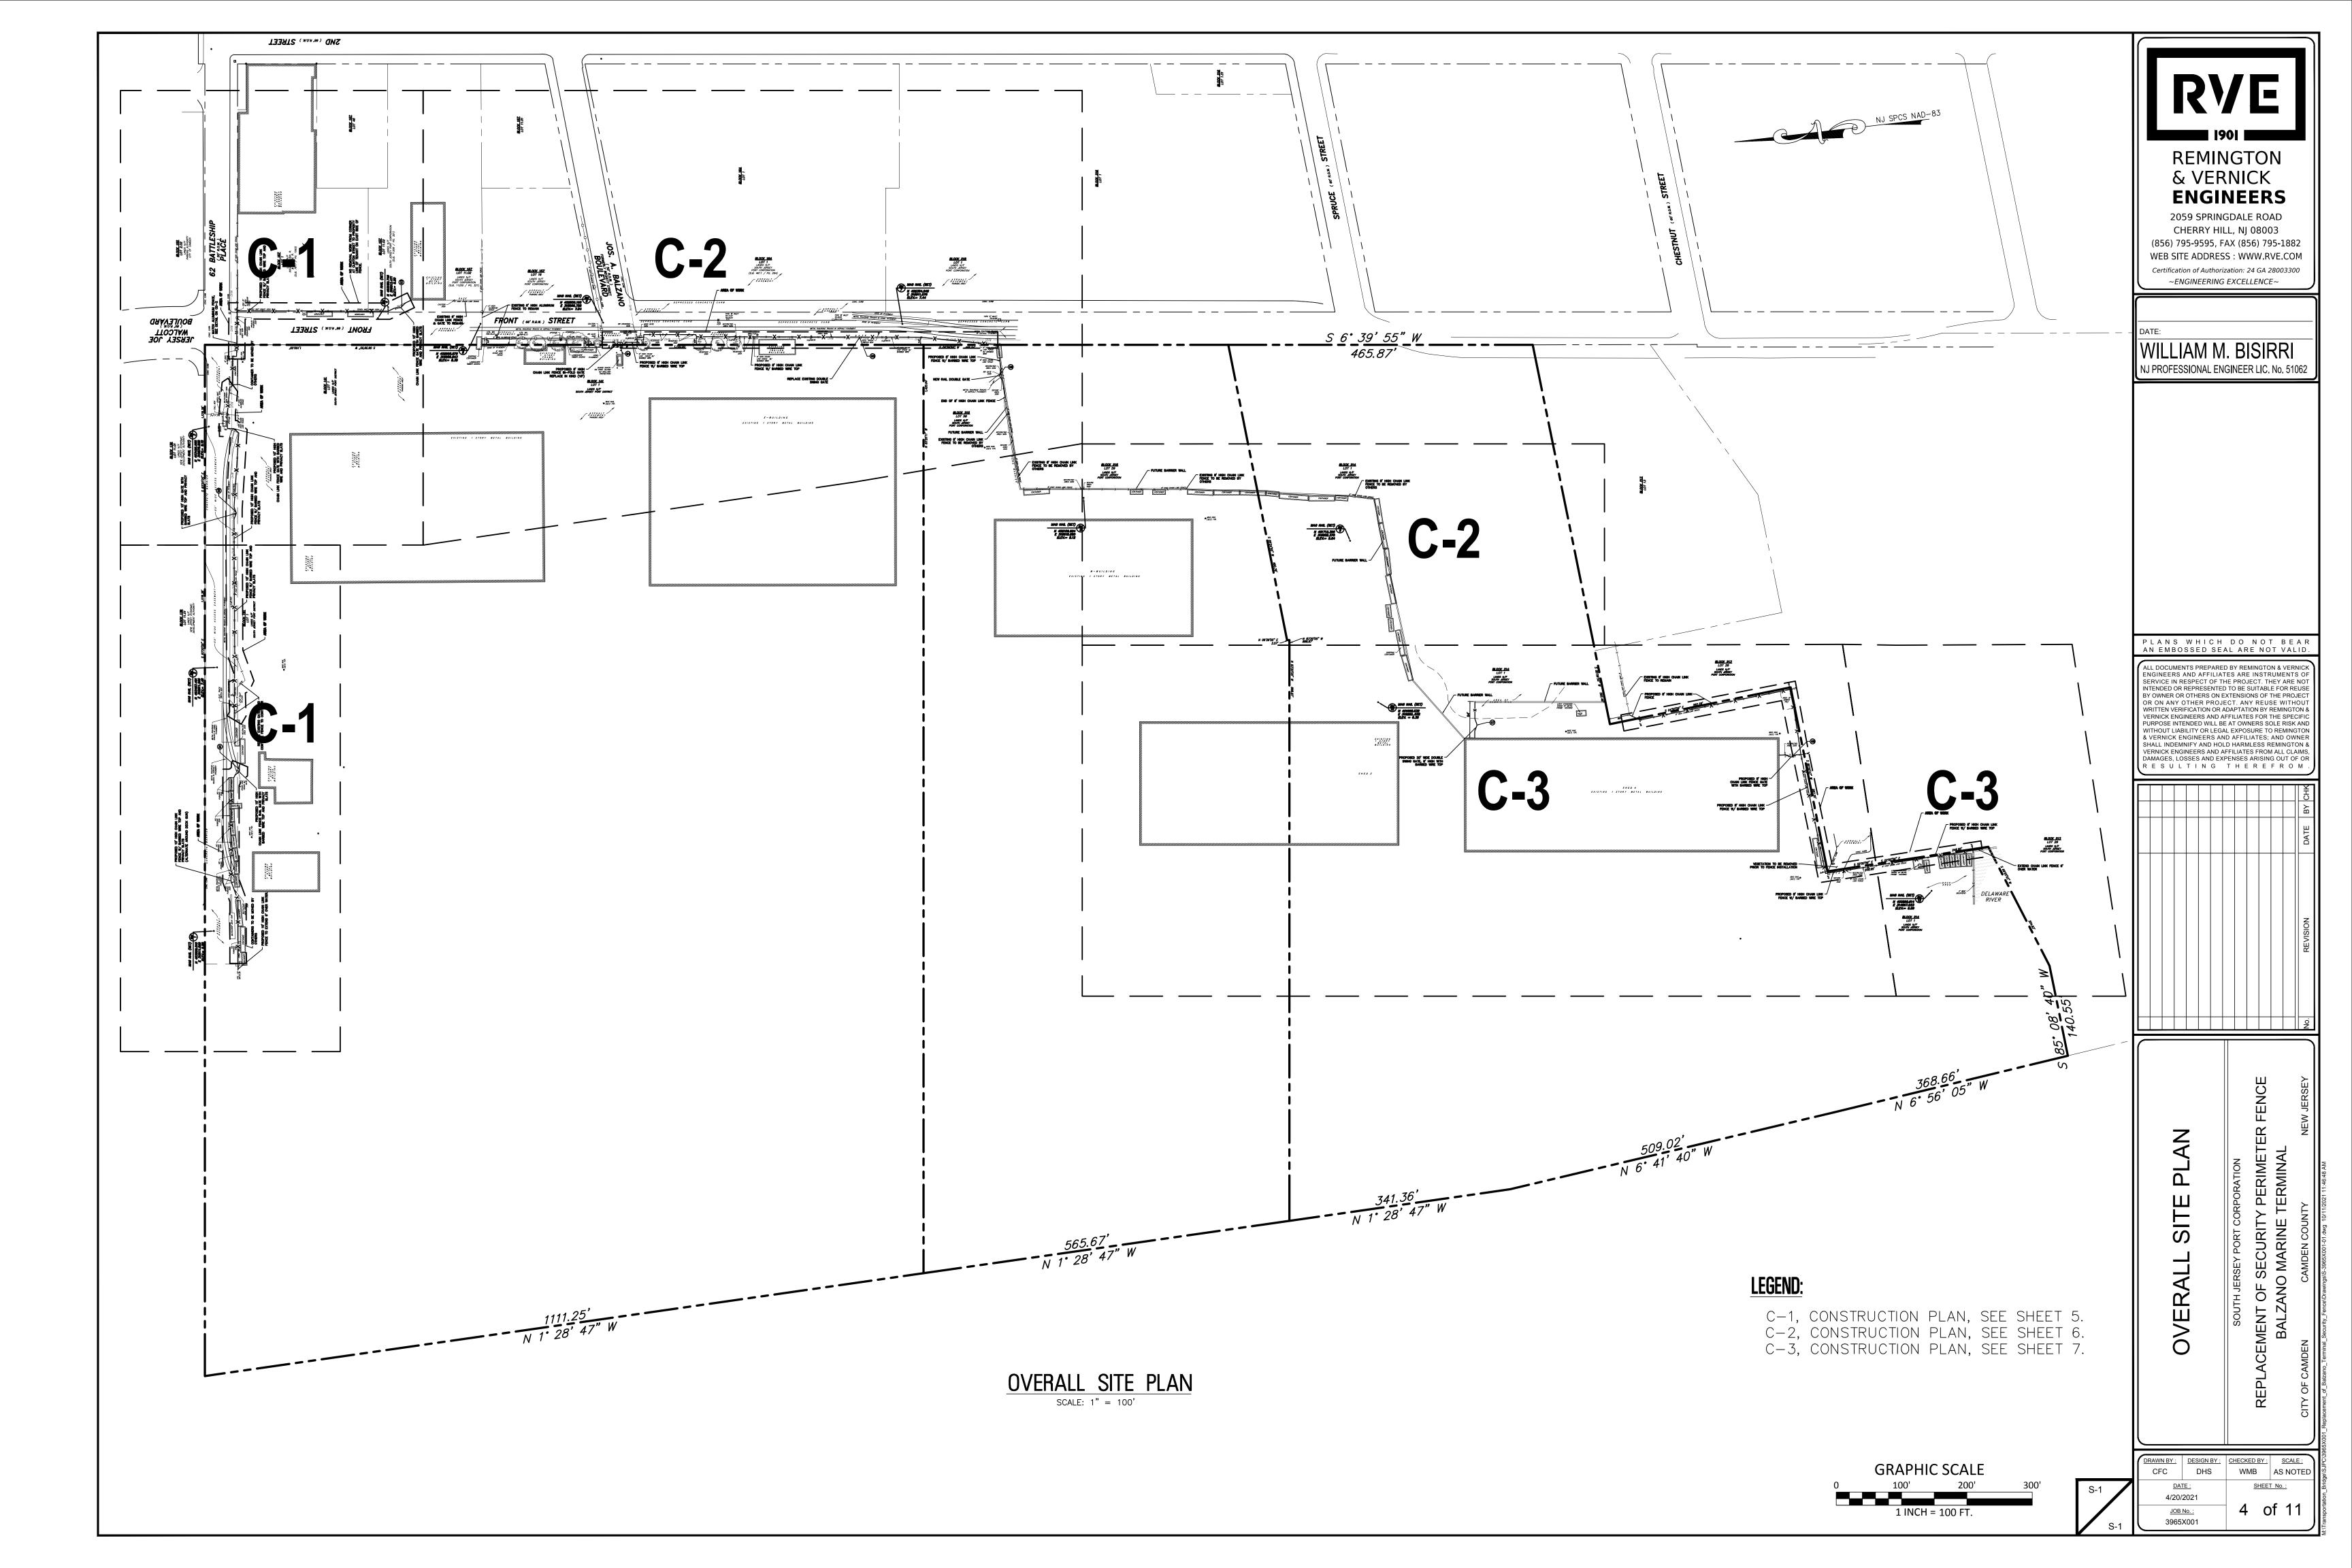


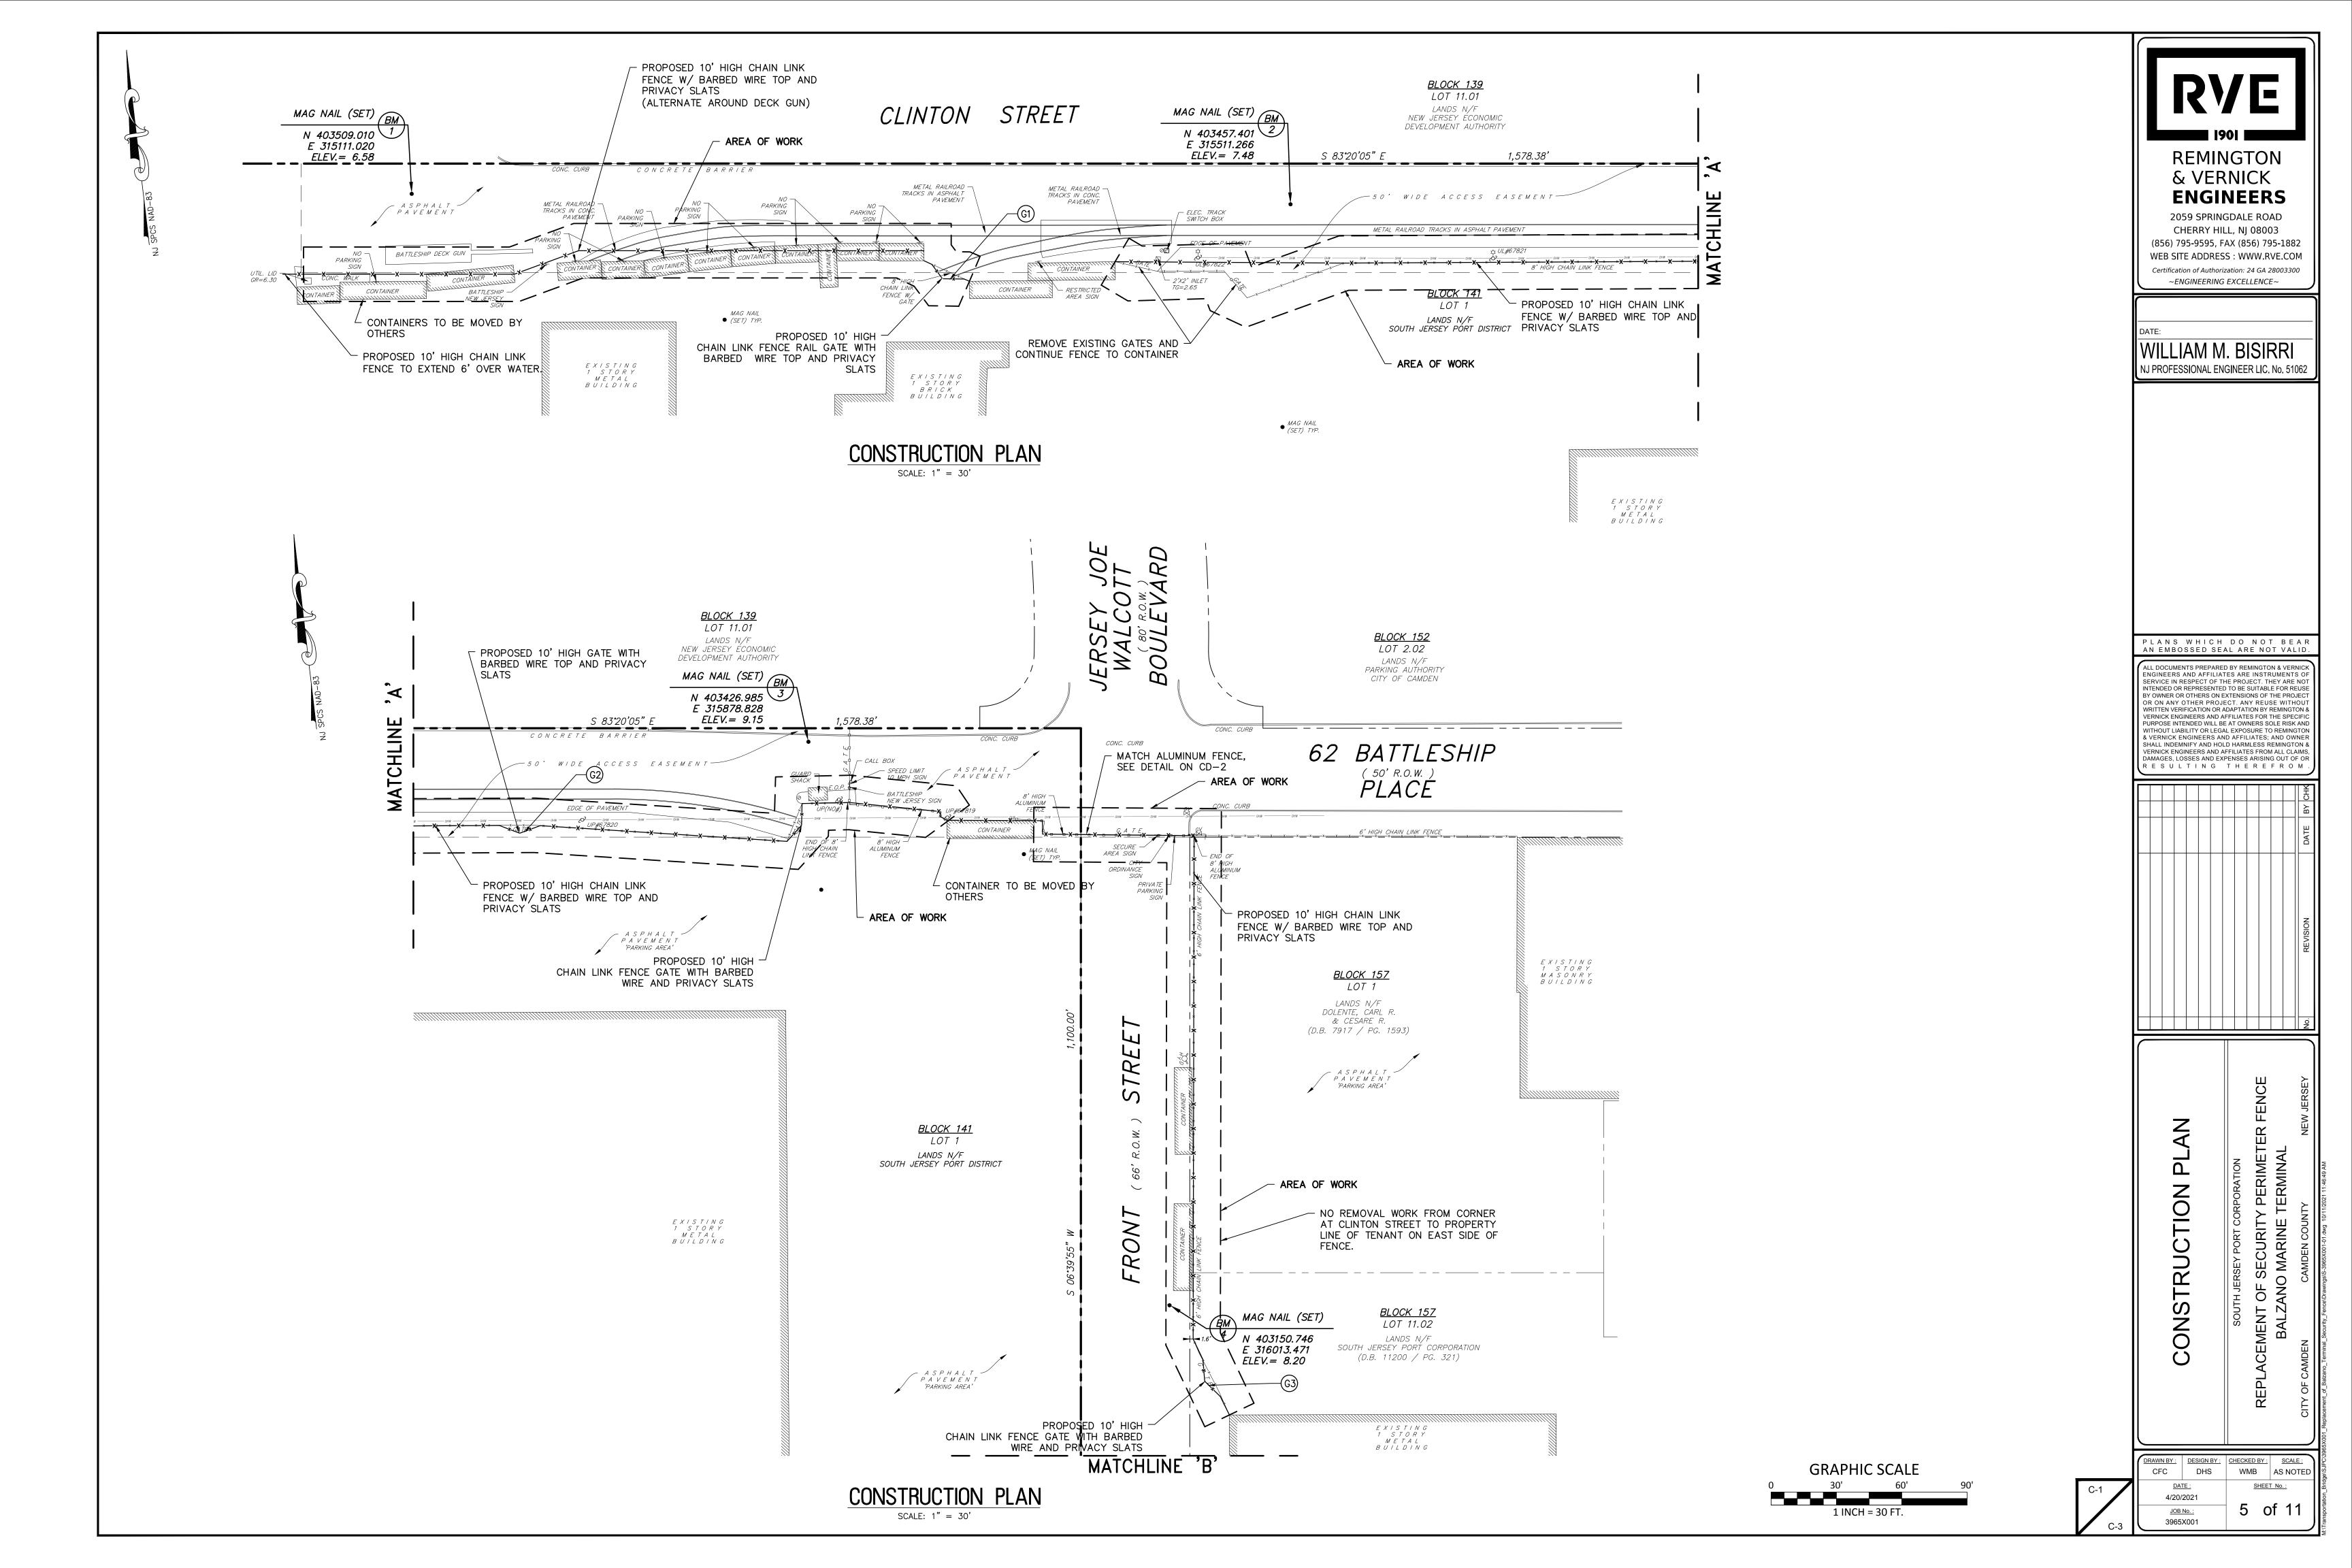


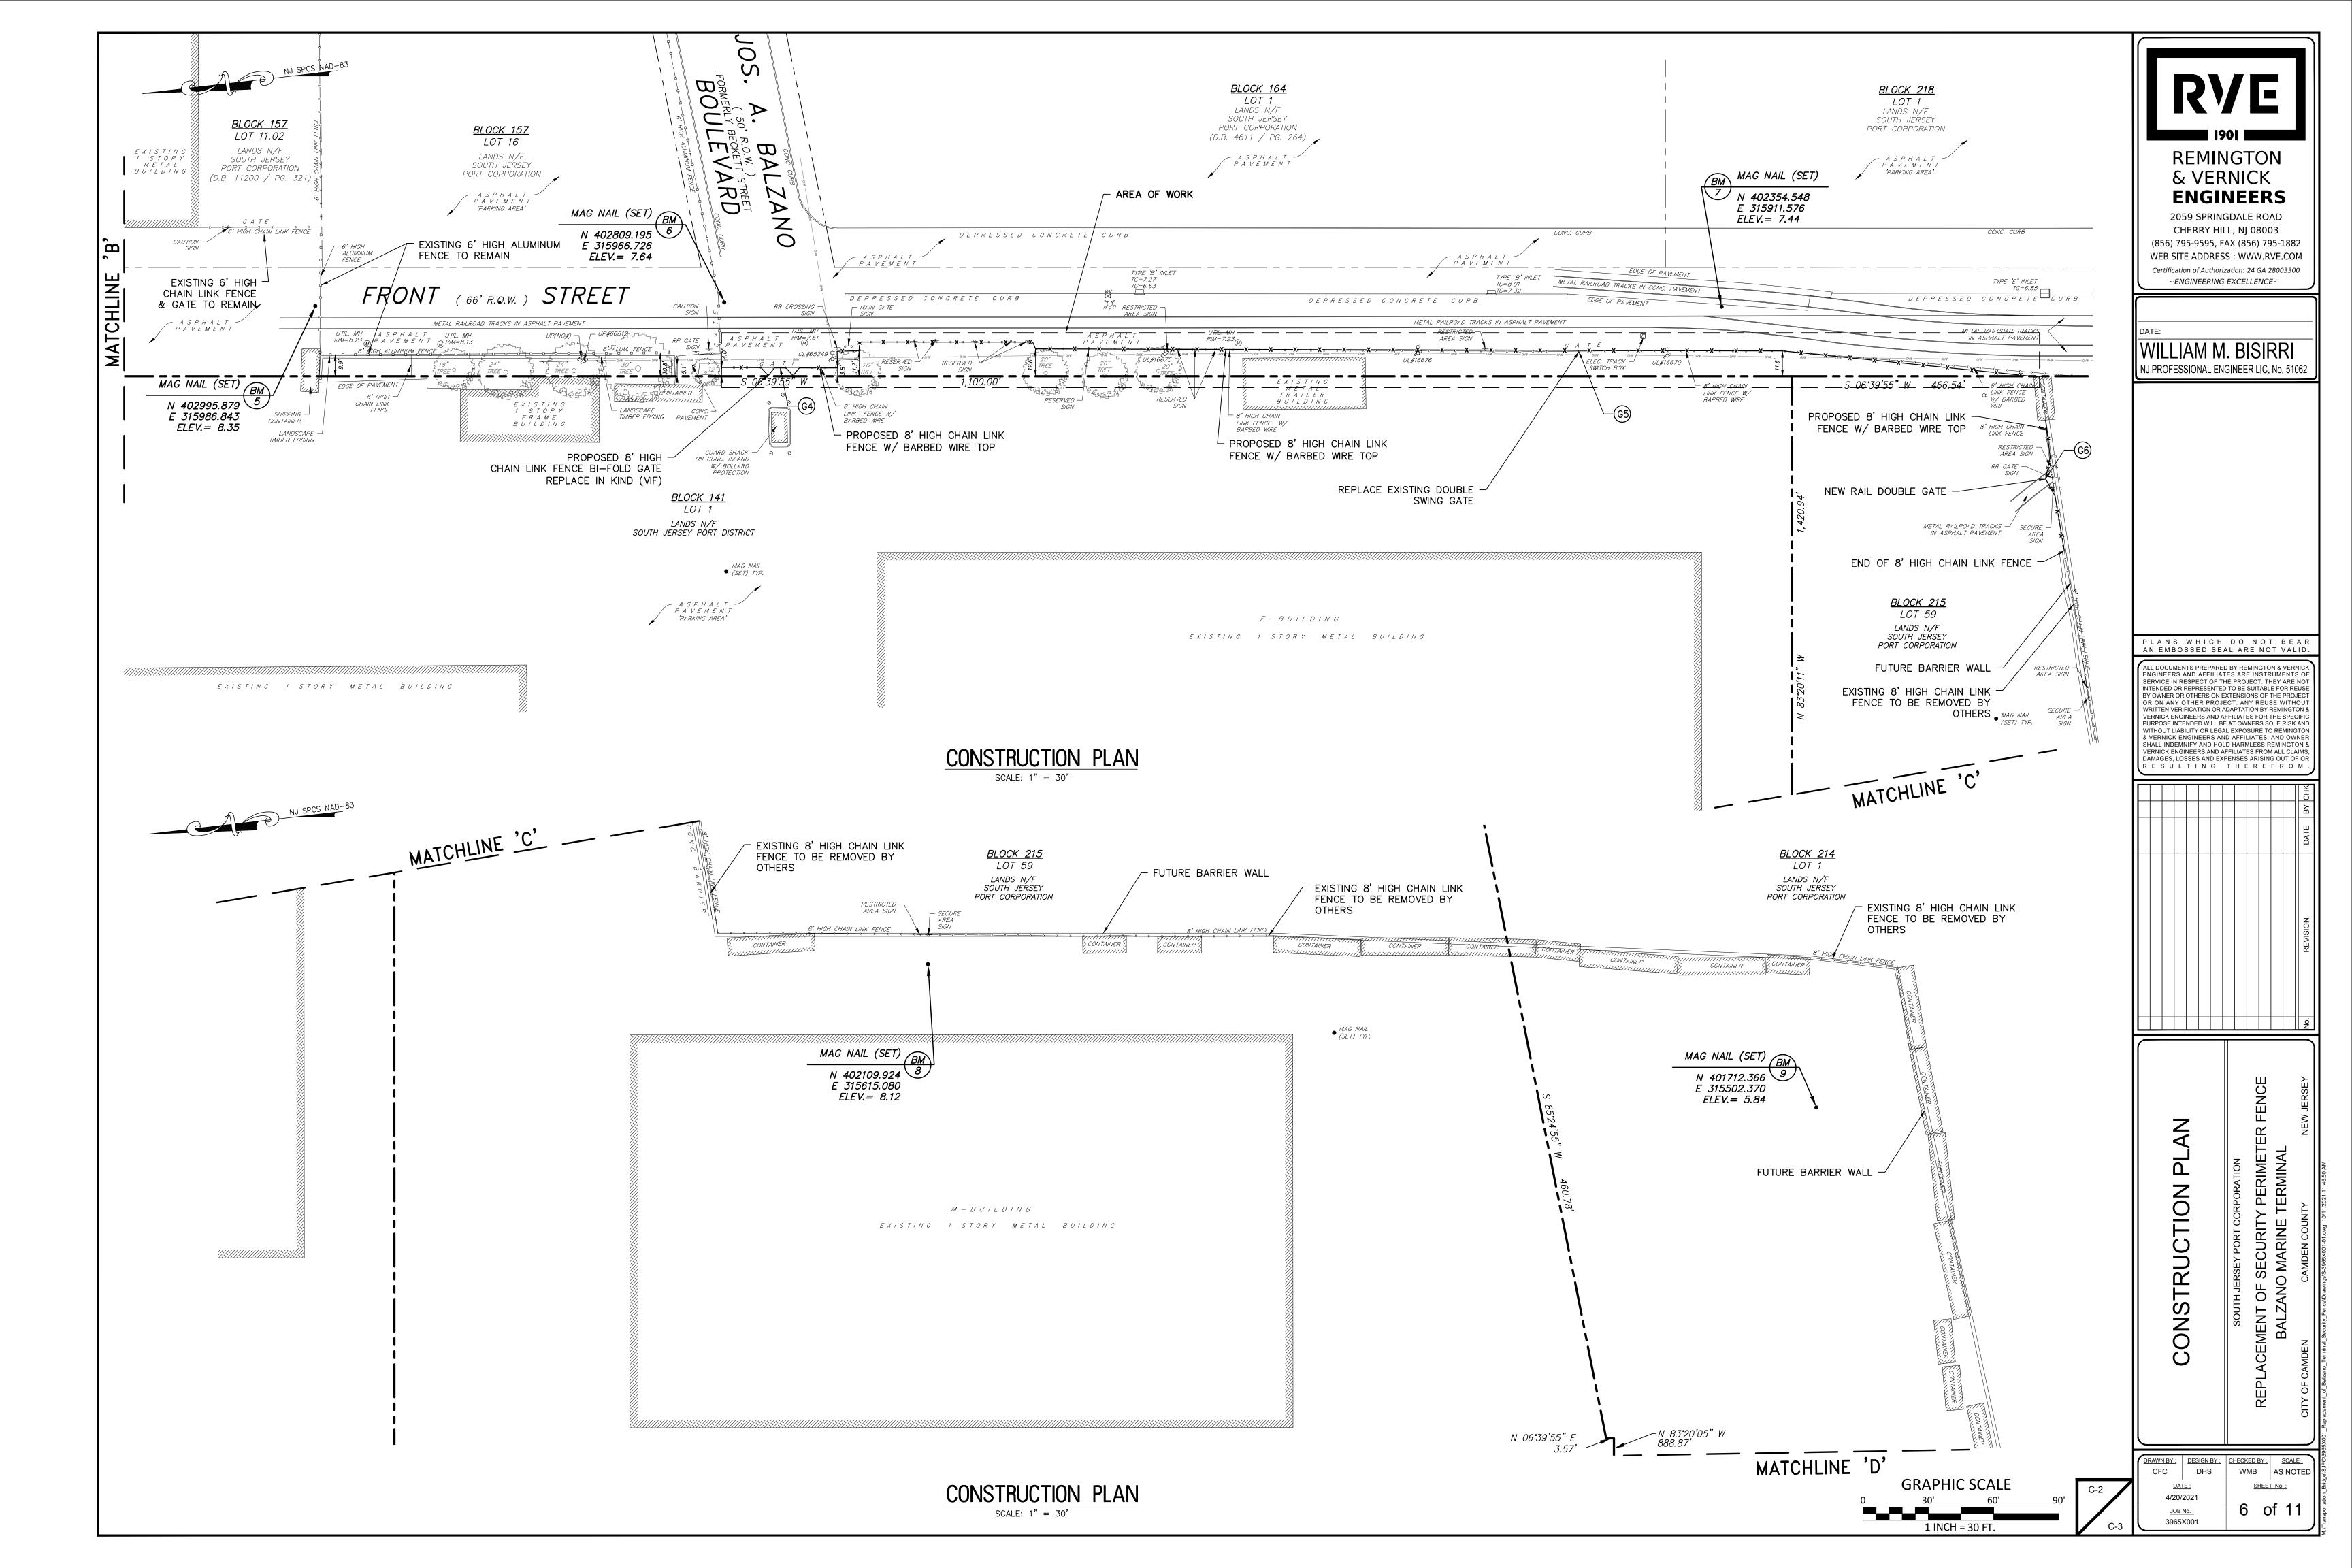

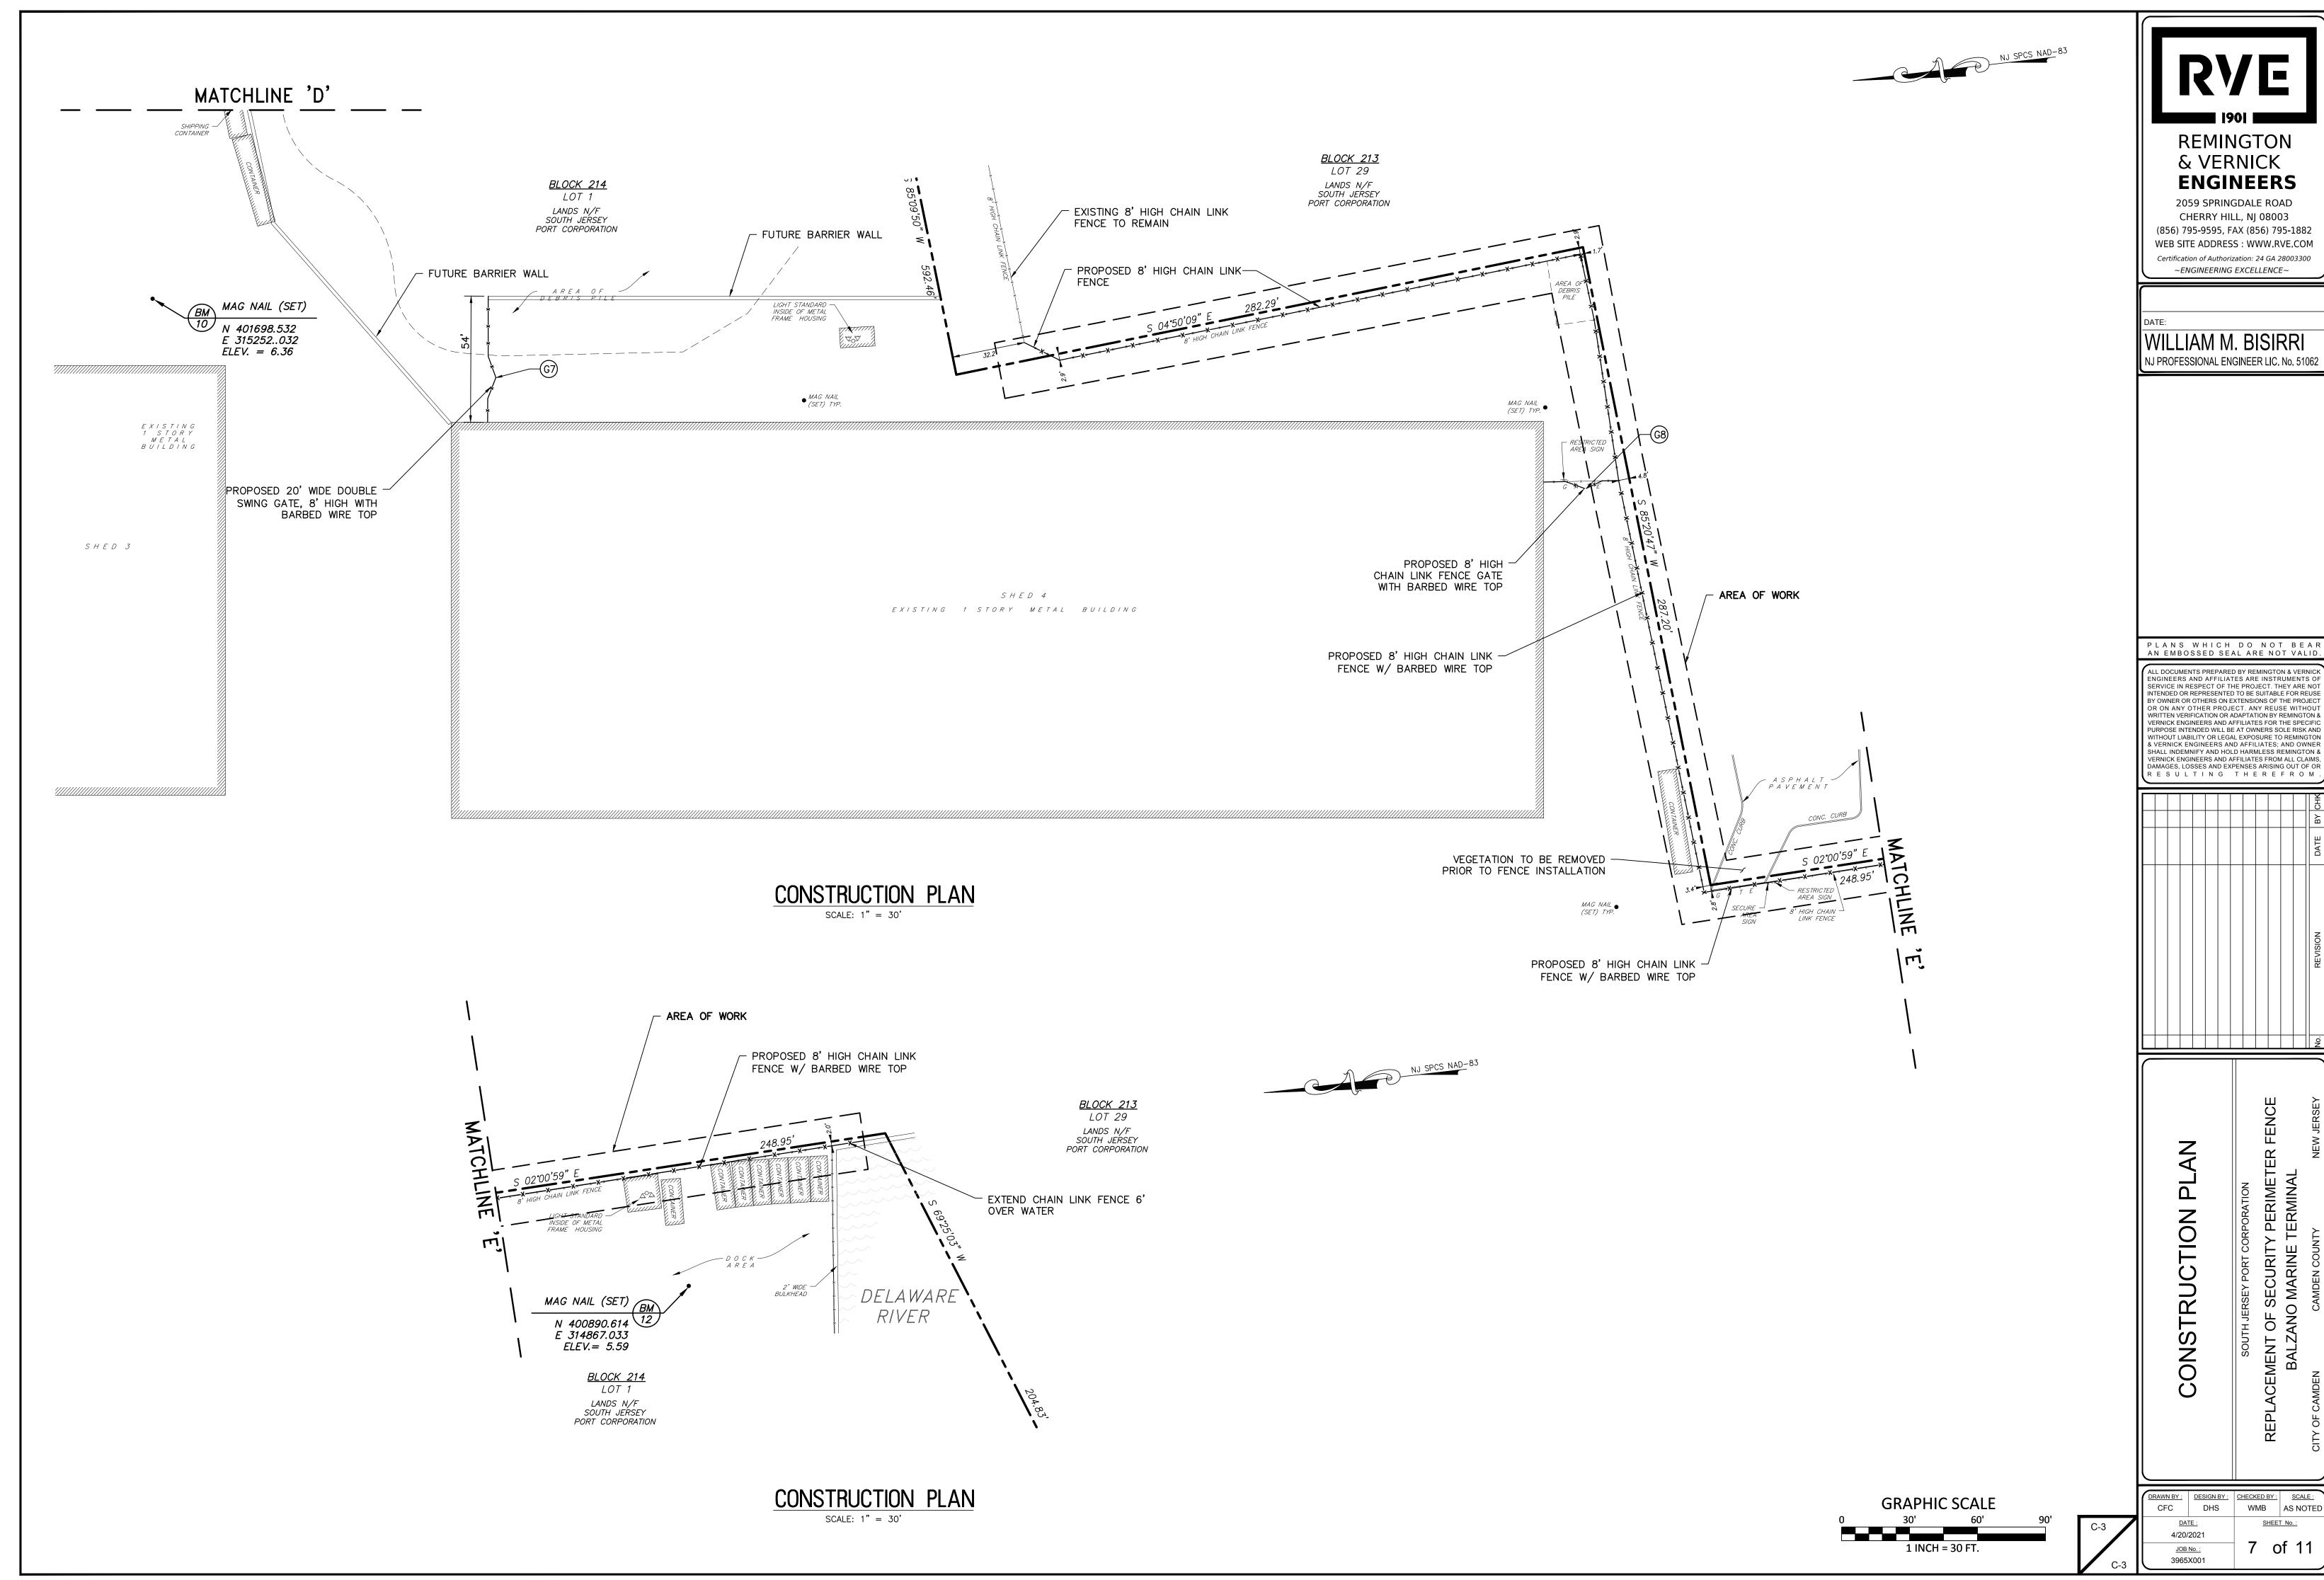


WMB AS NOTED

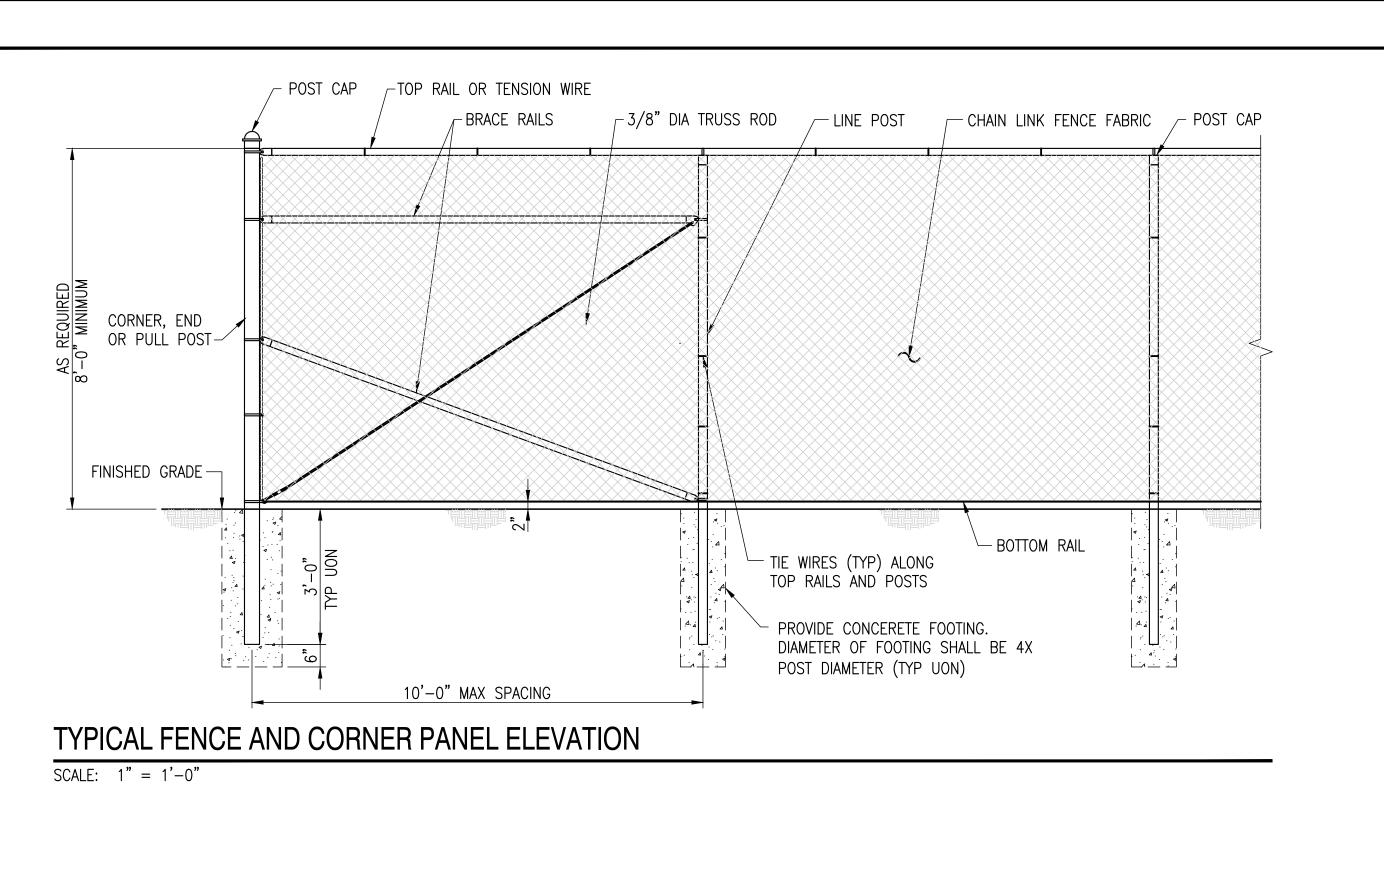

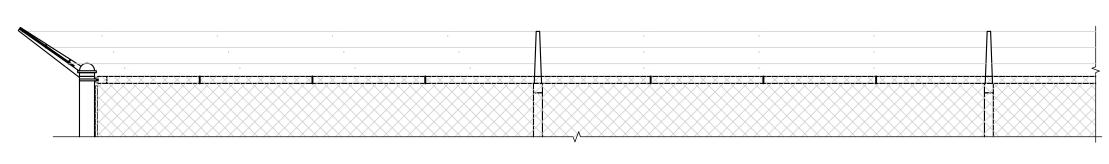

TYPICAL 3 STRAND BARBED WIRE AND SINGLE EXTENSION ARM CONFIGURATION

SCALE: 1" = 1'-0"

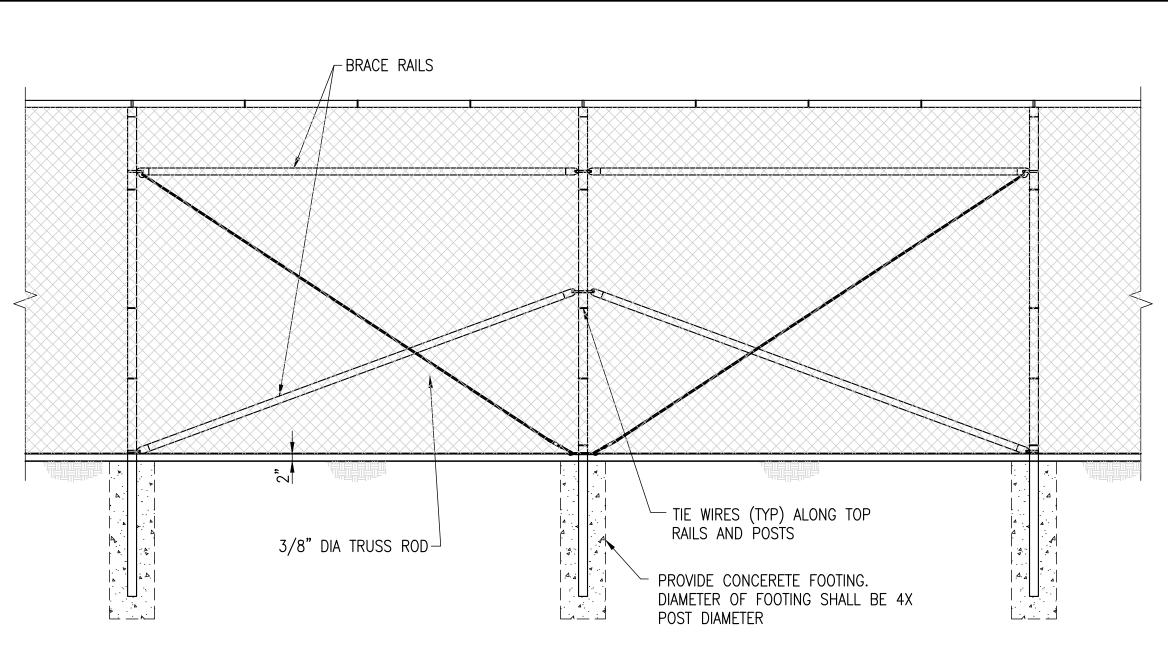


TYPICAL FENCE AND BRACED PANEL ELEVATION

SCALE: 1" = 1'-0"

NOTE (1): A BOTTOM RAIL CAN BE ADDED FOR SECURITY, IT SHALL BE INSTALLED APPROX 3" ABOVE GRADE (A MINIMUM OF 2" AND A MAXIMUM OF 4"). HARDWARE SHALL BE WELDED OR SHOT NAILED TO POSTS AND RAILS IN ORDER TO SECURE IN PLACE. ATTACH FABRIC TO NEW BOTTOM RAIL TO ELIMINATE POSSIBILITY OF PEELING UP FABRIC.

NOTE (2): SOME LOCATIONS MAY REQUIRE 8' OF FABRIC.

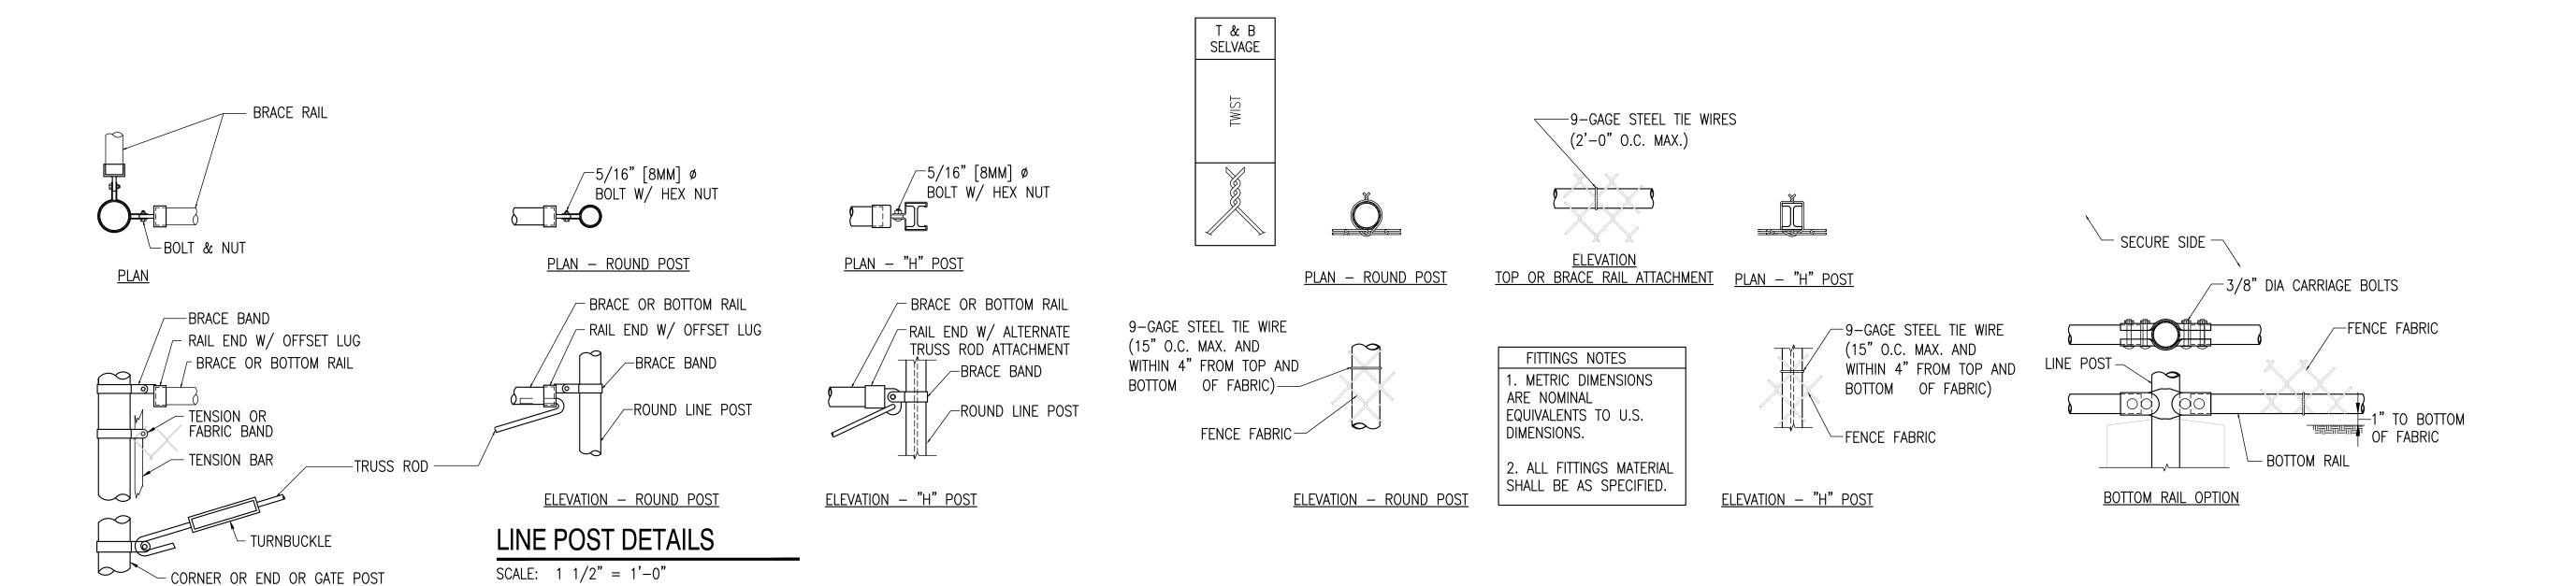

CORNER OR END POSTS

SCALE: $1 \frac{1}{2} = 1'-0"$

ELEVATION

CHAIN-LINK FENCE AND DETAILS

	GRA	PHIC	SCA	ALES
1" = 1'-0"	0	6"	1'	2'
, , ,	0	4"	8"	1'-4"
1 1/2" = 1'-0)"			

 DRAWN BY :
 DESIGN BY :
 CHECKED BY :
 SCALE :

 CFC
 DHS
 WMB
 AS NOTED
 SHEET No.: 4/20/2021 8 of 11 JOB No.: 3965X001

REMINGTON & VERNICK **ENGINEERS** 2059 SPRINGDALE ROAD


CHERRY HILL, NJ 08003 (856) 795-9595, FAX (856) 795-1882 WEB SITE ADDRESS: WWW.RVE.COM


~ENGINEERING EXCELLENCE~

WILLIAM M. BISIRRI NJ PROFESSIONAL ENGINEER LIC. No. 51062

PLANS WHICH DO NOT BEAR AN EMBOSSED SEAL ARE NOT VALID

ENGINEERS AND AFFILIATES ARE INSTRUMENTS O SERVICE IN RESPECT OF THE PROJECT. THEY ARE NO NTENDED OR REPRESENTED TO BE SUITABLE FOR REUS BY OWNER OR OTHERS ON EXTENSIONS OF THE PROJECT WRITTEN VERIFICATION OR ADAPTATION BY REMINGTON VERNICK ENGINEERS AND AFFILIATES FOR THE SPECIFIC PURPOSE INTENDED WILL BE AT OWNERS SOLE RISK ANI WITHOUT LIABILITY OR LEGAL EXPOSURE TO REMINGTOI & VERNICK ENGINEERS AND AFFILIATES; AND OWNE SHALL INDEMNIFY AND HOLD HARMLESS REMINGTON DAMAGES, LOSSES AND EXPENSES ARISING OUT OF OF RESULTING THEREFROM

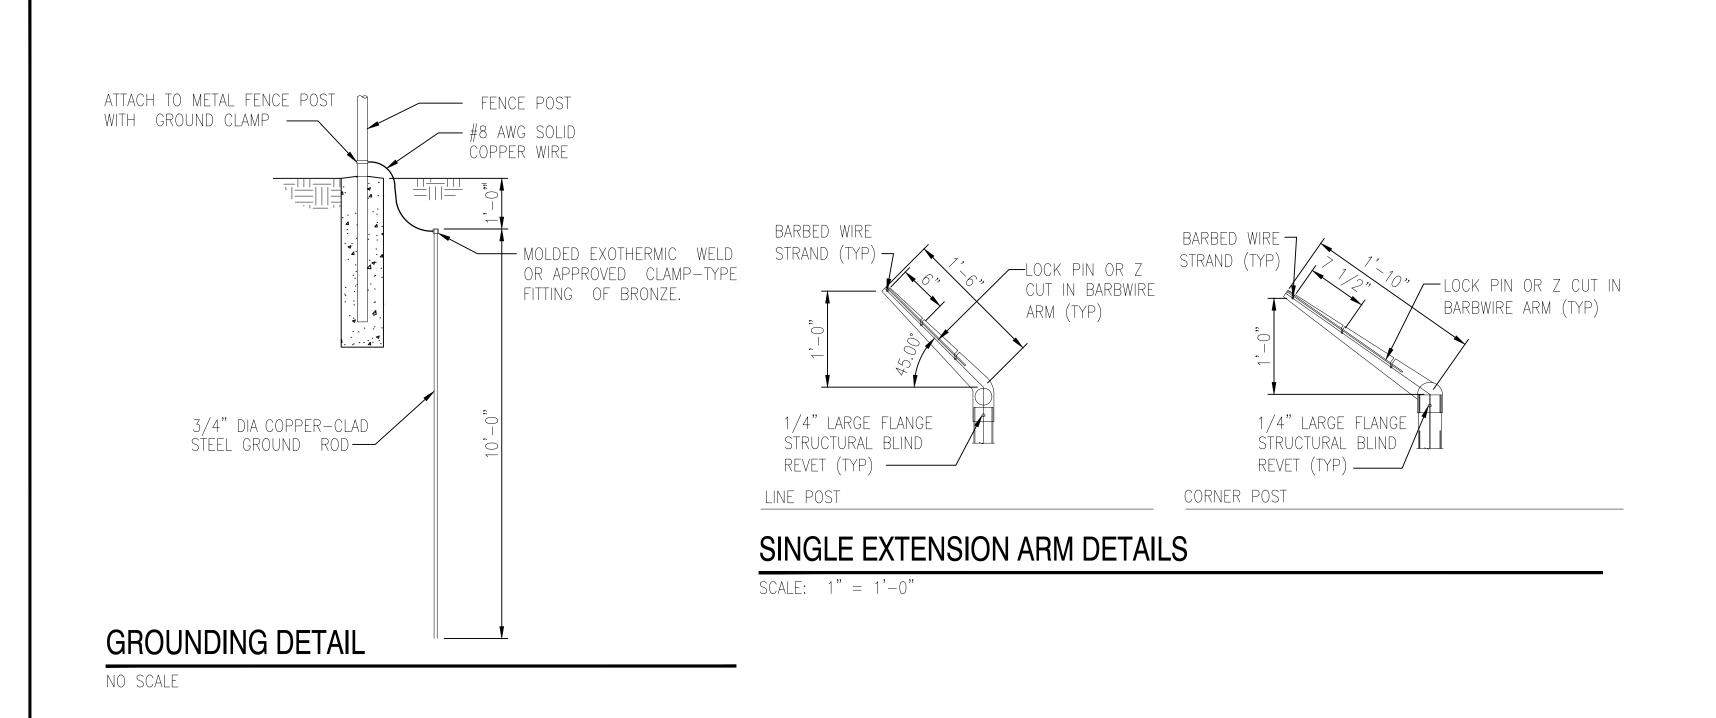

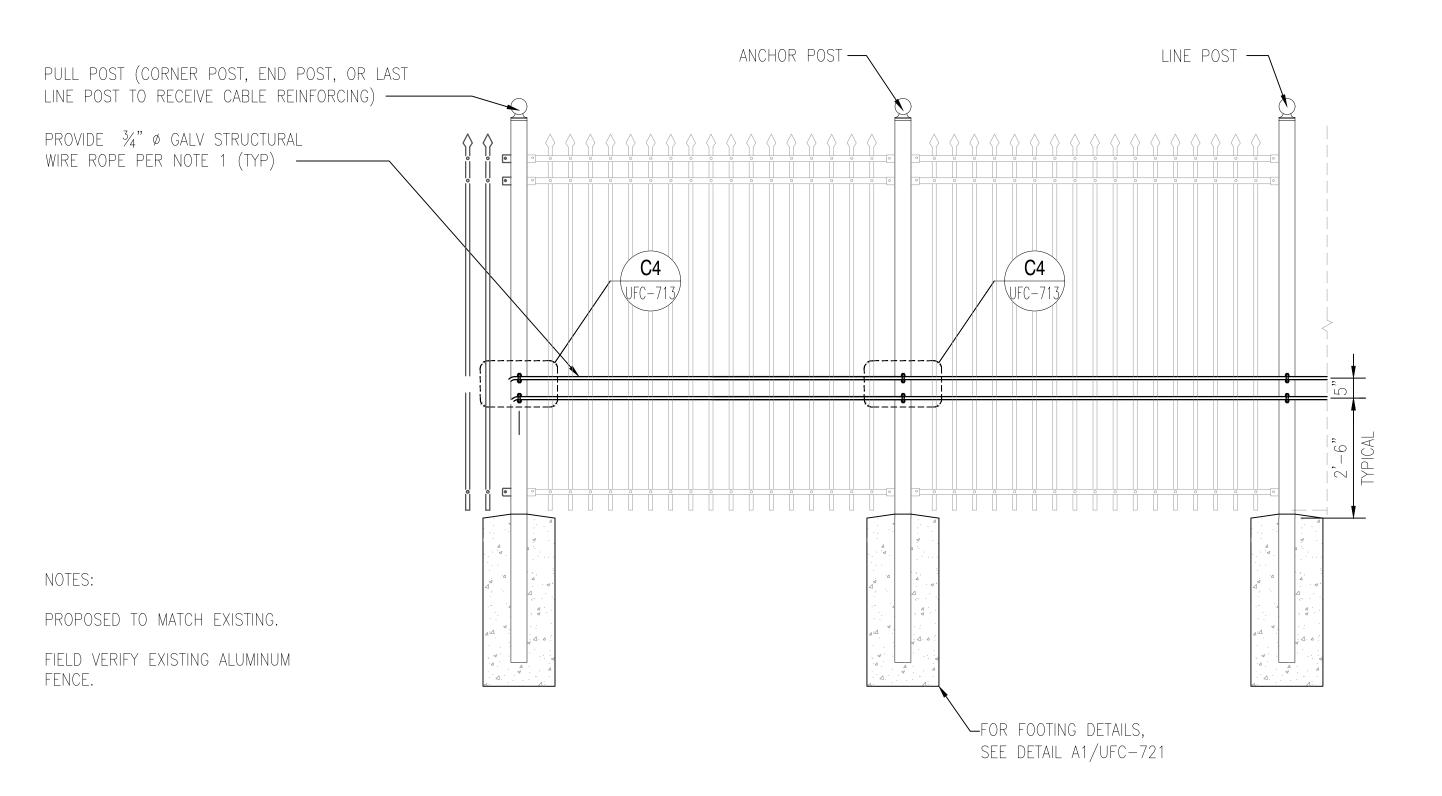

TYPICAL ELEVATION OF ALUMINUM FENCE

SCALE: 1/2" = 1'-0"



REMINGTON & VERNICK ENGINEERS
2059 SPRINGDALE ROAD

CHERRY HILL, NJ 08003

(856) 795-9595, FAX (856) 795-1882

WEB SITE ADDRESS : WWW.RVE.COM


Certification of Authorization: 24 GA 28003300

~ENGINEERING EXCELLENCE~

WILLIAM M. BISIRRI NJ PROFESSIONAL ENGINEER LIC. No. 51062

PLANS WHICH DO NOT BEAR AN EMBOSSED SEAL ARE NOT VALID.

ALL DOCUMENTS PREPARED BY REMINGTON & VERNICK ENGINEERS AND AFFILIATES ARE INSTRUMENTS OF SERVICE IN RESPECT OF THE PROJECT. THEY ARE NOT INTENDED OR REPRESENTED TO BE SUITABLE FOR REUSE BY OWNER OR OTHERS ON EXTENSIONS OF THE PROJECT OR ON ANY OTHER PROJECT. ANY REUSE WITHOUT WRITTEN VERIFICATION OR ADAPTATION BY REMINGTON & VERNICK ENGINEERS AND AFFILIATES FOR THE SPECIFIC PURPOSE INTENDED WILL BE AT OWNERS SOLE RISK AND WITHOUT LIABILITY OR LEGAL EXPOSURE TO REMINGTON & VERNICK ENGINEERS AND AFFILIATES; AND OWNER SHALL INDEMNIFY AND HOLD HARMLESS REMINGTON & VERNICK ENGINEERS AND AFFILIATES FROM ALL CLAIMS, DAMAGES, LOSSES AND EXPENSES ARISING OUT OF OR R E S U L T I N G T H E R E F R O M .

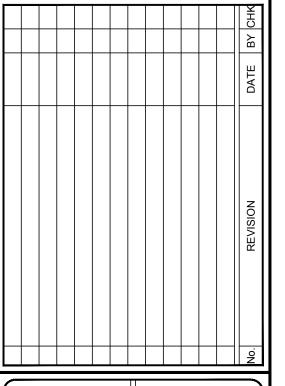

JCTION DETAILS

SOUTH JERSEY PORT CORPORATION

CONSTRU

CHAIN LINK CANTILEVERED GATE DETAILS


BARBED WIRE ARRANGEMENT DETAILS


	GRAF	PHIC	SCA	LES
	0	6"	1'	
1" = 1'-0"		4"	g"	1
$1 \ 1/2" = 1'-0$	Ŭ	4	0	

DRAWN BY: DESIGN BY: CHECKED BY: SCALE:
CFC DHS WMB AS NOTE

DATE: SHEET No.:
4/20/2021

JOB No.: 9 Of 11
3965X001

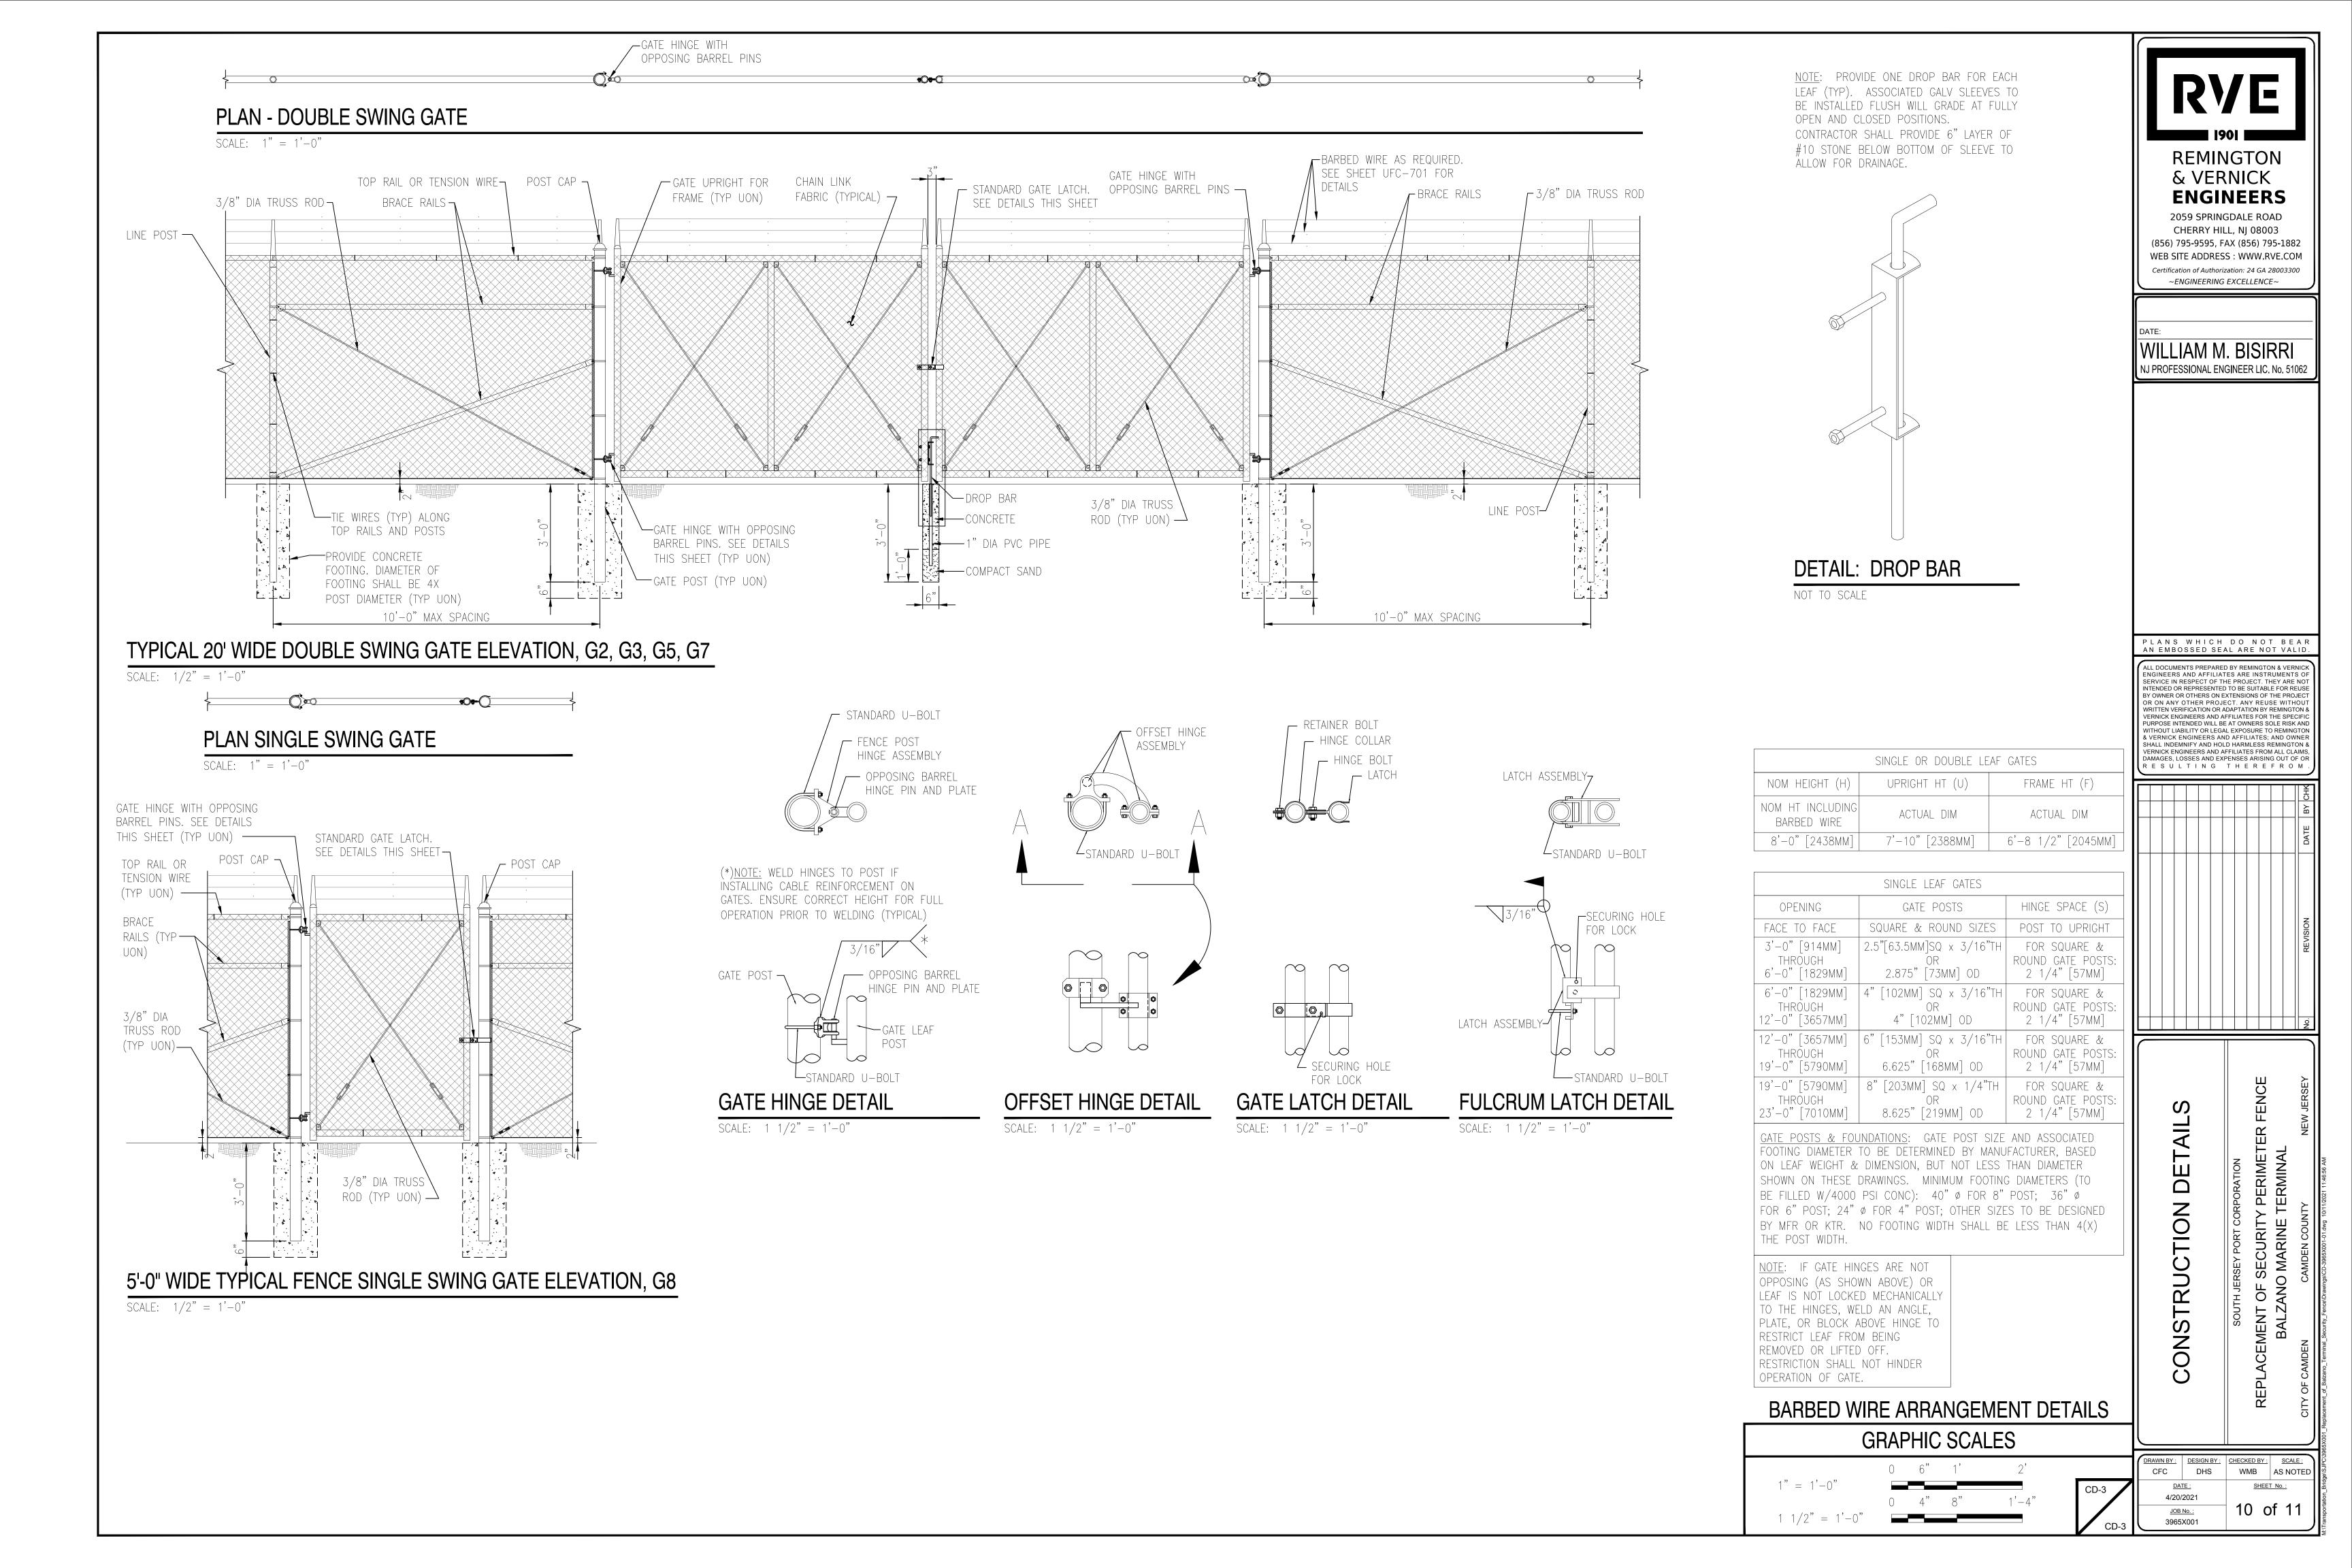

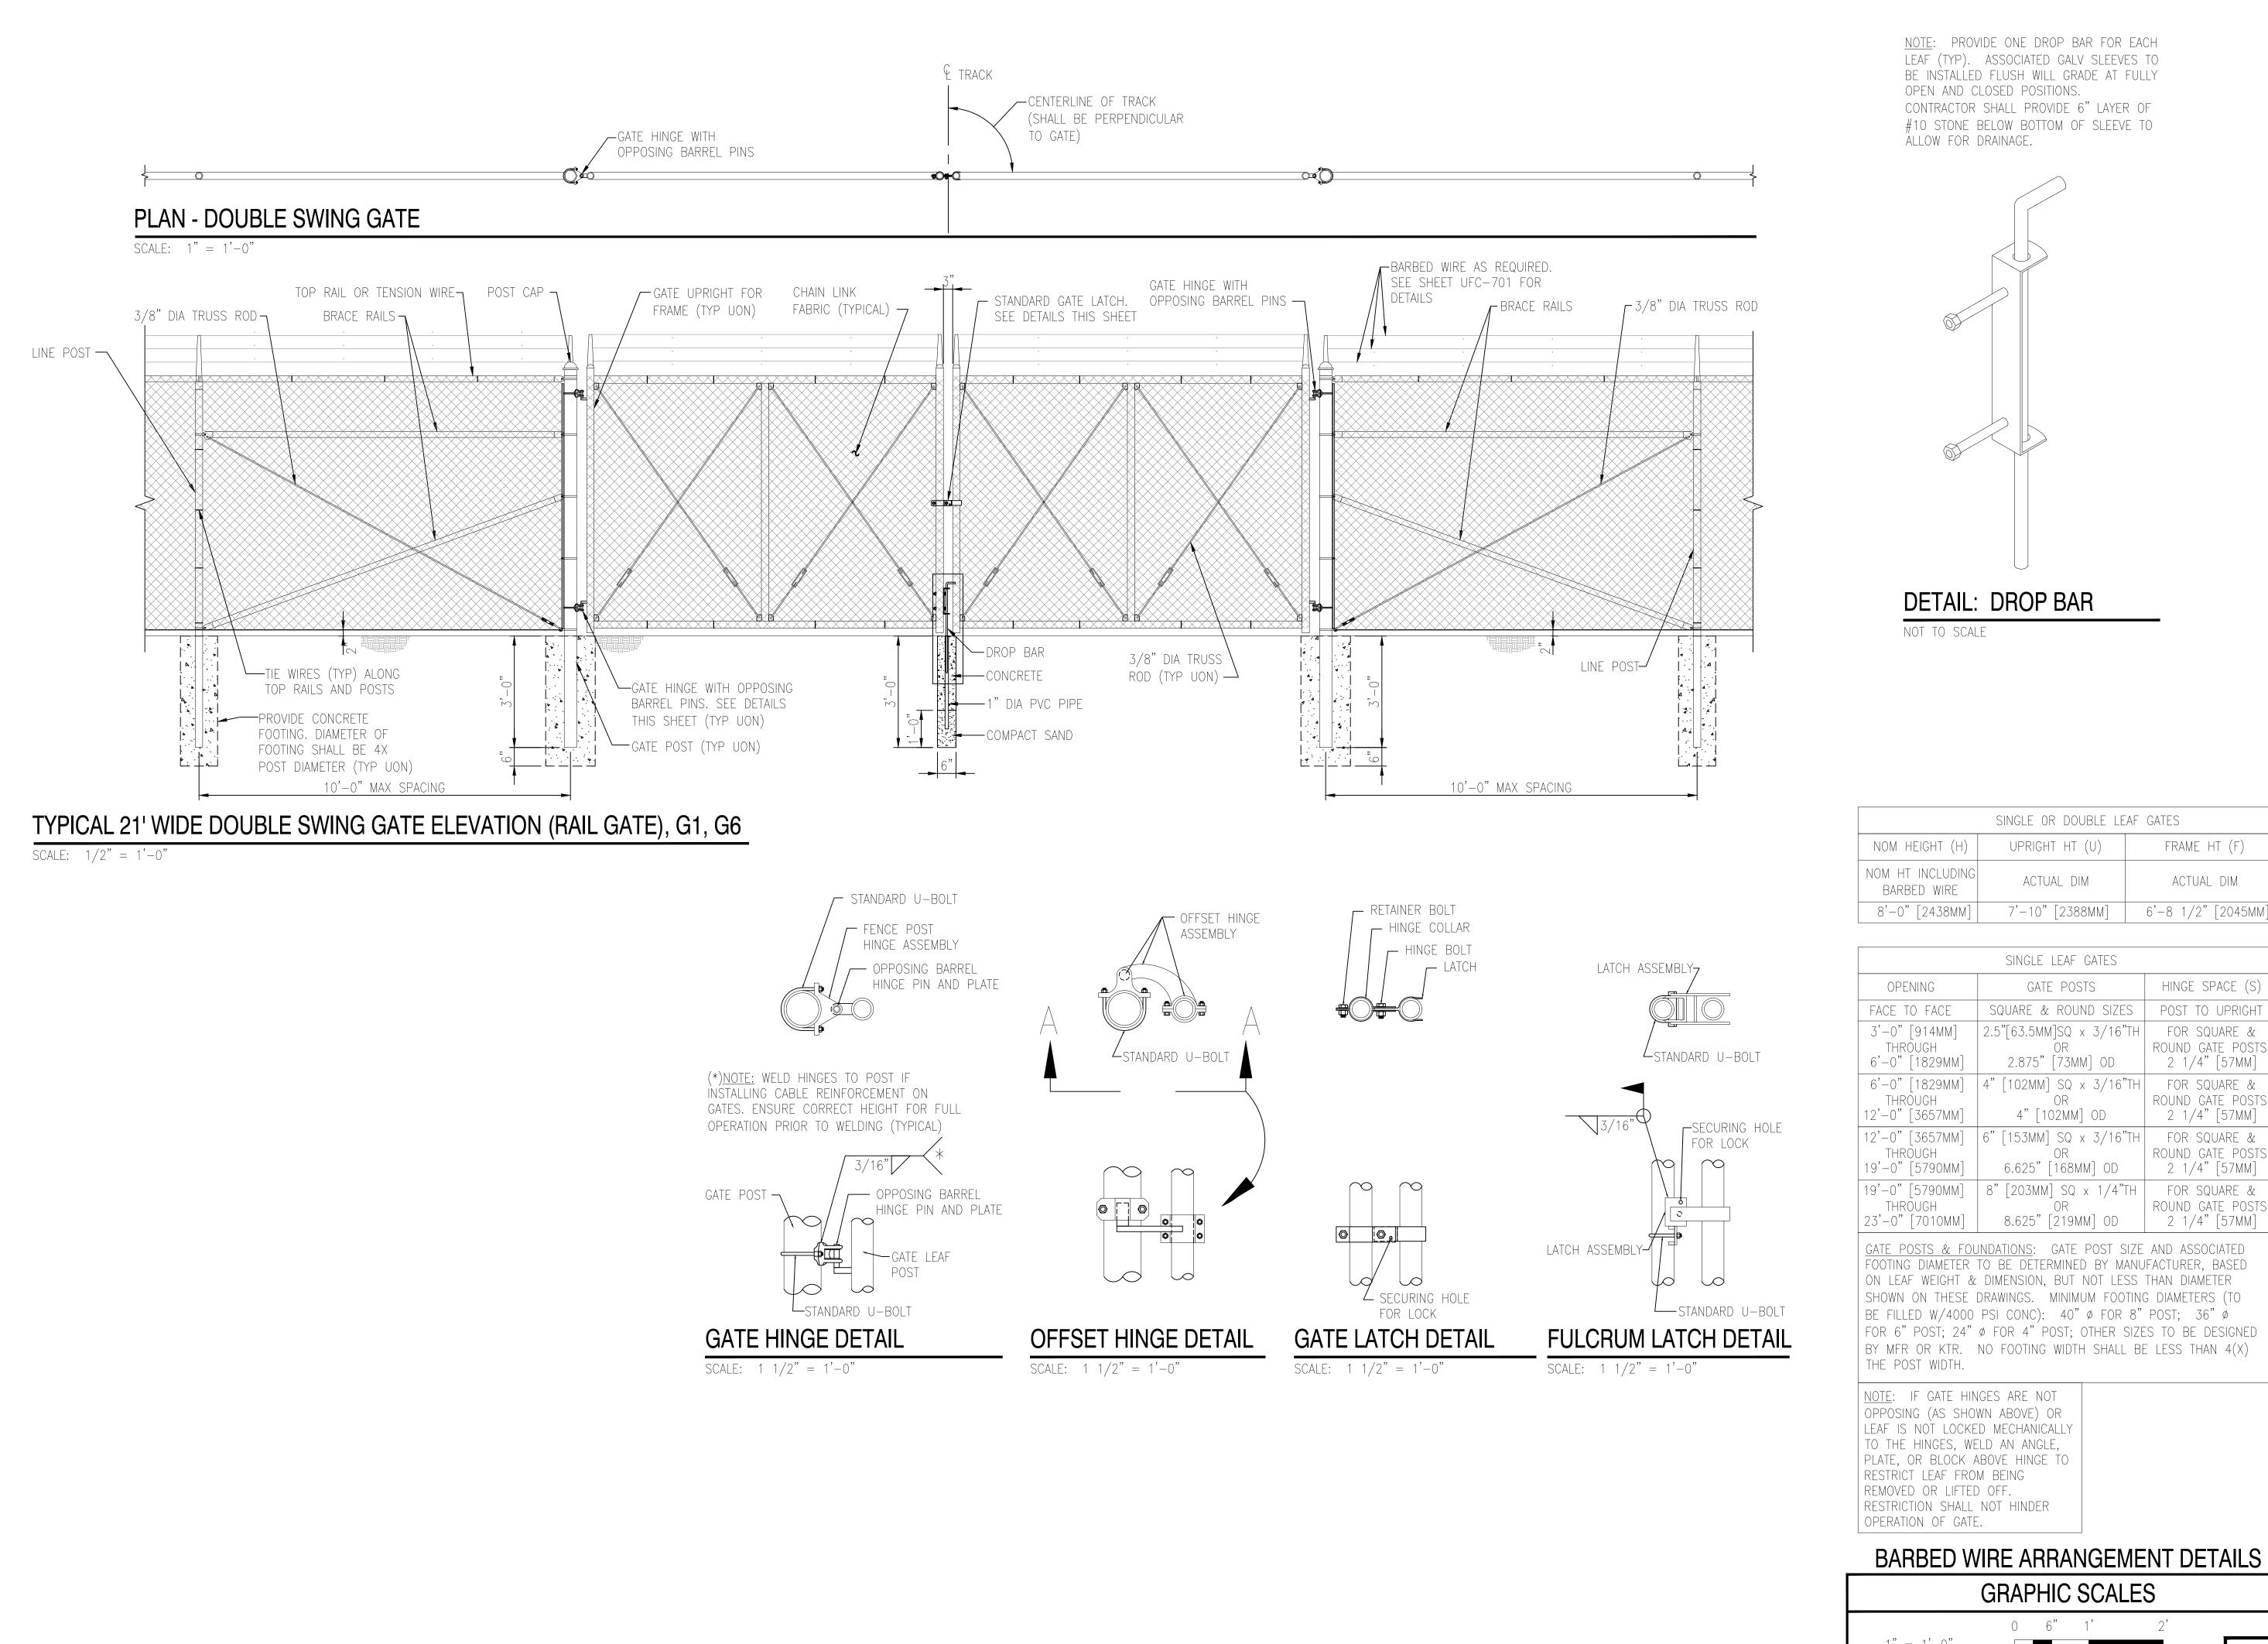

	SINGLE OR DOUBLE LE	TAF GATES
NOM HEIGHT (H)	UPRIGHT HT (U)	FRAME HT (F)
NOM HT INCLUDING BARBED WIRE	ACTUAL DIM	ACTUAL DIM
8'-0" [2438MM]	7'-10" [2388MM]	6'-8 1/2" [2045MM]

	SINGLE LEAF GATES	
OPENING	GATE POSTS	HINGE SPACE (S)
FACE TO FACE	SQUARE & ROUND SIZES	POST TO UPRIGHT
3'-0" [914MM] THROUGH 6'-0" [1829MM]	2.5"[63.5MM]SQ x 3/16"TH OR 2.875" [73MM] OD	FOR SQUARE & ROUND GATE POSTS: 2 1/4" [57MM]
6'-0" [1829MM] THROUGH 12'-0" [3657MM]	4" [102MM] SQ x 3/16"TH OR 4" [102MM] OD	FOR SQUARE & ROUND GATE POSTS: 2 1/4" [57MM]
12'-0" [3657MM] THROUGH 19'-0" [5790MM]	6" [153MM] SQ x 3/16"TH OR 6.625" [168MM] OD	FOR SQUARE & ROUND GATE POSTS: 2 1/4" [57MM]
19'-0" [5790MM] THROUGH 23'-0" [7010MM]	8" [203MM] SQ x 1/4"TH OR 8.625" [219MM] OD	FOR SQUARE & ROUND GATE POSTS: 2 1/4" [57MM]

	αпл	1 110		ILLO
	0	6"	1'	2'
1" = 1'-0"				
	0	4"	8"	1'-4"
$1 \ 1/2$ " = $1'-0$	"			

	DRAWN BY:	DESIGN BY:	CHECKED BY:	SCALE:
	CFC	DHS	WMB	AS NOTE
CD-4	DA ⁻	<u>ΓΕ :</u>	SHEE	T No. :
	4/20/	2021		
	JOB	No. :	11 c	of 11
CD-4	3965	X001		
	-			

EMENT OF SECURITY PERIME BALZANO MARINE TERMINAI

REMINGTON

ENGINEERS

2059 SPRINGDALE ROAD

CHERRY HILL, NJ 08003 (856) 795-9595, FAX (856) 795-1882

WEB SITE ADDRESS: WWW.RVE.COM Certification of Authorization: 24 GA 28003300

~ENGINEERING EXCELLENCE~

WILLIAM M. BISIRRI

NJ PROFESSIONAL ENGINEER LIC. No. 51062

PLANS WHICH DO NOT BEAR AN EMBOSSED SEAL ARE NOT VALID

ALL DOCUMENTS PREPARED BY REMINGTON & VERNIC

ENGINEERS AND AFFILIATES ARE INSTRUMENTS O SERVICE IN RESPECT OF THE PROJECT. THEY ARE NO

NTENDED OR REPRESENTED TO BE SUITABLE FOR REUS

BY OWNER OR OTHERS ON EXTENSIONS OF THE PROJECT

WRITTEN VERIFICATION OR ADAPTATION BY REMINGTON VERNICK ENGINEERS AND AFFILIATES FOR THE SPECIFIC

PURPOSE INTENDED WILL BE AT OWNERS SOLE RISK ANI WITHOUT LIABILITY OR LEGAL EXPOSURE TO REMINGTOI

& VERNICK ENGINEERS AND AFFILIATES; AND OWNE SHALL INDEMNIFY AND HOLD HARMLESS REMINGTON VERNICK ENGINEERS AND AFFILIATES FROM ALL CLAIMS

DAMAGES, LOSSES AND EXPENSES ARISING OUT OF OF RESULTING THEREFROM

& VERNICK