

RAIL INFRASTRUCTURE REHABILITATION


AT

BALZANO MARINE TERMINAL

FOR

SOUTH JERSEY PORT CORPORATION


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VICINITY MAP

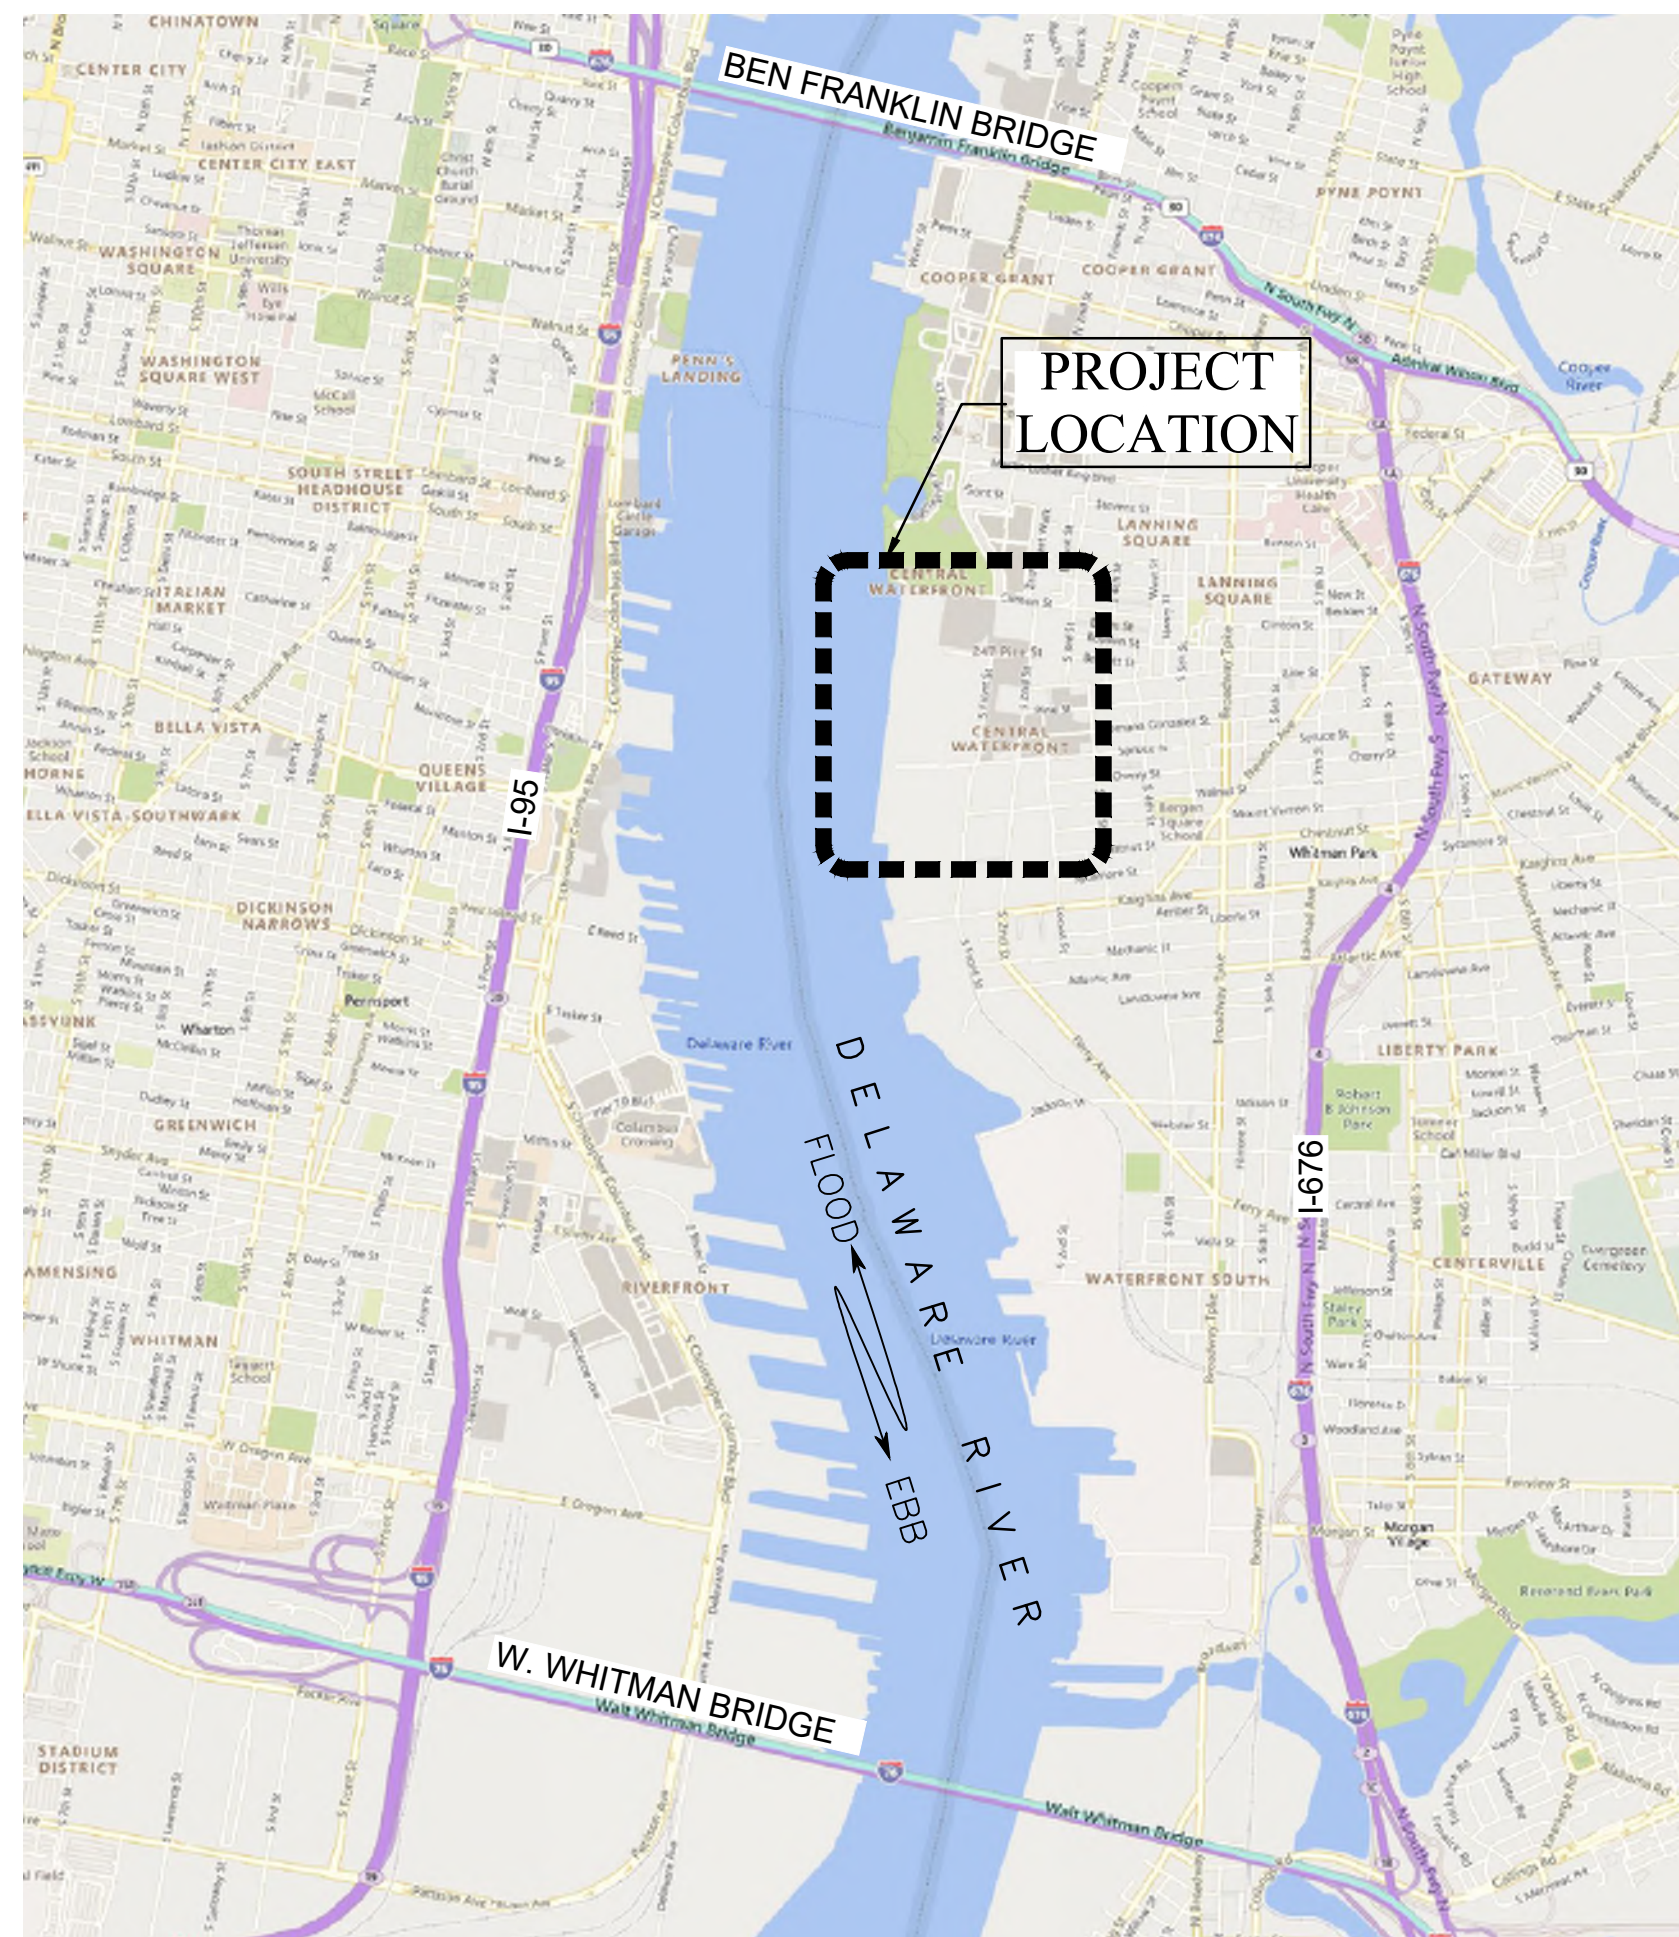

LOCATION MAP



KEY MAP

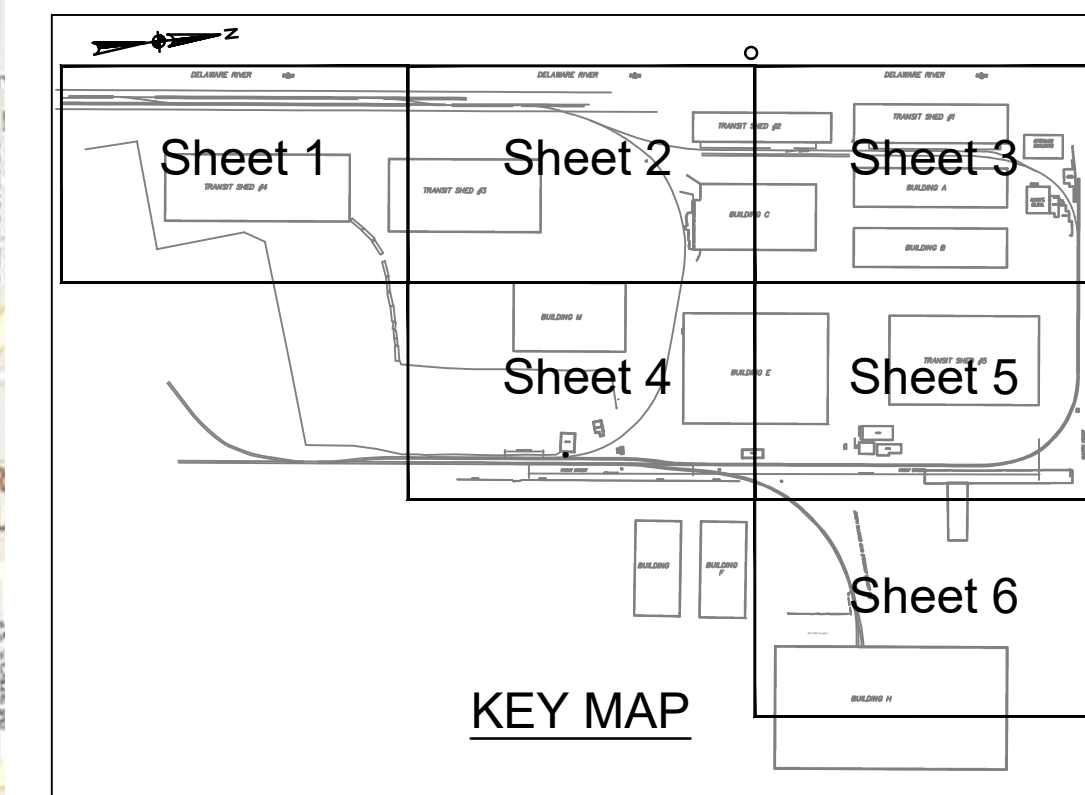URBAN PROJECT NO. 2021500064.000

REV	BY	DATE	DESCRIPTION

<p>SOUTH JERSEY PORT CORP. 101 JOSEPH A. BALZANO BLVD, CAMDEN, NJ 08103 TEL.: (856) 757-4969</p>	ISSUED FOR BID
	<p>URBAN ENGINEERS, INC. 530 Walnut Street Philadelphia, PA 19106 (215) 922-8080 Fax (215) 922-8082</p>
LOCATION: CAMDEN, NJ	
TITLE: SJPC BALZANO MARINE TERMINAL RAIL INFRASTRUCTURE REHABILITATION COVER SHEET	
OWN: FYC	PROJ #: 2021500064.000
DATE: 06/24/2022	DRAWING NUMBER: G-000

GENERAL NOTES:

- DESIGN AND CONSTRUCTION SHALL COMPLY WITH ALL APPLICABLE STATE AND LOCAL CODES AND STANDARDS. THE PROJECT SPECIFICATIONS, AND DRAWINGS. NOTES ON DRAWINGS SHALL TAKE PRECEDENCE OVER PROJECT SPECIFICATIONS. SPECIFIC NOTES ON DETAIL DRAWINGS TAKE PRECEDENCE OVER GENERAL NOTE DRAWINGS. STATE AND LOCAL CODES SHALL TAKE PRECEDENCE OVER PROJECT SPECIFICATIONS AND NOTES ON DRAWINGS.
- THE CONTRACTOR SHALL FIELD VERIFY ALL DIMENSIONS AND EXISTING CONDITIONS PRIOR TO MOBILIZING. ALL EXISTING & PROPOSED DIMENSIONS AND ELEVATIONS SHOWN ON THE DRAWINGS SHALL BE VERIFIED BY THE CONTRACTOR PRIOR TO ANY FABRICATION OR ERECTION. NOTIFY THE ENGINEER OF ANY DISCREPANCIES IMMEDIATELY.
- THE CONTRACTOR SHALL REMOVE FROM THE SITE ALL WASTE MATERIAL, DEMOLISHED MATERIAL AND DEBRIS GENERATED DURING THE COURSE OF THE WORK, U.N.O. DISPOSAL OF ALL GENERATED WASTE MATERIAL, DEMOLISHED MATERIAL AND DEBRIS IS THE CONTRACTOR'S RESPONSIBILITY. DISPOSE OF ALL MATERIAL IN ACCORDANCE WITH APPLICABLE FEDERAL, STATE AND LOCAL RULES AND REGULATIONS.
- THE CONTRACTOR SHALL ABIDE BY ALL APPLICABLE ENVIRONMENTAL PROTECTION STANDARDS, CODES, LAWS, REGULATIONS, AND PERMITS.
- THE CONTRACTOR SHALL CONDUCT HIS OPERATIONS SO AS TO NOT INTERFERE WITH, OR BE DETRIMENTAL TO, VESSEL AND VEHICULAR TRAFFIC DURING THE COURSE OF THE WORK.
- ALL STRUCTURES ARE DESIGNED TO BE SELF-SUPPORTING AND STABLE AFTER ERECTION IS FULLY COMPLETE. IT IS THE RESPONSIBILITY OF THE CONTRACTOR TO DETERMINE ERECTION PROCEDURES AND SEQUENCE AND TO ENSURE THE SAFETY OF THE STRUCTURE AND ITS COMPONENT PARTS DURING ERECTION. THIS INCLUDES THE ADDITION OF WHATEVER SHORING, SHEETING, TEMPORARY BRACING, GUYS OR TIE DOWNS THAT MAY BE NECESSARY. SUCH MATERIAL SHALL REMAIN THE CONTRACTOR'S PROPERTY AFTER COMPLETION OF THE PROJECT.
- THE CONTRACTOR SHALL FOLLOW ALL APPLICABLE SAFETY CODES AND REGULATIONS DURING ALL PHASES OF CONSTRUCTION.
- DESIGN AND CONSTRUCTION SHALL COMPLY WITH ALL APPLICABLE STATE AND LOCAL CODES AND STANDARDS, PROJECT SPECIFICATIONS AND DRAWINGS.
- EXISTING TOPOGRAPHIC FEATURES, GRADE CONTOURS, PROPERTY AND RIGHT-OF-WAY LINES SHOWN WERE TAKEN FROM A PLAN ENTITLED "BOUNDARY AND TOPOGRAPHIC SURVEY FOR BALZANO MARINE TERMINAL PORT OF CAMDEN" PREPARED BY COLLIER'S ENGINEERING & DESIGN DATED MAY 10TH, 2022.
- THE UNDERGROUND UTILITIES SHOWN HAVE BEEN LOCATED FROM FIELD SURVEY INFORMATION AND EXISTING DRAWINGS. THE SURVEYOR MAKES NO GUARANTEES THAT THE UNDERGROUND UTILITIES SHOWN COMPRISE ALL SUCH UTILITIES IN THE AREA, EITHER IN SERVICE OR ABANDONED. THE SURVEYOR FURTHER DOES NOT WARRANT THAT THE UNDERGROUND UTILITIES SHOWN ARE IN THE EXACT LOCATION INDICATED.
- HORIZONTAL DATUM IS BASED ON N.J.S.P.C.S NAD'83. VERTICAL DATUM IS BASED ON NAVD 1988.
- THE CONTRACTOR IS REQUIRED TO NOTIFY THE NEW JERSEY ONE CALL SYSTEM AT 1-800-272-1000 NOT LESS THAN THREE (3) FULL WORKING DAYS PRIOR TO ANY EXCAVATION.
- THE PROPERTY IS LOCATED WITHIN AN AREA HAVING THE FLOOD ZONE DESIGNATION OF ZONE X ON FLOOD INSURANCE MAP ENTITLED "PANEL 0062E, FIRM, FLOOD INSURANCE RATE MAP, CAMDEN COUNTY, NEW JERSEY (ALL JURISDICTIONS), PANEL 62 OF 305" MAP NUMBER 34007C0062E, EFFECTIVE DATE SEPTEMBER 28, 2007.
- CONTRACTOR TO ACCOUNT FOR TIDAL WATERS ON SITE DURING CONSTRUCTION. INLETS MAY SURCHARGE ONTO SITE DURING HIGH TIDE.
- THIS DRAWING WAS MADE WITHOUT THE BENEFIT OF A TITLE REPORT.
- THE CONTRACTOR SHALL SCHEDULE AND CONDUCT ALL CONSTRUCTION TO MINIMIZE EROSION.
- APPROVED EROSION AND SEDIMENTATION CONTROL MEASURES SHALL BE PROVIDED AND MAINTAINED UNTIL ALL WORK IS COMPLETED. E&S PLANS SHALL BE AVAILABLE ON SITE UNTIL CONSTRUCTION IS COMPLETED. THE CONTRACTOR SHALL CONDUCT OPERATIONS TO COMPLY WITH THE APPROVED EROSION AND SEDIMENTATION CONTROL PLAN. IF THE APPROVED PLAN(S) CANNOT BE FOLLOWED, THE CONTRACTOR SHALL OBTAIN WRITTEN APPROVAL OF ALTERNATIVE EROSION AND SEDIMENTATION CONTROLS BY THE APPROPRIATE REGULATORY AGENCY. AT NO TIME SHALL WATER CONTAINING SEDIMENTS OR POLLUTANTS BE DISCHARGED INTO DRAINAGE DITCHES, STORMWATER PIPES OR WATERCOURSES.
- THE CONTRACTOR IS REQUIRED TO PROVIDE ADEQUATE SHEETING, SHORING AND DEWATERING IN ALL TRENCHES AND EXCAVATIONS AS NECESSARY IN ACCORDANCE WITH OSHA; AND IS SOLELY RESPONSIBLE FOR THE SAFETY OF SHEETING, SHORING AND DEWATERING.
- THE CONTRACTOR SHALL REMOVE TREES THAT WILL INTERFERE WITH PROPOSED WORK INCLUDING STUMPS THAT ARE WITHIN THE LIMITS OF CONSTRUCTION. BEFORE REMOVAL OF ANYTHING NOT MARKED FOR REMOVAL ON THE PLANS, OBTAIN APPROVAL FROM THE OWNER.
- CLEAR AND GRUB ALL VEGETATION AND OTHER MISCELLANEOUS ITEMS WITHIN THE LIMITS OF WORK PRIOR TO ANY EARTHMOVING ACTIVITIES.
- IF DISCREPANCIES IN OR OMISSIONS FROM THE CONTRACT DOCUMENTS ARE FOUND, NOTIFY THE ENGINEER IN WRITING IMMEDIATELY. NO CONSIDERATION OR ALLOWANCES WILL BE GRANTED FOR ANY ALLEGED MISUNDERSTANDING OF MATERIAL TO BE FURNISHED OR WORK TO BE PERFORMED.

UTILITY NOTES:

- THE LOCATION OF UNDERGROUND UTILITIES IS TAKEN FROM OWNER RECORDS AND FIELD LOCATION OF VENTS, VALVES, MANHOLES, INLETS, ETC. THE EXTENT AND EXACT LOCATION AND DEPTH OF UNDERGROUND UTILITIES HAS NOT BEEN VERIFIED BY THE OWNER OR ITS REPRESENTATIVE. THE CONTRACTOR SHALL DETERMINE THE EXTENT AND EXACT LOCATION AND DEPTH OF ALL EXISTING PRIVATE AND PUBLIC UTILITIES PRIOR TO COMMENCING WORK. THE CONTRACTOR SHALL BE FULLY RESPONSIBLE FOR ANY AND ALL DAMAGES WHICH MIGHT BE OCCASIONED BY THE CONTRACTOR'S FAILURE TO EXACTLY LOCATE AND PRESERVE ANY AND ALL UNDERGROUND UTILITIES.
- THE CONTRACTOR IS REQUIRED TO NOTIFY THE NEW JERSEY ONE CALL SYSTEM AT 1-800-272-1000 NOT LESS THAN THREE (3) FULL WORKING DAYS PRIOR TO ANY EXCAVATION, AND SHALL PROVIDE WRITTEN NOTICE TO THE OWNER THAT CONTACT HAS BEEN MADE. UTILITIES LOCATED WITHIN THE PROJECT MAY BE PRIVATE AND MAY NOT BE LOCATED BY THE ONE CALL SERVICES. THEREFORE THE CONTRACTOR SHALL BE RESPONSIBLE TO LOCATE THOSE UTILITIES.
- CAUTION: HIGH VOLTAGE LINES MAY EXIST WITHIN THE PROJECT LIMITS. ALL WORK IS TO BE PERFORMED IN CONFORMITY WITH ALL STATE, FEDERAL, UTILITY AND CONTRACT REQUIREMENTS. URBAN ENGINEERS INC. AND THE OWNER HAVE NO CONTROL OVER THE MEANS, METHODS, CHOICE OF EQUIPMENT, SEQUENCING OF AND SAFETY PRACTICES USED OR NOT USED, IN, ON OR AROUND HIGH VOLTAGE LINES OR OTHER UTILITY STRUCTURES, AS THESE ITEMS ARE THE RESPONSIBILITY OF THE PARTIES PHYSICALLY PERFORMING OR CONTROLLING, THE PERFORMANCE OF THE WORK. EXCEPT WHERE ELECTRICAL DISTRIBUTION AND TRANSMISSION LINES HAVE BEEN DEENERGIZED AND VISIBLY DE-ENERGIZED GROUNDED AT THE POINT OF WORK, ASSUME THAT ALL SUCH LINES ARE ENERGIZED AND CONFORM OPERATIONS TO INTER ALIA, TITLE 29 OF THE CODE OF FEDERAL REGULATIONS, SECTION 1926.550(a)(19).
- THE CONTRACTOR SHALL NOTIFY THE OWNER IN ADVANCE FOR ANY WATER SHUT-OFF. NO WATER SHUT-OFF WILL BE ALLOWED UNLESS APPROVAL FROM THE OWNER IS OBTAINED.
- THE CONTRACTOR SHALL PROTECT AND MAINTAIN ALL EXISTING UTILITIES AND/OR TEMPORARILY RELOCATE AND PROPERLY SUPPORT EXISTING UTILITIES AS NECESSARY.
- THE CONTRACTOR SHALL PROVIDE NECESSARY MATERIAL, EQUIPMENT AND MANPOWER IN ORDER TO RESTORE INTERRUPTED OR DAMAGED UTILITY SERVICES 24 HOURS PER DAY UNTIL UTILITY SERVICES HAVE BEEN COMPLETELY RESTORED OR TEMPORARY SERVICES HAVE BEEN DETERMINED SUFFICIENT BY THE ENGINEER.
- THE CONTRACTOR SHALL OBTAIN FROM THE APPROPRIATE UTILITY COMPANY OR CITY DEPARTMENT, VERIFICATION OF THE CURRENT STATUS OF UTILITIES AND STRUCTURES SHOWN ON THE CONTRACT DOCUMENTS PRIOR TO WORKING ON OR NEAR SUCH STRUCTURES AND UTILITIES.

EXISTING LEGEND

- MAJOR CONTOUR
- MINOR CONTOUR
- EXISTING BUILDING OUTLINE
- EXISTING FENCE
- EXISTING OVERHEAD ELECTRIC LINE
- EXISTING STORM LINE
- EXISTING SANITARY SEWER LINE
- EXISTING FIRE WATER LINE
- EXISTING WATER LINE
- EXISTING UTILITY POLE
- EXISTING FIRE HYDRANT
- EXISTING MANHOLE
- EXISTING STORM INLET
- EXISTING DOWNSPOUT

PROPOSED LEGEND

- 5.0 MAJOR CONTOUR
- 4.5 MINOR CONTOUR
- ST PROPOSED STORMWATER LINE
- FW PROPOSED FIREWATER LINE
- EXISTING UTILITY TO BE REMOVED OR ABANDONED
- PROPOSED STORMWATER INLET
- PROPOSED TRACK DRAIN
- PROPOSED FIRE HYDRANT
- PROPOSED WATER VALVE
- PROPOSED BOLLARD
- PROPOSED FLOW ARROW
- PROPOSED CONCRETE
- PROPOSED ASPHALT

ISSUED FOR BID

	URBAN ENGINEERS, INC. 530 Walnut Street Philadelphia, PA 19106 (215) 922-8080 Fax (215) 922-8082	
	LOCATION: CAMDEN, NJ	
TITLE: SJPC BALZANO MARINE TERMINAL RAIL INFRASTRUCTURE REHABILITATION NOTES AND LEGENDS		
DWN: GJB CHK: MJT	PROJ # 2021500064.000 DATE 06/24/2022	DRAWING NUMBER: C-001

REV	BY	DATE	DESCRIPTION

CAMDEN COUNTY SOIL EROSION AND SEDIMENT CONTROL NOTES

- ALL APPLICABLE EROSION AND SEDIMENT CONTROL PRACTICES SHALL BE IN PLACE PRIOR TO ANY GRADING OPERATION AND/OR INSTALLATION OF PROPOSED STRUCTURES OR UTILITIES.
- SOIL EROSION AND SEDIMENT CONTROL PRACTICES ON THIS PLAN SHALL BE CONSTRUCTED IN ACCORDANCE WITH THE STANDARDS FOR SOIL EROSION AND SEDIMENT CONTROL IN NEW JERSEY.
- APPLICABLE EROSION AND SEDIMENT CONTROL PRACTICES SHALL BE LEFT IN PLACE UNTIL CONSTRUCTION IS COMPLETED AND/OR THE AREA IS STABILIZED.
- THE CONTRACTOR SHALL PERFORM ALL WORK, FURNISH ALL MATERIALS AND INSTALL ALL MEASURES REQUIRED TO REASONABLY CONTROL SOIL EROSION RESULTING FROM CONSTRUCTION OPERATIONS AND PREVENT EXCESSIVE FLOW OF SEDIMENT FROM THE CONSTRUCTION SITE.
- ANY DISTURBED AREA THAT IS TO BE LEFT EXPOSED FOR MORE THAN THIRTY (30) DAYS AND NOT SUBJECT TO CONSTRUCTION TRAFFIC SHALL IMMEDIATELY RECEIVE A TEMPORARY SEEDING AND FERTILIZATION IN ACCORDANCE WITH THE NEW JERSEY STANDARDS AND THEIR RATES SHOULD BE INCLUDED IN THE NARRATIVE. IF THE SEASON PROHIBITS TEMPORARY SEEDING, THE DISTURBED AREAS WILL BE MULCHED WITH SALT HAY OR EQUIVALENT AND ANCHORED IN ACCORDANCE WITH THE NEW JERSEY STANDARDS (I.E. PEG AND TWINE, MULCH NETTING OR LIQUID MULCH BINDER).
- IT SHALL BE THE RESPONSIBILITY OF THE DEVELOPER TO PROVIDE CONFIRMATION OF LIME, FERTILIZER AND SEED APPLICATION AND RATES OF APPLICATION AT THE REQUEST OF THE CAMDEN COUNTY SOIL CONSERVATION DISTRICT.
- ALL CRITICAL AREAS SUBJECT TO EROSION WILL RECEIVE A TEMPORARY SEEDING IN COMBINATION WITH STRAW MULCH AT A RATE OF 2 TONS PER ACRE, ACCORDING TO THE NEW JERSEY STANDARDS IMMEDIATELY FOLLOWING ROUGH GRADING.
- THE SITE SHALL AT ALL TIMES BE GRADED AND MAINTAINED SUCH THAT ALL STORMWATER RUNOFF IS DIVERTED TO SOIL EROSION AND SEDIMENT CONTROL FACILITIES.
- ALL SEDIMENTATION STRUCTURES WILL BE INSPECTED AND MAINTAINED ON A REGULAR BASIS AND AFTER EVERY STORM EVENT.
- A CRUSHED STONE, TIRE CLEANING PAD WILL BE INSTALLED WHEREVER A CONSTRUCTION ACCESS EXISTS. THE STABILIZED PAD WILL BE INSTALLED ACCORDING TO THE STANDARD FOR STABILIZED CONSTRUCTION ACCESS
- ALL DRIVEWAYS MUST BE STABILIZED WITH 2 1/2" CRUSHED STONE OR SUBBASE PRIOR TO INDIVIDUAL LOT CONSTRUCTION.
- PAVED ROADWAYS MUST BE KEPT CLEAN AT ALL TIMES.
- ALL CATCH BASIN INLETS WILL BE PROTECTED ACCORDING TO THE CERTIFIED PLAN.
- ALL DEWATERING OPERATIONS MUST DISCHARGE DIRECTLY INTO A SEDIMENT FILTER AREA. THE SEDIMENT FILTER SHOULD BE COMPOSED OF A SUITABLE SEDIMENT FILTER FABRIC.
- OFFSITE SEDIMENT DISTURBANCE MAY REQUIRE ADDITIONAL CONTROL MEASURES TO BE DETERMINED BY THE EROSION CONTROL INSPECTOR.
- ANY CONVEYANCE OF THIS PROJECT PRIOR TO ITS COMPLETION WILL TRANSFER FULL RESPONSIBILITY FOR COMPLIANCE WITH THE CERTIFIED PLAN TO ANY SUBSEQUENT OWNERS.
- METHODS FOR THE MANAGEMENT OF HIGH ACID PRODUCING SOILS SHALL BE IN ACCORDANCE WITH THE STANDARDS. HIGH ACID PRODUCING SOILS ARE THOSE FOUND TO CONTAIN IRON SULFIDES OR HAVE A pH OF 4 OR LESS.
- TEMPORARY AND PERMANENT SEEDING MEASURES MUST BE APPLIED ACCORDING TO THE NEW JERSEY STANDARDS, AND MULCHED WITH SALT HAY OR EQUIVALENT AND ANCHORED IN ACCORDANCE WITH THE NEW JERSEY STANDARDS (I.E. PEG AND TWINE, MULCH NETTING OR LIQUID MULCH BINDER).
- MAXIMUM SIDE SLOPES OF ALL EXPOSED SURFACES SHALL NOT BE CONSTRUCTED STEEPER THAN 3:1 UNLESS OTHERWISE APPROVED BY THE DISTRICT.
- DUST IS TO BE CONTROLLED BY AN APPROVED METHOD ACCORDING TO THE NEW JERSEY STANDARDS AND MAY INCLUDE WATERING WITH A SOLUTION OF CALCIUM CHLORIDE AND WATER.
- ADJOINING PROPERTIES SHALL BE PROTECTED FROM EXCAVATION AND FILLING OPERATIONS ON THE PROPOSED SITE.
- USE STAGED CONSTRUCTION METHODS TO MINIMIZE EXPOSED SURFACES, WHERE APPLICABLE.
- ALL VEGETATIVE MATERIAL SHALL BE SELECTED IN ACCORDANCE WITH AMERICAN STANDARDS FOR NURSERY STOCK OF THE AMERICAN ASSOCIATION OF THE NURSERYMEN AND IN ACCORDANCE WITH THE NEW JERSEY STANDARDS.
- THE SOIL EROSION INSPECTOR MAY REQUIRE ADDITIONAL SOIL EROSION MEASURES TO BE INSTALLED, AS DIRECTED BY THE DISTRICT INSPECTOR.

MAINTENANCE PROGRAM FOR SEDIMENT AND EROSION CONTROL:

THE CONTRACTOR IS RESPONSIBLE FOR MAINTAINING ALL EROSION CONTROL FACILITIES DURING CONSTRUCTION. ALL DAMAGED FACILITIES WILL BE REPAIRED WITHIN 24 HOURS. THE CONTRACTOR WILL NOT REMOVE ANY CONTROL FACILITY UNTIL DIRECTED BY THE ENGINEER. MATERIALS USED FOR EROSION CONTROL WILL BE DISPOSED OF OFF-SITE WHEN REMOVED. SUCH MATERIALS ARE CONSIDERED PROPERTY OF THE CONTRACTOR.

STABILIZED CONSTRUCTION ENTRANCE:

- THE STRUCTURE'S THICKNESS WILL BE CONSTANTLY MAINTAINED TO THE SPECIFIED DIMENSIONS BY ADDING ROCK. A STOCKPILE OF ROCK MATERIAL WILL BE MAINTAINED ON THE SITE FOR THIS PURPOSE.
- AT THE END OF EACH CONSTRUCTION DAY, ALL SEDIMENT DEPOSITED ON PUBLIC ROADWAYS WILL BE REMOVED BY USE OF A VACUUM TYPE ROAD SWEEPER AND RETURNED TO THE CONSTRUCTION SITE.

COMPOST FILTER SOCK:

- THE LOG INSTALLATION SHALL BE INSPECTED WEEKLY, BEFORE ANY ANTICIPATED PRECIPITATION EVENT, AND AFTER ALL PRECIPITATION EVENTS. ANY NECESSARY REPAIRS WILL BE MADE IMMEDIATELY.
- ACCUMULATED SEDIMENTS SHALL BE REMOVED AS REQUIRED TO KEEP THE SOCK FUNCTIONAL. IN ALL CASES REMOVE DEPOSITS WHERE ACCUMULATIONS REACH 1/2 THE ABOVE-GROUND HEIGHT OF THE LOG.
- ALL UNDERCUTTING OR EROSION OF THE TOE ANCHOR WILL BE REPAIRED IMMEDIATELY WITH COMPACTED BACKFILL MATERIALS.

SOIL STOCKPILES:

- INSPECT SOIL STOCKPILES MONTHLY.
- RESEED TO ESTABLISH GRASS COVER.

SEEDING AND MULCHING OF DISTURBED AREAS AND NEW SLOPES:

- FOLLOW TEMPORARY AND PERMANENT SEEDING SPECIFICATION GUIDELINES.
- DISTURBED AREAS AND NEW SLOPES SHALL BE INSPECTED WEEKLY AND AFTER EVERY RAIN EVENT.
- MISSING MULCH SHALL BE REPLACED. RESEED AND MULCH UNTIL THE ESTABLISHMENT OF GOOD GRASS COVER.


PUMPED WATER FILTER BAG:

- PUMPED WATER FILTERS SHALL BE INSPECTED WEEKLY AND AFTER EACH RAIN EVENT.
- SEDIMENT SHALL BE REMOVED WHEN IT REACHES THE CLEAN-OUT LEVEL ON THE MARKER AND REMOVE OTHER DEBRIS WHICH COULD IMPAIR THE FUNCTION OF THE FILTER.

CIVIL/STRUCTURAL ABBREVIATIONS

ACI = AMERICAN CONCRETE INSTITUTE	LB = POUND
ACD = ADMIRALTY CHART DATUM	LLV = LONG LEG VERTICAL
AISC = AMERICAN INSTITUTE OF STEEL CONSTRUCTION	NS = NEAR SIDE
ALT = ALTERNATE	LF = LINEAR FEET
ANSI = AMERICAN NATIONAL STANDARDS INSTITUTE	LG = LONG
APPROX= APPROXIMATE	M = METERS
ASTM = AMERICAN SOCIETY OF TESTING AND MATERIALS	mm = MILLIMETERS
AWS = AMERICAN WELDING SOCIETY	MAX = MAXIMUM
B.O.P. = BOTTOM OF PIPE	MEA = MEASURED
B/B = BACK TO BACK	MH = MANHOLE
BC = BOTTOM OF CURB	MHHW = MEAN HIGHER HIGH WATER
BIT. = BITUMINOUS	MHW = MEAN HIGH WATER
BW = BOTTOM OF WALL	MIN = MINIMUM
C = CHANNEL	MISC = MISCELLANEOUS
C/C = CENTER TO CENTER	MLLW = MEAN LOWER LOW WATER
CF = CUBIC FEET	MLW = MEAN LOW WATER
CIP = CAST IRON PIPE	MPa = MEGAPASCALS
CJ = CONSTRUCTION JOINT	MPH = MILES PER HOUR
CLR = CLEAR	MSL = MEAN SEA LEVEL
CO = CLEAN OUT	N = NORTH
CONC = CONCRETE	NIC = NOT IN CONTRACT
CONST = CONSTRUCTION	NTS = NOT TO SCALE
CONT = CONTINUOUS	NO. = NUMBER
D = DEPTH	O.C. = ON CENTER
D/R = DOWN RIVER	PVC = POLYVINYL CHLORIDE
DC = DROP CURB	R/F = REINFORCING
DEG = DEGREES	R.C.P. = REINFORCED CONCRETE PIPE
DET'L'S = DETAILS	REQ'D = REQUIRED
DFM = DIESEL FUEL MARINE	S = SOUTH
DIA = DIAMETER	SAN = SANITARY
DIST = DISTANCE	SCH = SCHEDULE
DOD = DEPARTMENT OF DEFENSE	SECT = SECTION
EA = EACH	SHT = SHEET
EF = EACH FACE	SIM = SIMILAR
EHW = EXTREME HIGH WATER	SPEC = SPECIFICATION
EL = ELEVATION (NAVD'88)	SQ = SQUARE
ELEC = ELECTRICAL	SS = STAINLESS STEEL
ETC = ETCETERA	STRUC. = STRUCTURE
EW = EACH WAY	SUPP = SUPPORT
EXIST. = EXISTING	SY = SQUARE YARD
EXT = EXTERIOR	T&B = TOP AND BOTTOM
EXPN = EXPANSION	T.B.D = TO BE DETERMINED
F.F. = FINISHED FLOOR	TEMP = TEMPORARY
FDN. = FOUNDATION	T.O.C = TOP OF CONCRETE
FL = FLOOD LIGHT	T.O.S = TOP OF STEEL
FRP = FIBERGLASS REINFORCED PLASTIC	TC = TOP OF CURB
FS = FAR SIDE	TW = TOP OF WALL
FT = FEET	TYP = TYPICAL
FW = FRESH WATER	UNO = UNLESS NOTED OTHERWISE
GALV = GALVANIZED	UHMW = ULTRA HIGH MOLECULAR WEIGHT
GR = GRADE	U/R = UP RIVER
GRNG = GRATING	W/ = WITH
GUSS = GUSSET	W = WIDTH OR WIDE FLANGE BEAM
H = HEIGHT	W.T. = WALL THICKNESS
HAT = HIGHEST ASTRONOMICAL TIDE	WT = WEIGHT
HC = HANDICAPPED	∅ = CENTER LINE
I = I BEAM	# = NUMBER
INV = INVERT	% = PERCENT
JT = JOINT	≤ = LESS THAN OR EQUAL TO
kg = KILOGRAMS	℞ = PLATE
KN = KILOWEATONS	& = AND
L = LENGTH OR ANGLE	@ = AT
LAT = LOWEST ASTRONOMICAL TIDE	x = BY
	∅ = DIAMETER
	/ = PER

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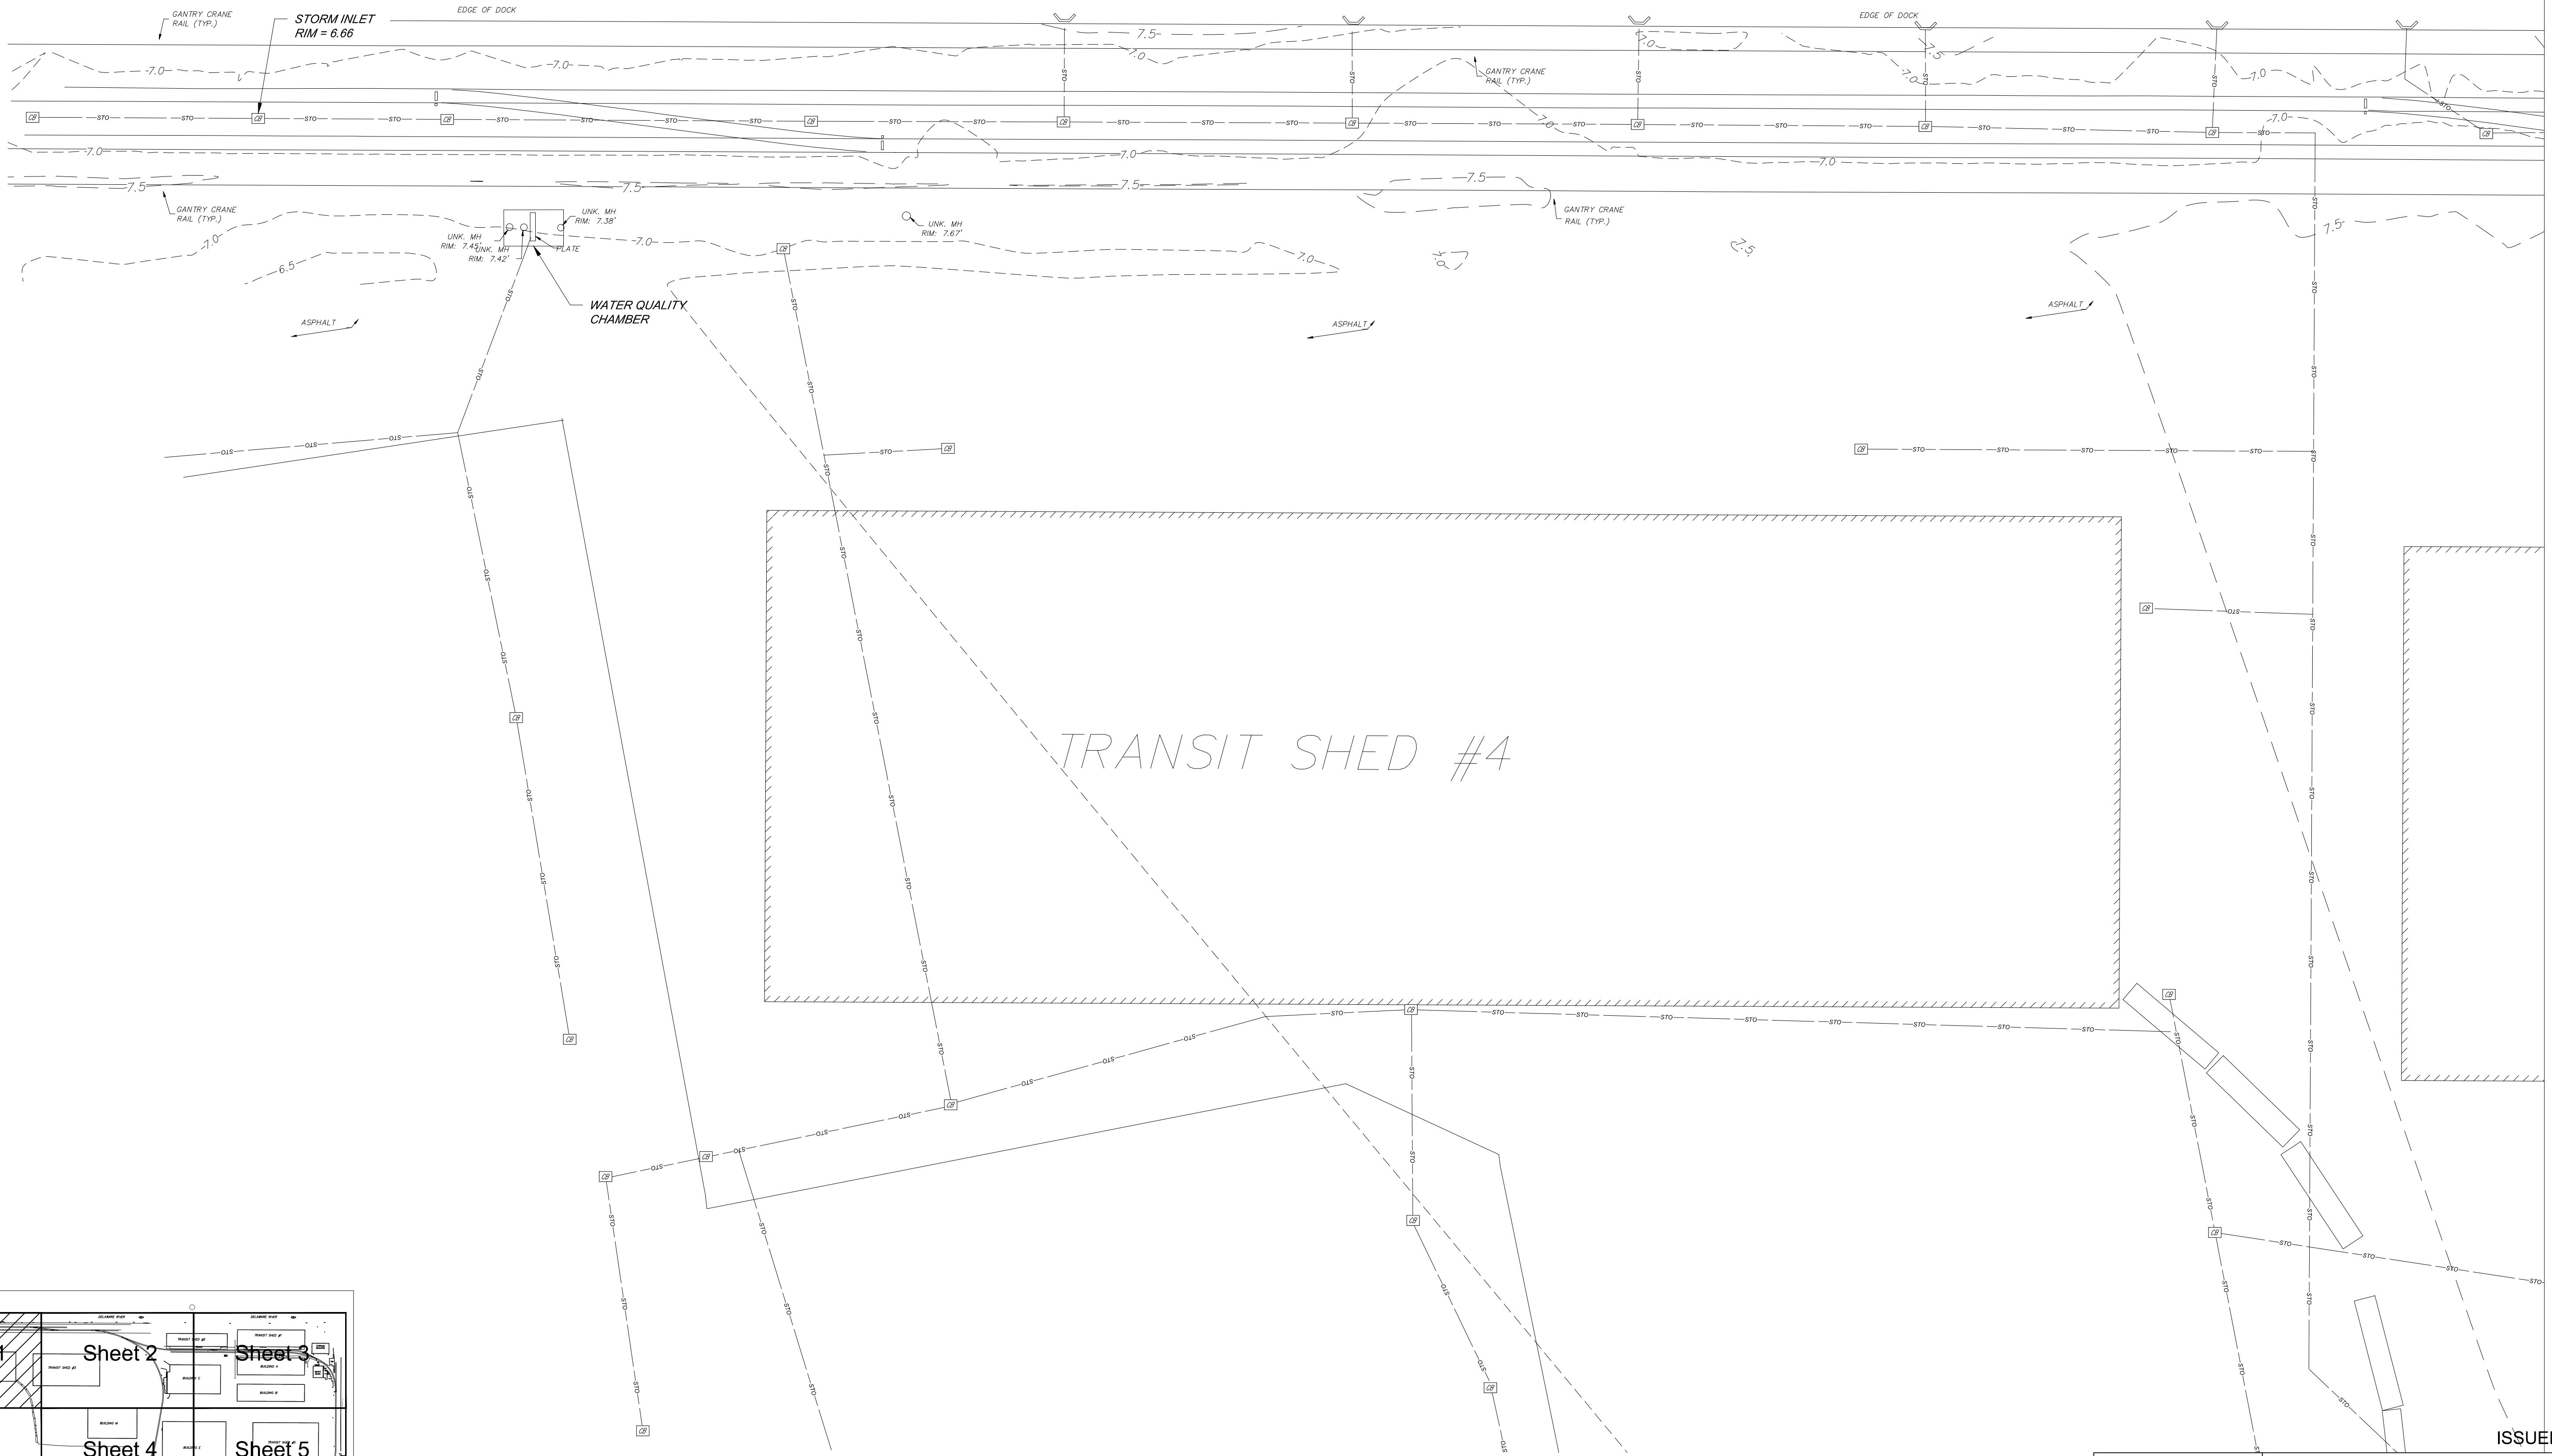
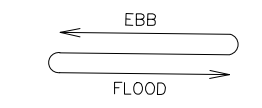
URBAN ENGINEERS, INC.
 530 Walnut Street
 Philadelphia, PA 19106
 (215) 922-8080 Fax (215) 922-8082

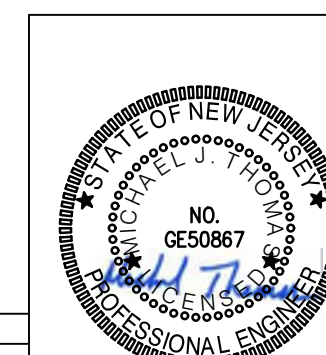LOCATION: **CAMDEN, NJ**
 TITLE: **SJPC BALZANO MARINE TERMINAL RAIL INFRASTRUCTURE REHABILITATION NOTES AND LEGENDS**

DWN: GJB PROJ # 2021500064.000 DRAWING NUMBER: **C-002**
 CHK: MJT DATE: 06/24/2022




REV	BY	DATE	DESCRIPTION

DELAWARE RIVER




SHEET 2

MATCH LINE

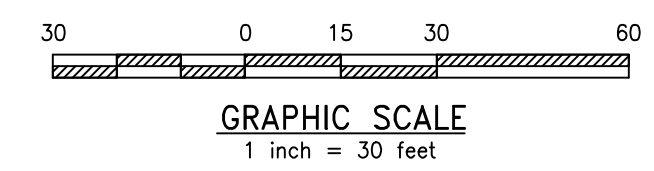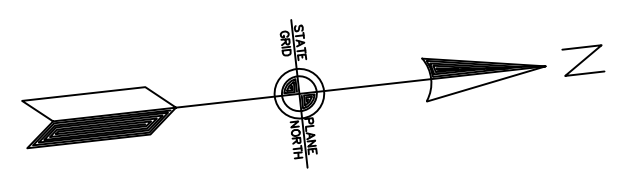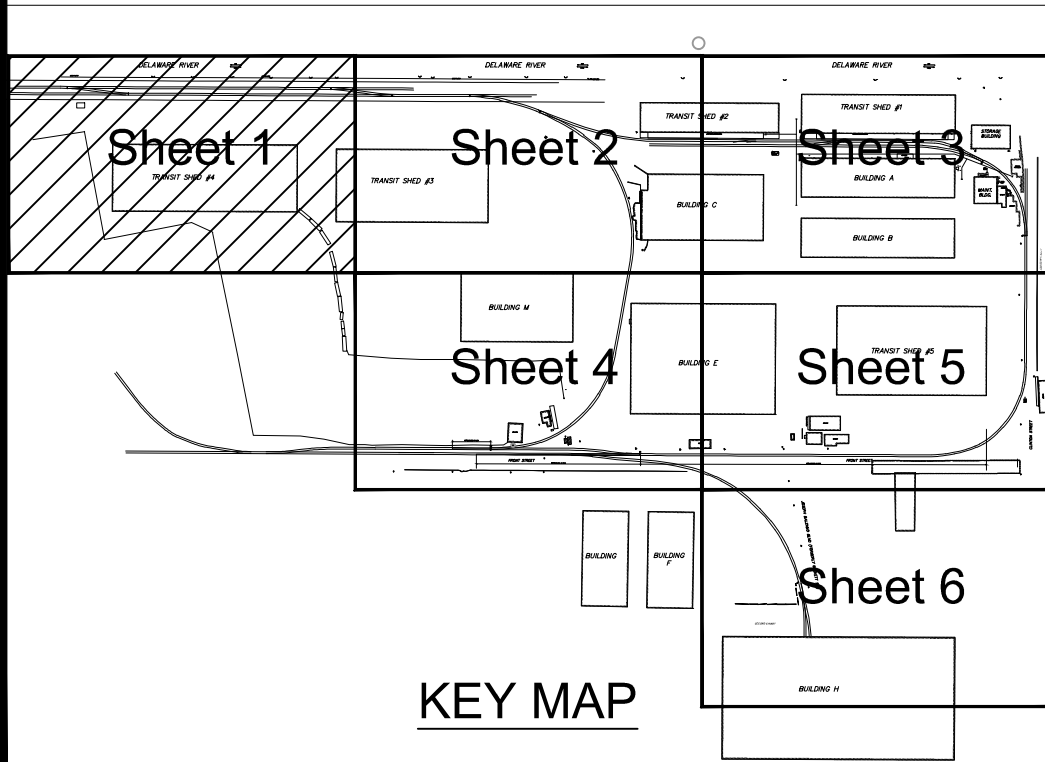

REV	BY	DATE	DESCRIPTION

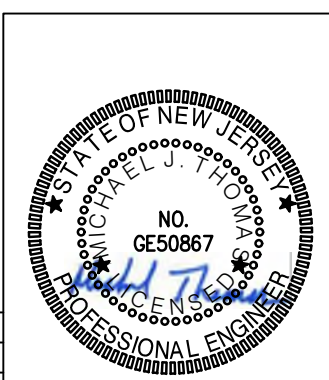

URBAN ENGINEERS, INC.
 530 Walnut Street
 Philadelphia, PA 19106
 (215) 922-8080 Fax (215) 922-8082


LOCATION: **CAMDEN, NJ**

TITLE: **SJPC BALZANO MARINE TERMINAL RAIL INFRASTRUCTURE REHABILITATION EXISTING CONDITIONS 1**

DWN: GJB PROJ # 2021500064.000 DRAWING NUMBER: **C-101**
 CHR: MJT DATE 06/24/2022

ISSUED FOR BID

DELAWARE RIVER


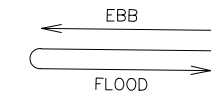


SHEET 1

SHEET 3



MATCH LINE

MATCH LINE

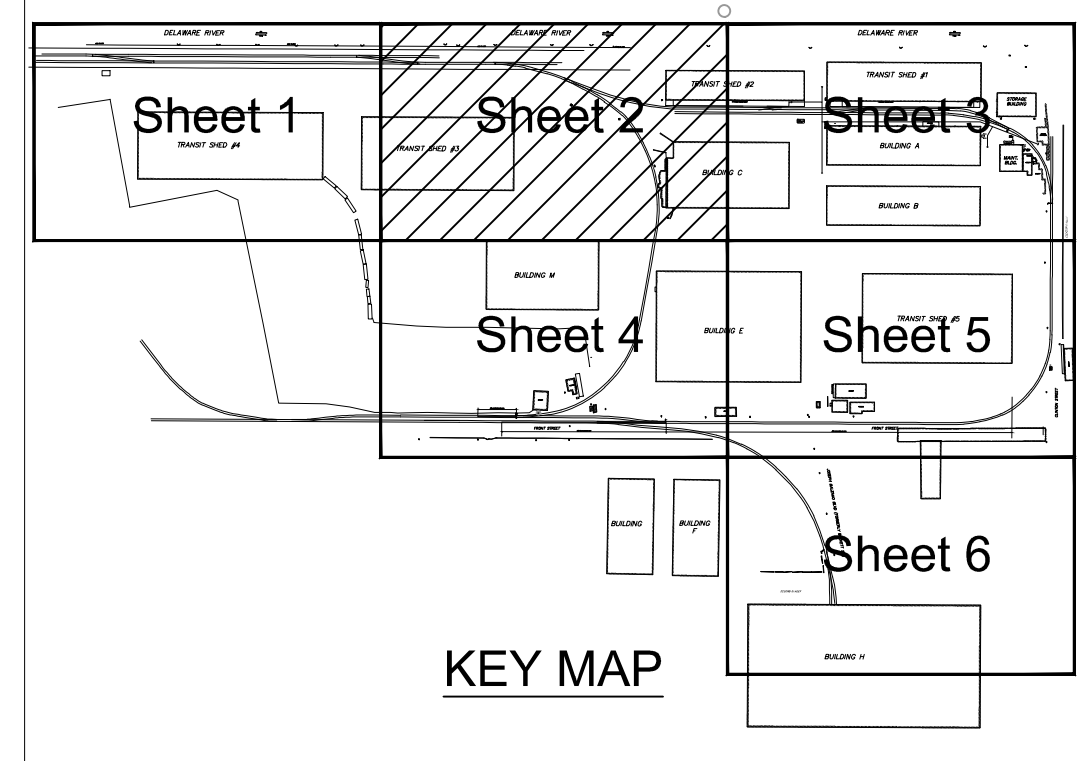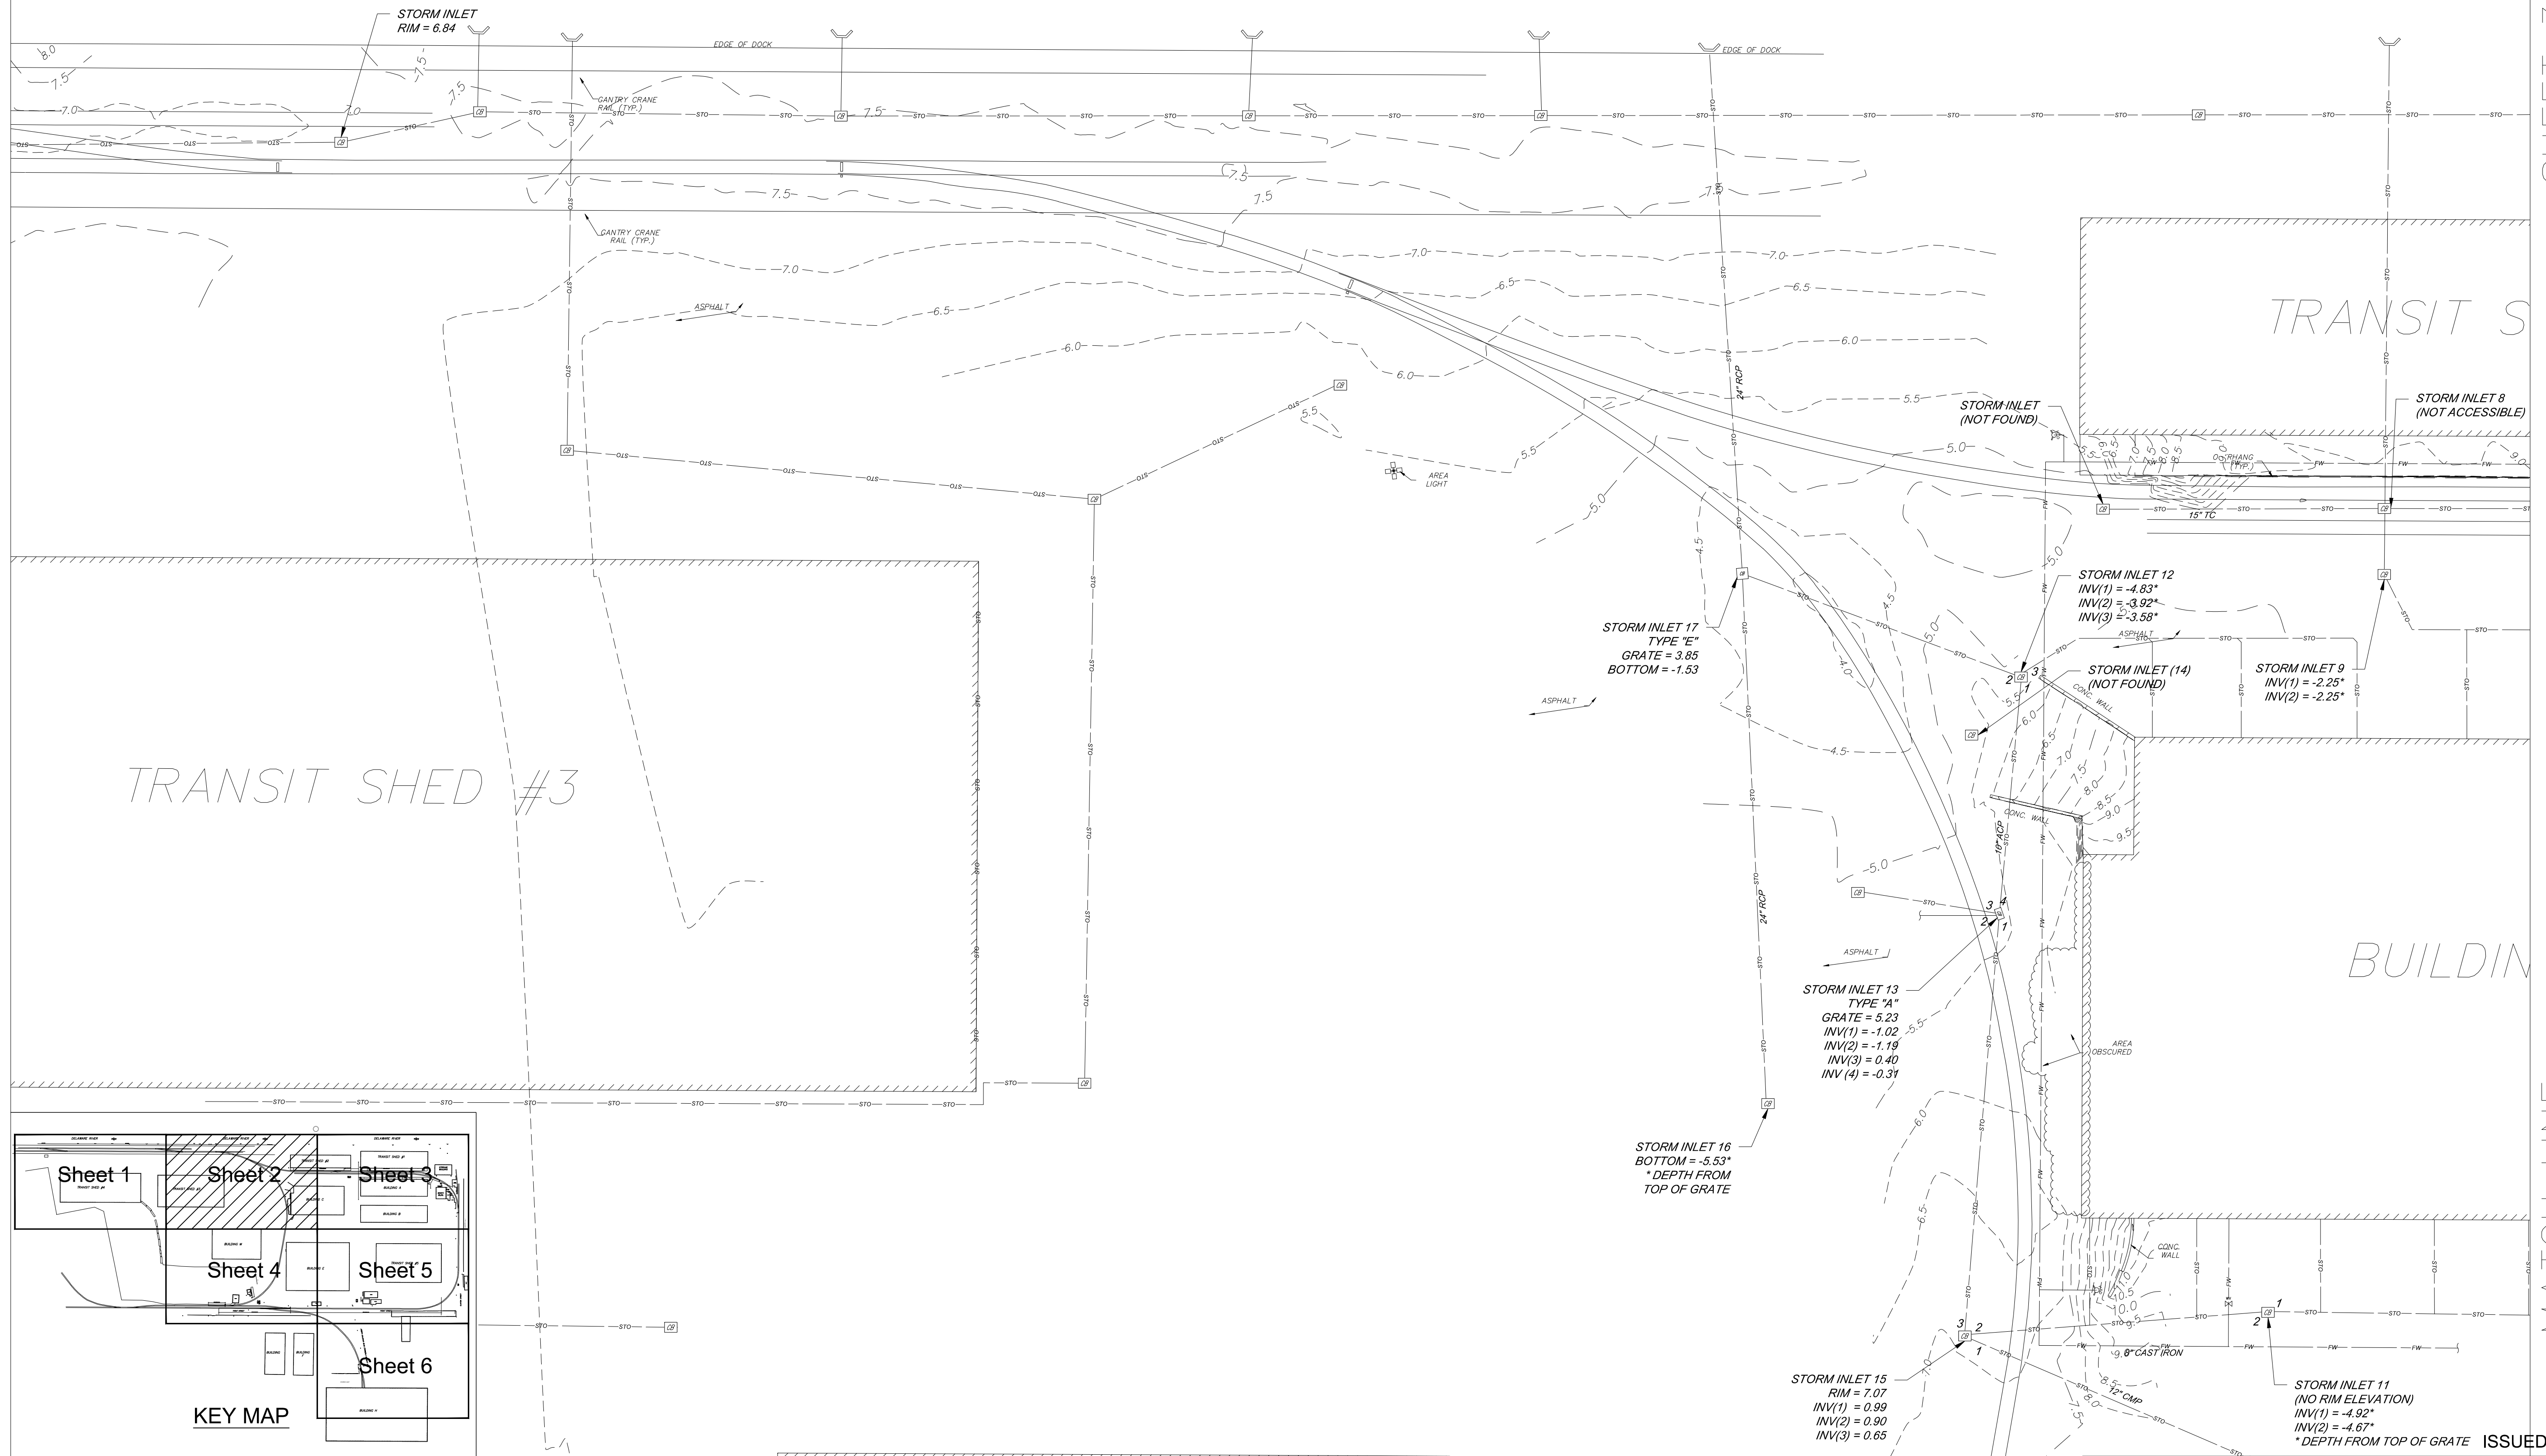


MATCH LINE

SHEET 4

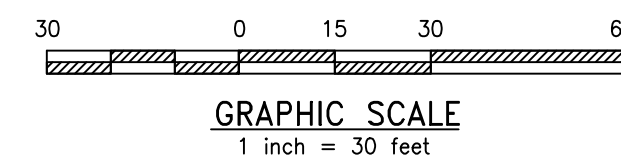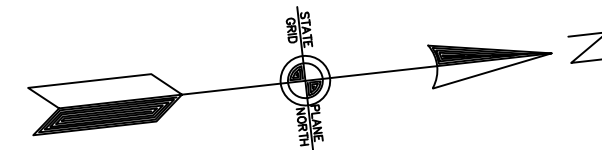

REV	BY	DATE	DESCRIPTION

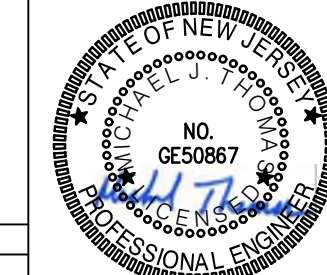


URBAN ENGINEERS, INC.
530 Walnut Street
Philadelphia, PA 19106
(215) 922-8080 Fax (215) 922-8082

LOCATION: **CAMDEN, NJ**


TITLE: **SJPC BALZANO MARINE TERMINAL RAIL INFRASTRUCTURE REHABILITATION EXISTING CONDITIONS 2**

DWN: GJB PROJ # 2021500064.000 DRAWING NUMBER: **C-102**
CHK: MJT DATE: 06/24/2022


DELAWARE RIVER

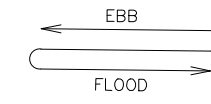

SHEET 2


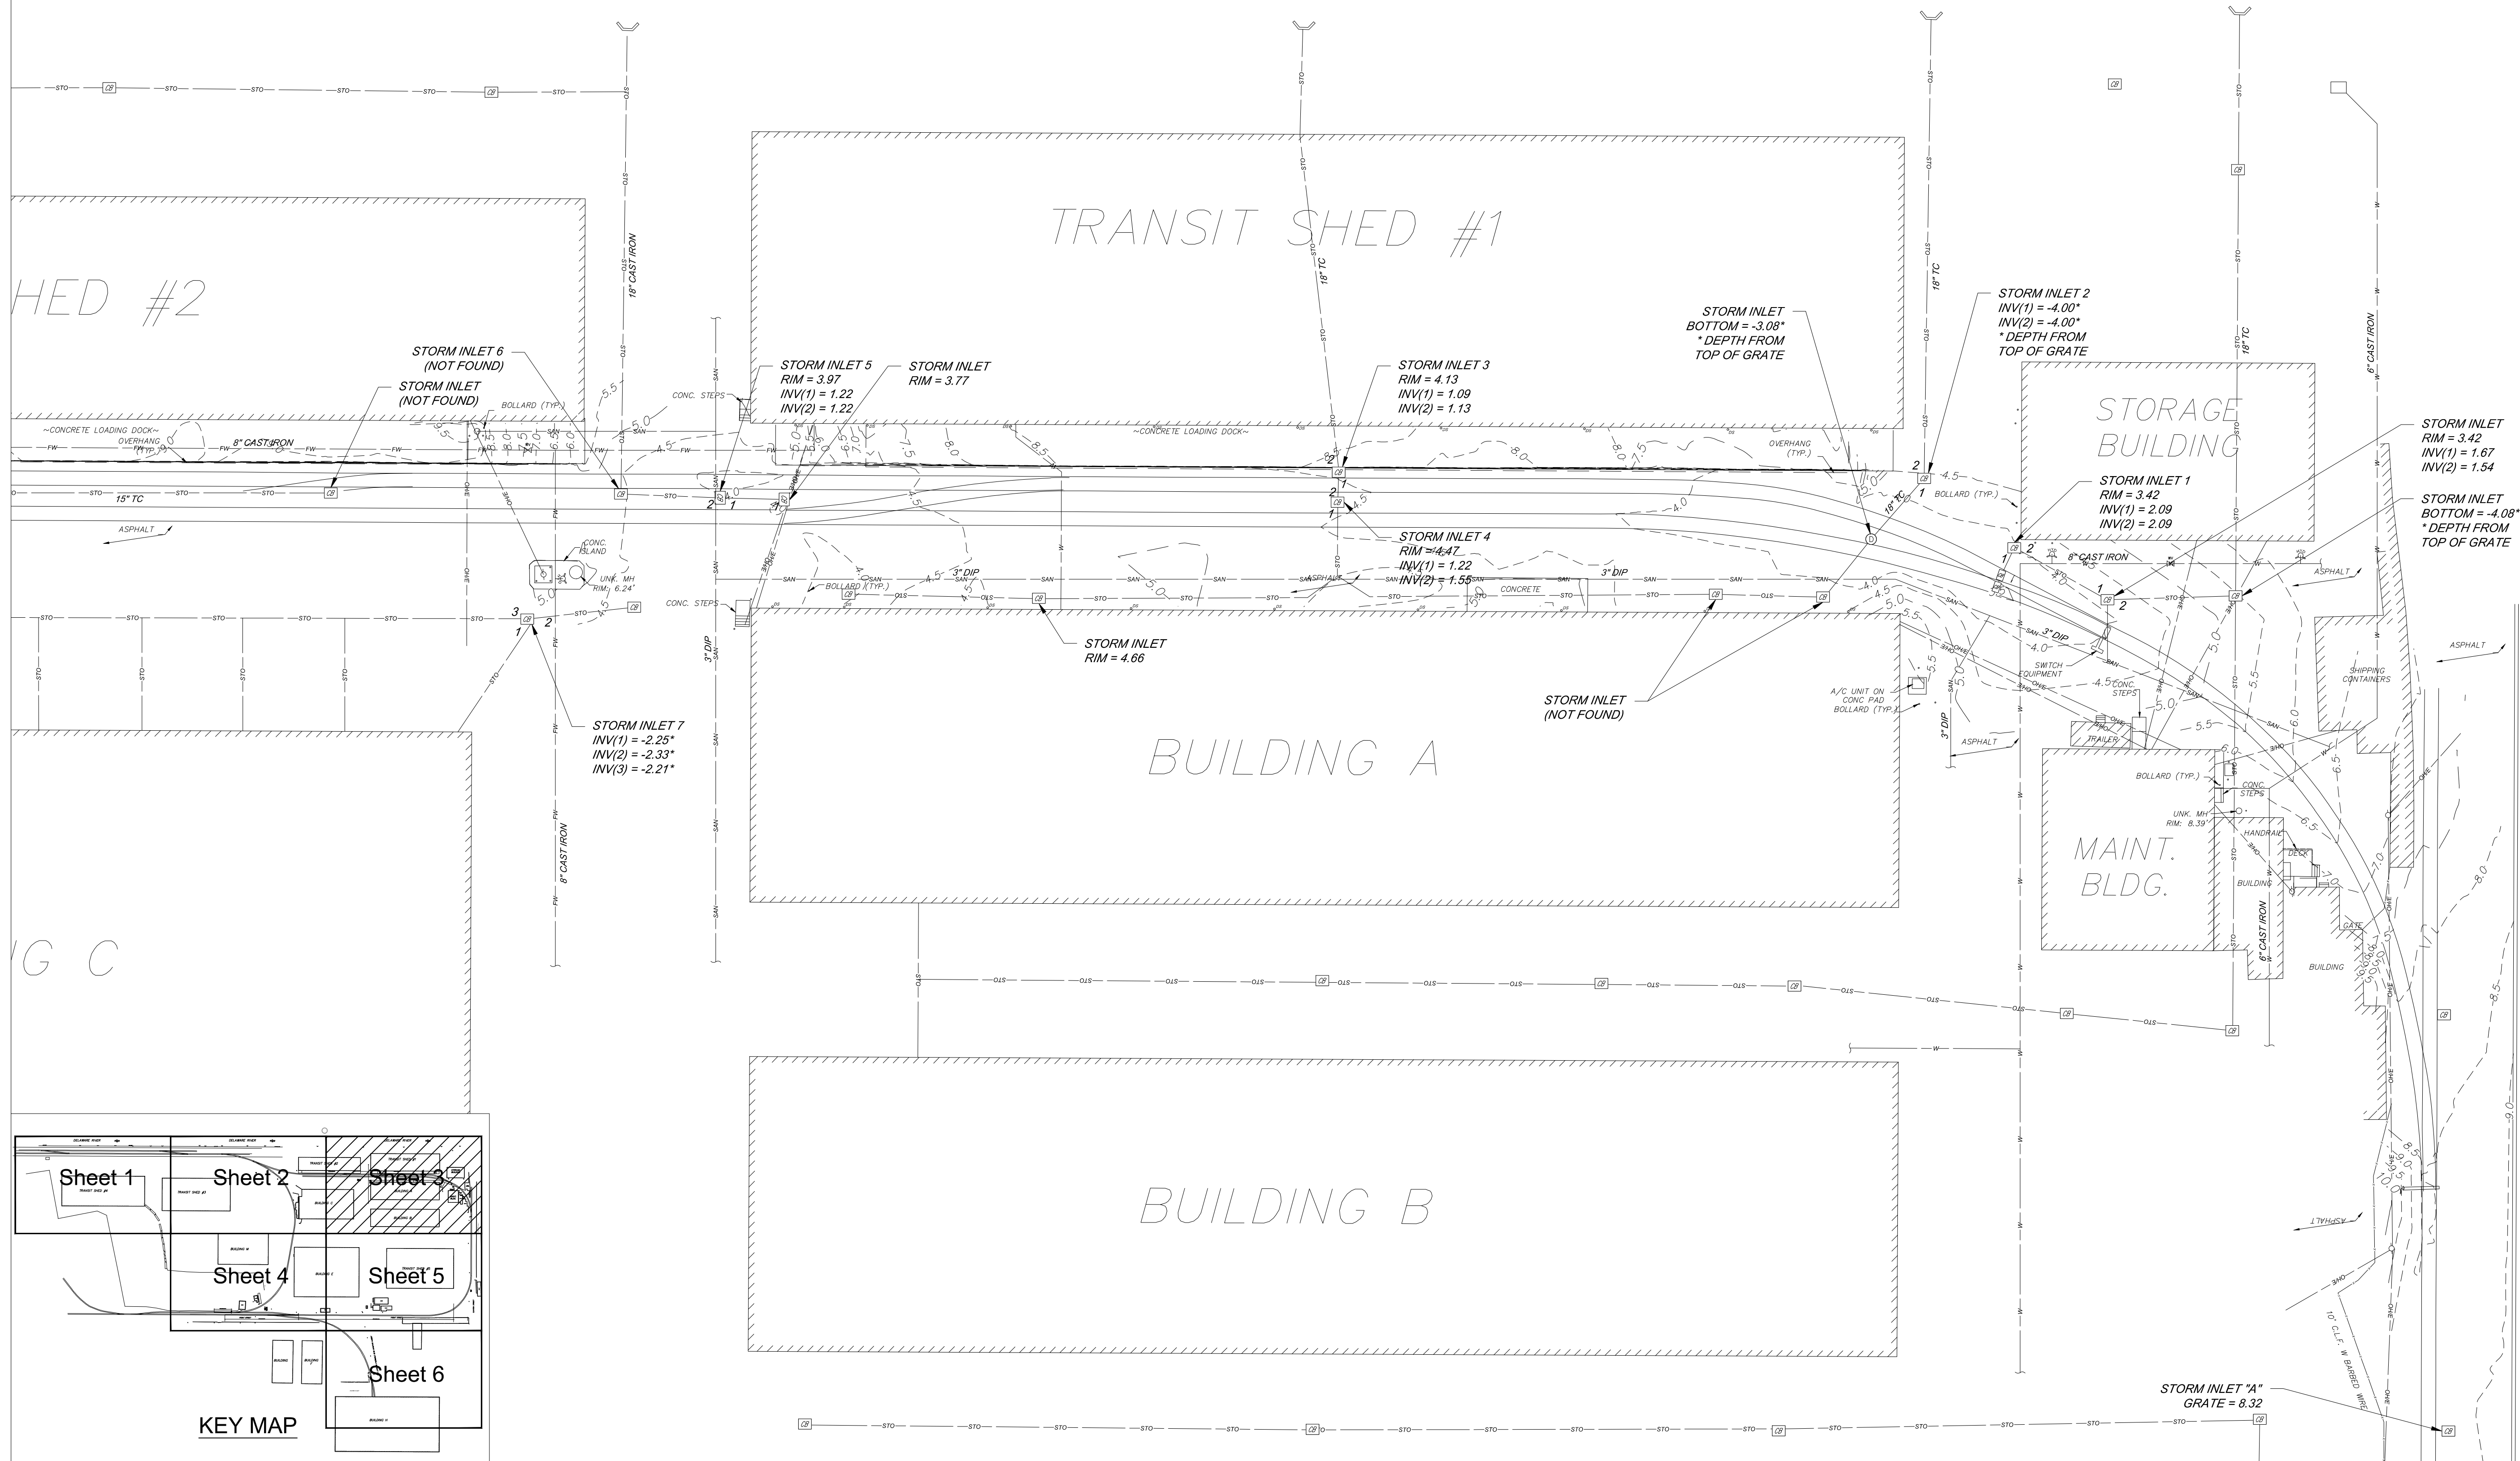


MATCH LINE

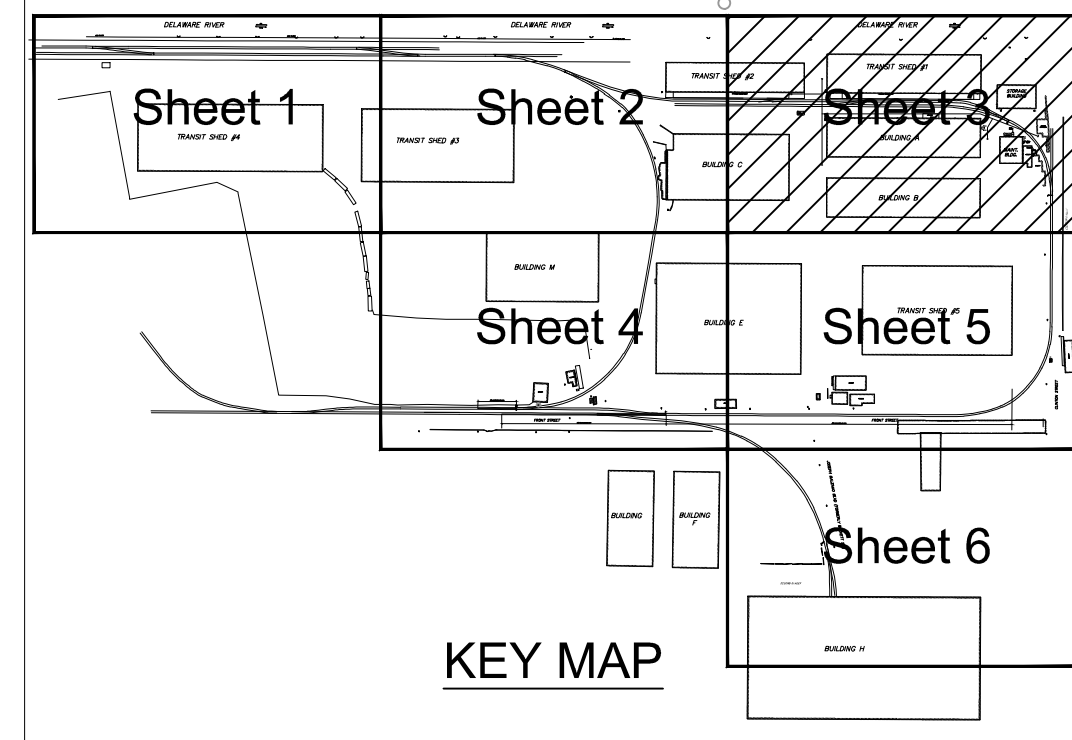

MATCH LINE

SHEET 5

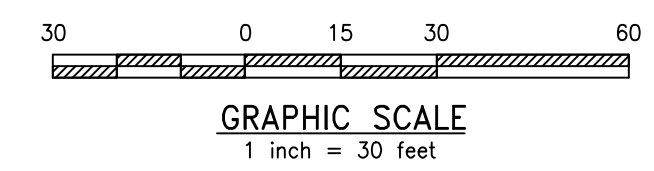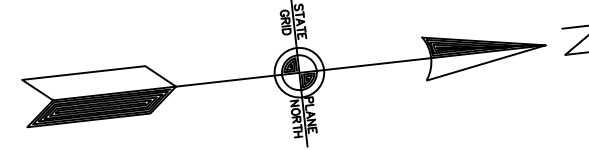

REV	BY	DATE	DESCRIPTION



ISSUED FOR BID

URBAN ENGINEERS, INC.
530 Walnut Street
Philadelphia, PA 19106
(215) 922-8080 Fax (215) 922-8082

LOCATION: **CAMDEN, NJ**

TITLE: **SJPC BALZANO MARINE TERMINAL RAIL INFRASTRUCTURE REHABILITATION EXISTING CONDITIONS 3**

DWN: GJB PROJ # 2021500064.000 DRAWING NUMBER: **C-103**

CHK: MJT DATE 06/24/2022

MATCH LINE

SHEET 2




SHEET 5

BUILDING M


STORM INLET 10
(NO RIM ELEVATION)
INV(1) = -5.21'
INV(2) = -5.54'
* DEPTH FROM TOP OF GRATE

BUILDING

MATCH LINE

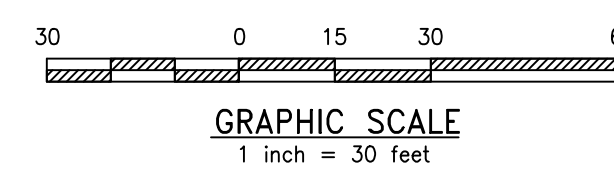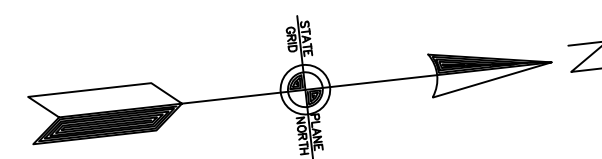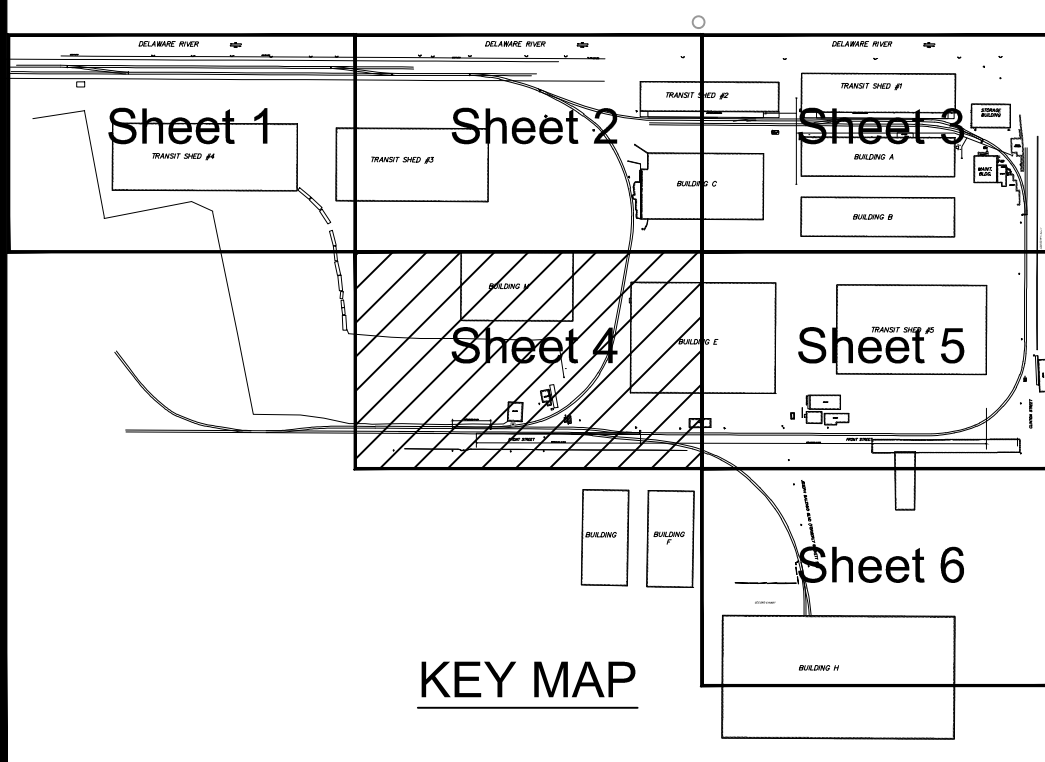

REV	BY	DATE	DESCRIPTION

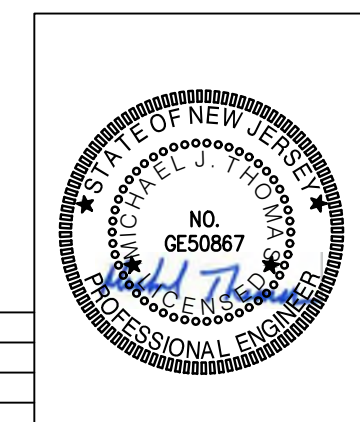

URBAN ENGINEERS, INC.
530 Walnut Street
Philadelphia, PA 19106
(215) 922-8080 Fax (215) 922-8082

LOCATION: CAMDEN, NJ


TITLE: SJPC BALZANO MARINE TERMINAL RAIL INFRASTRUCTURE REHABILITATION EXISTING CONDITIONS 4

DWN: GJB PROJ # 2021500064.000 DRAWING NUMBER: C-104
CHK: MJT DATE 06/24/2022

ISSUED FOR BID

MATCH LINE

SHEET 3

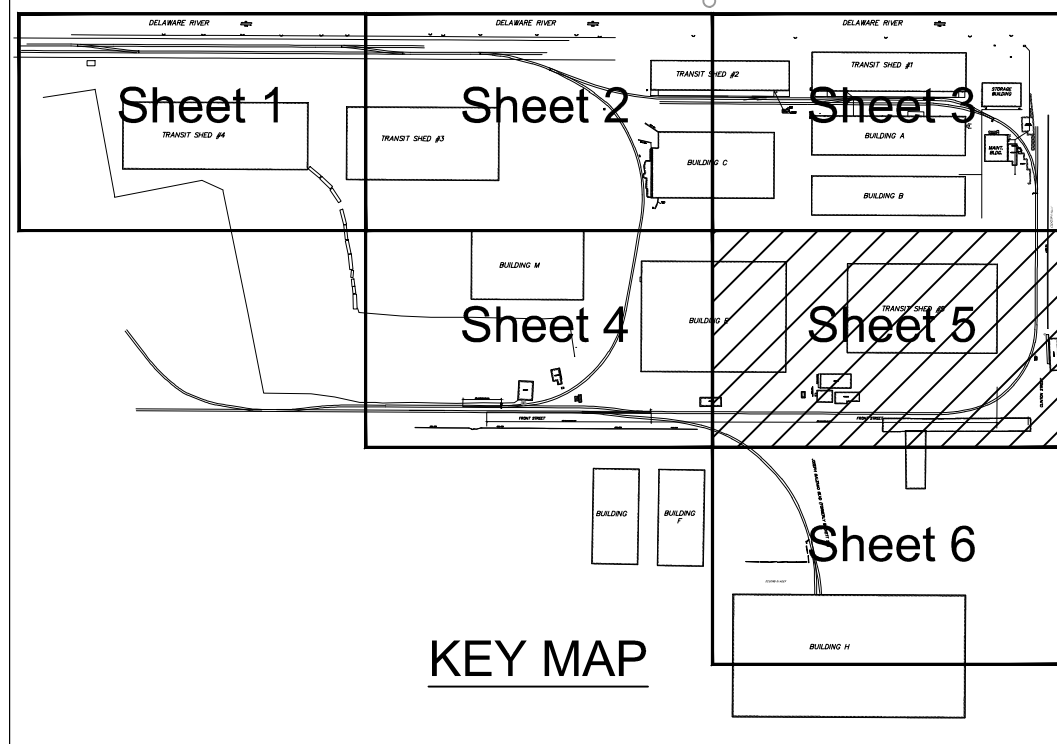


SHEET 4

VG E



TRANSIT SHED #5

MATCH LINE

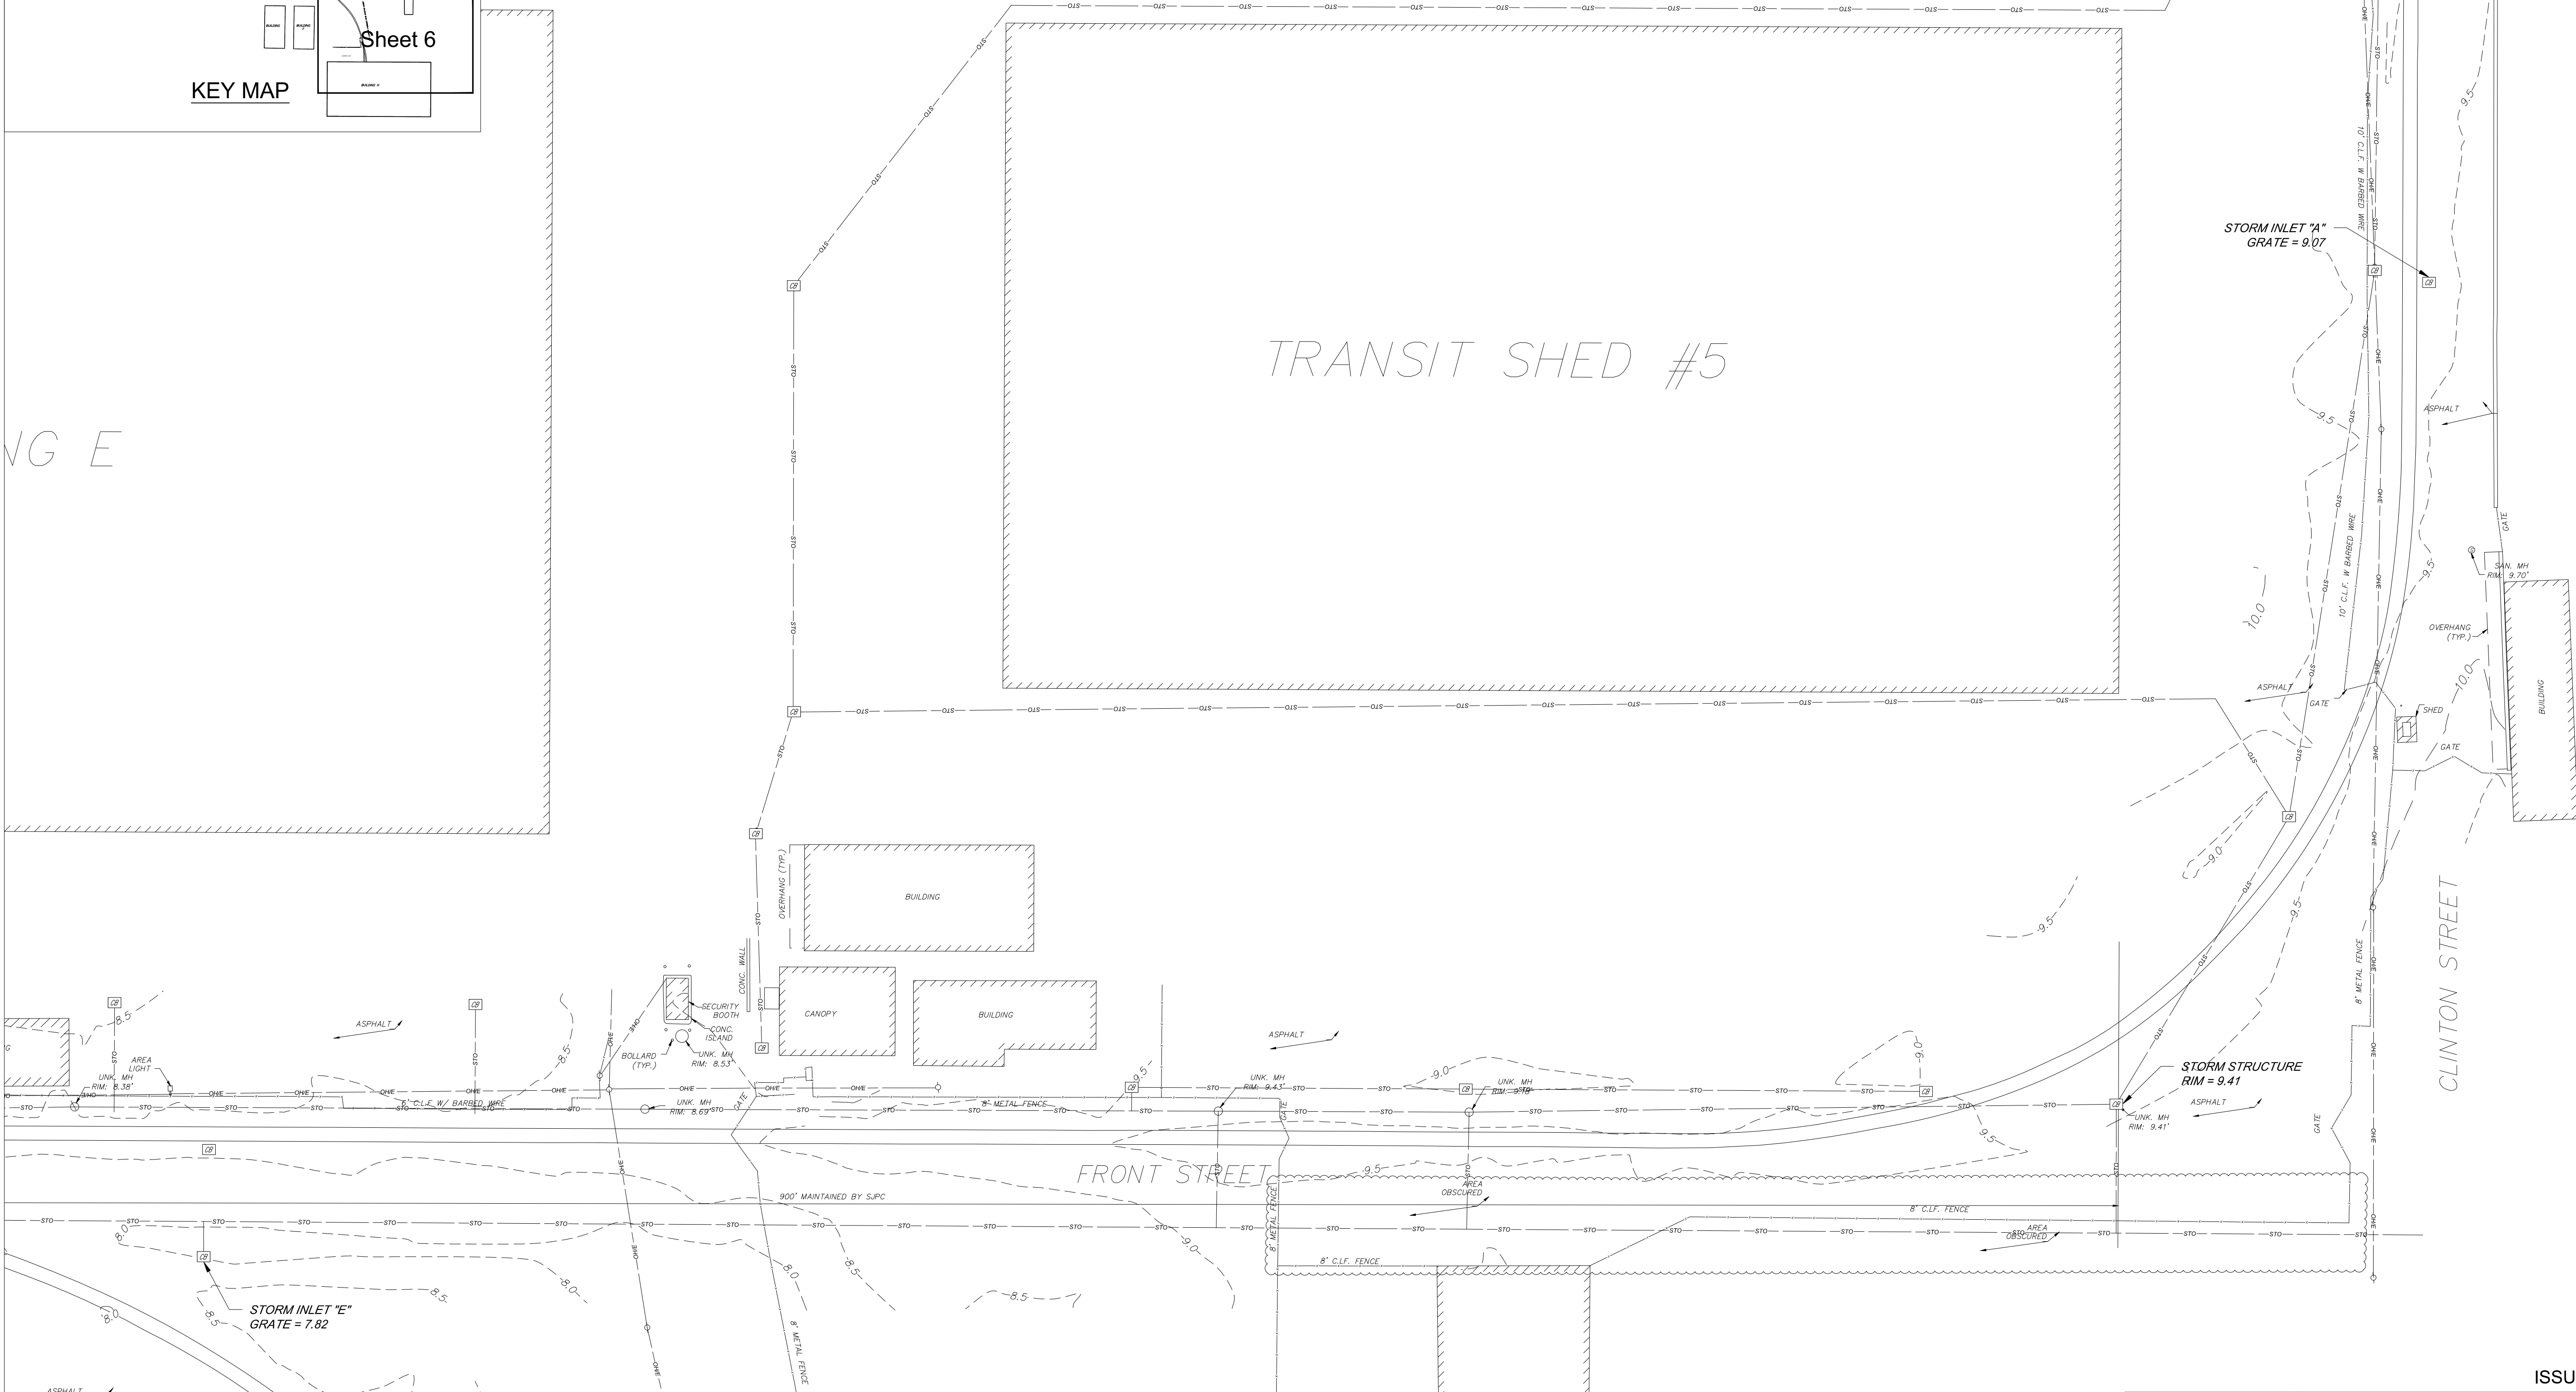

MATCH LINE

SHEET 6

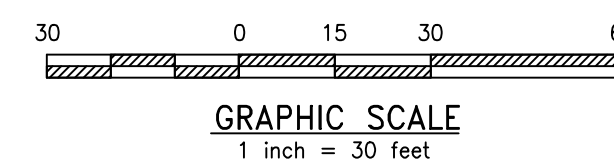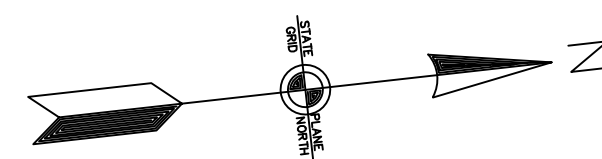

ISSUED FOR BID

URBAN ENGINEERS, INC.
 530 Walnut Street
 Philadelphia, PA 19106
 (215) 922-8080 Fax (215) 922-8082


LOCATION CAMDEN, NJ

TITLE
**SJPC BALZANO MARINE TERMINAL RAIL
 INFRASTRUCTURE REHABILITATION
 EXISTING CONDITIONS 5**


DWN GJB PROJ # 2021500064.000
 CHK MJT DATE 06/24/2022

DRAWING NUMBER C-105

REV	BY	DATE	DESCRIPTION

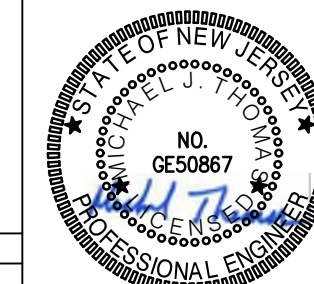


MATCH LINE


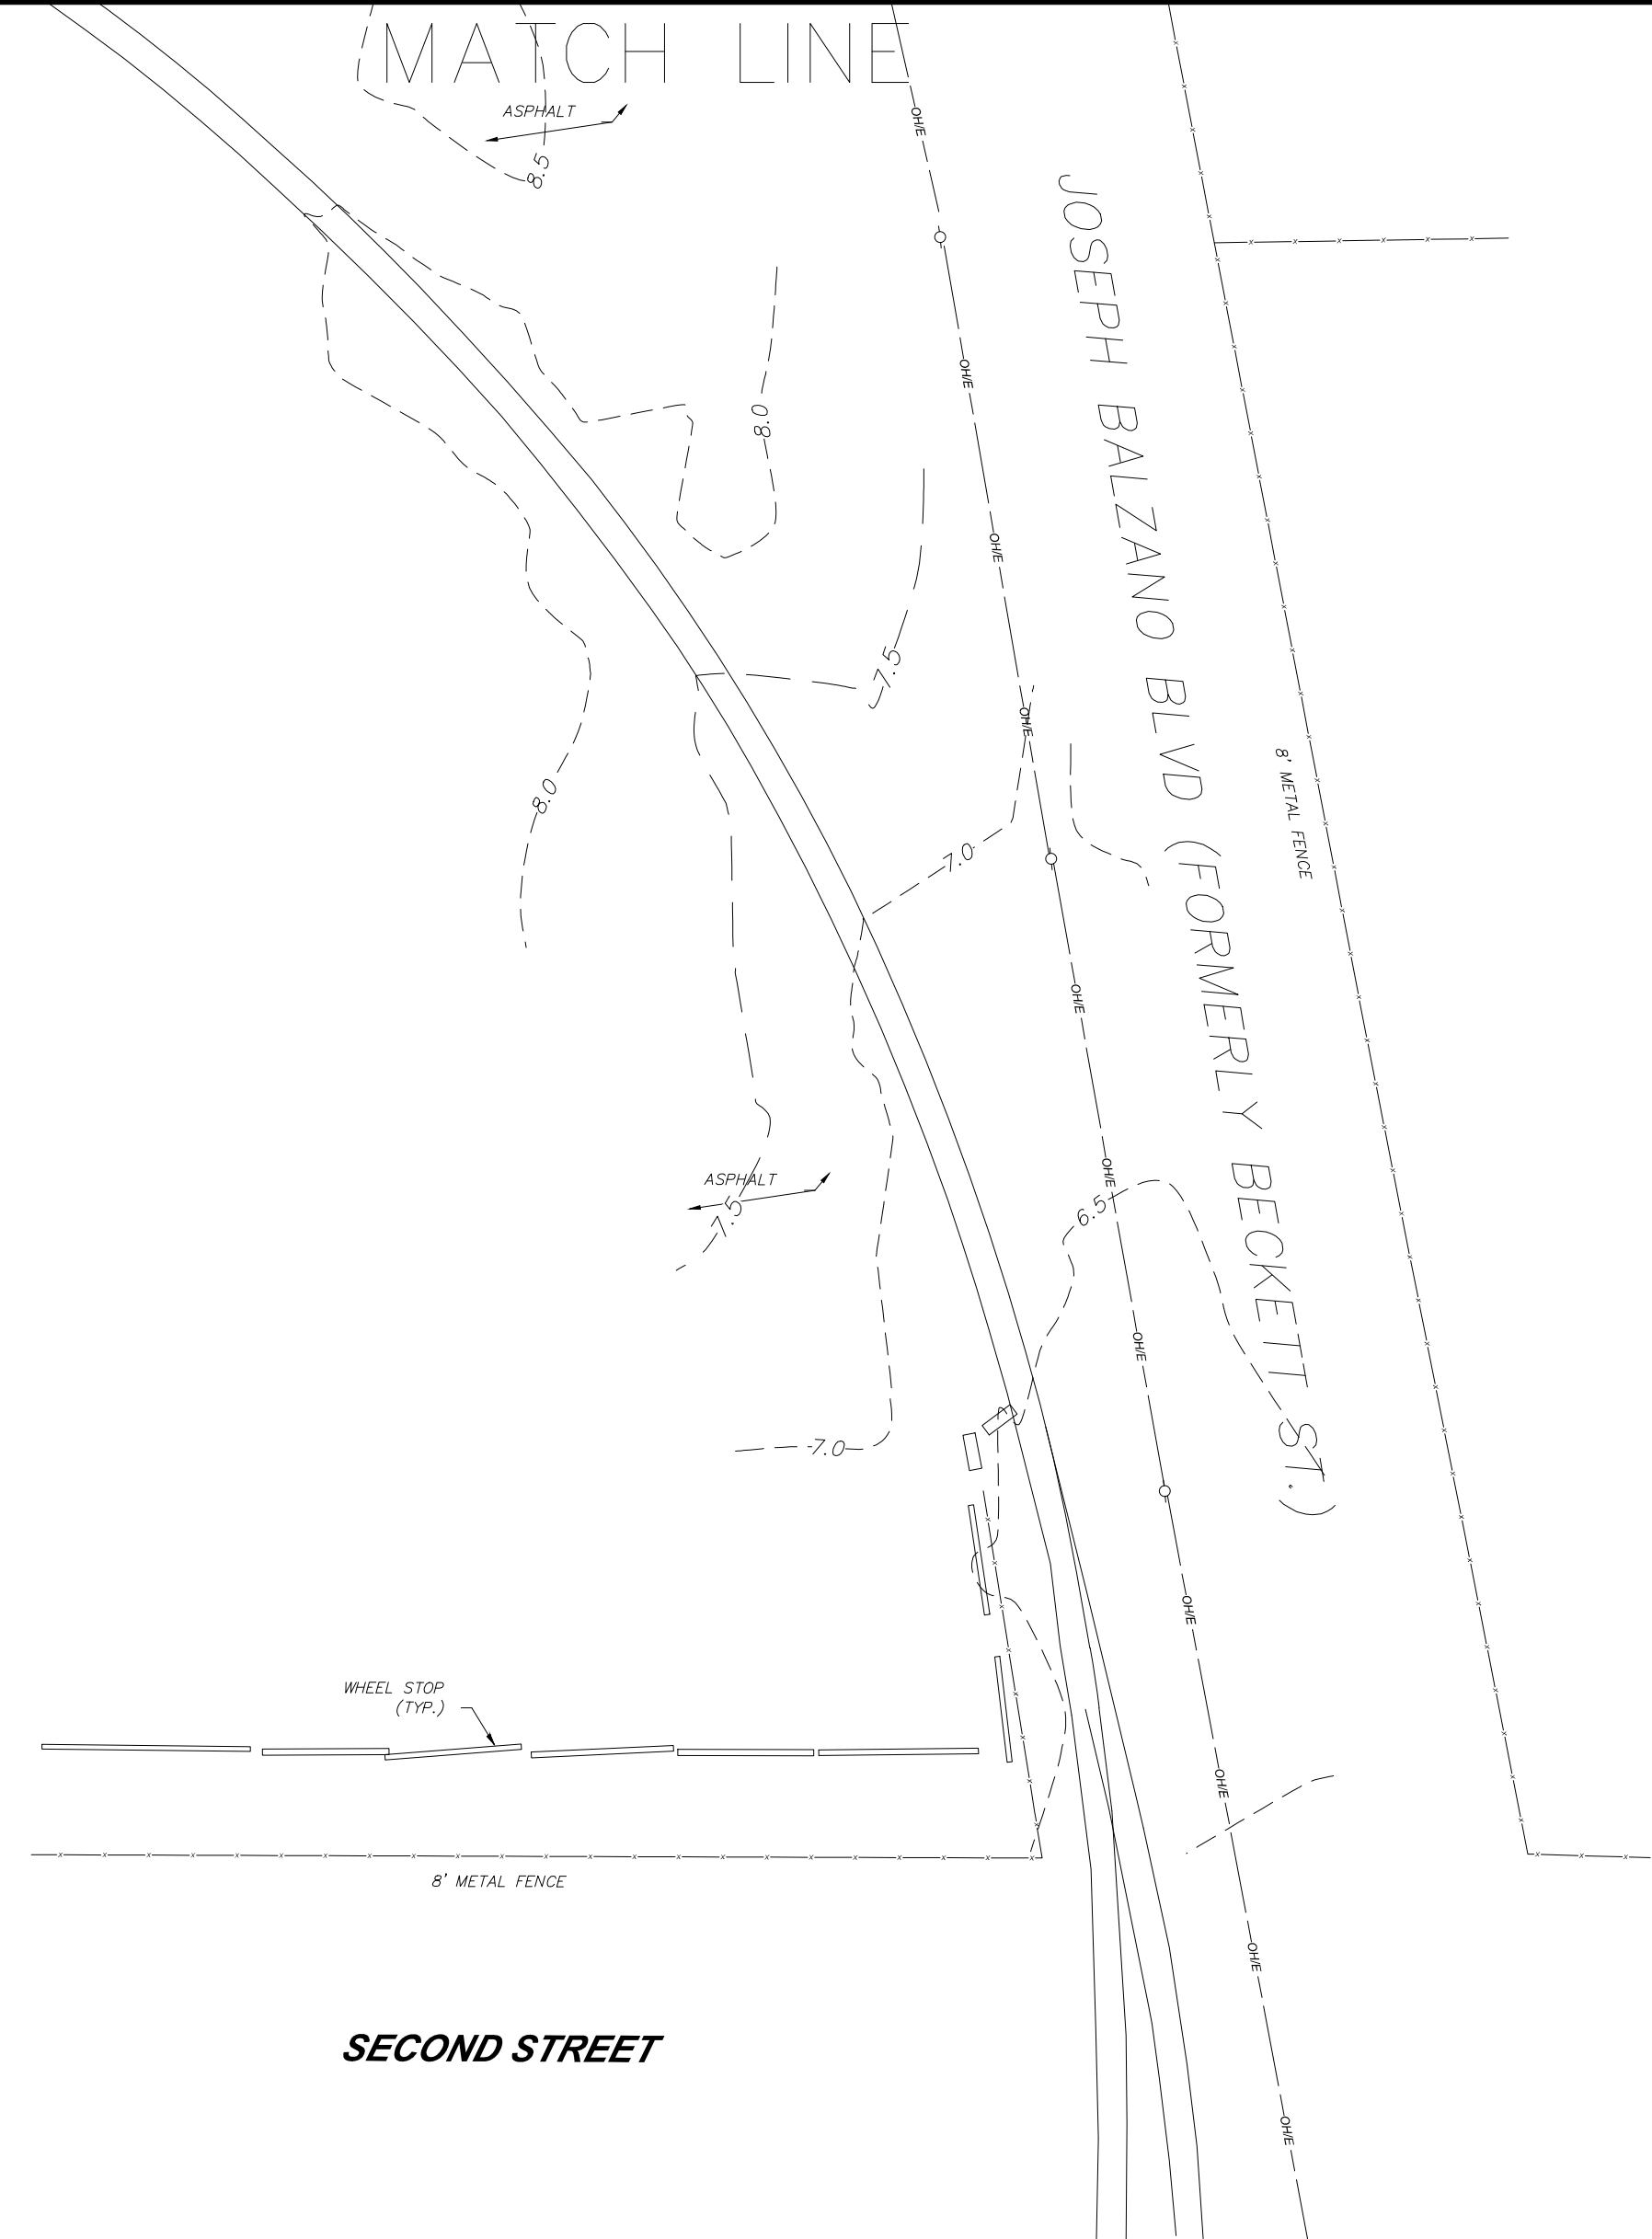


SECOND STREET


BUILDING H

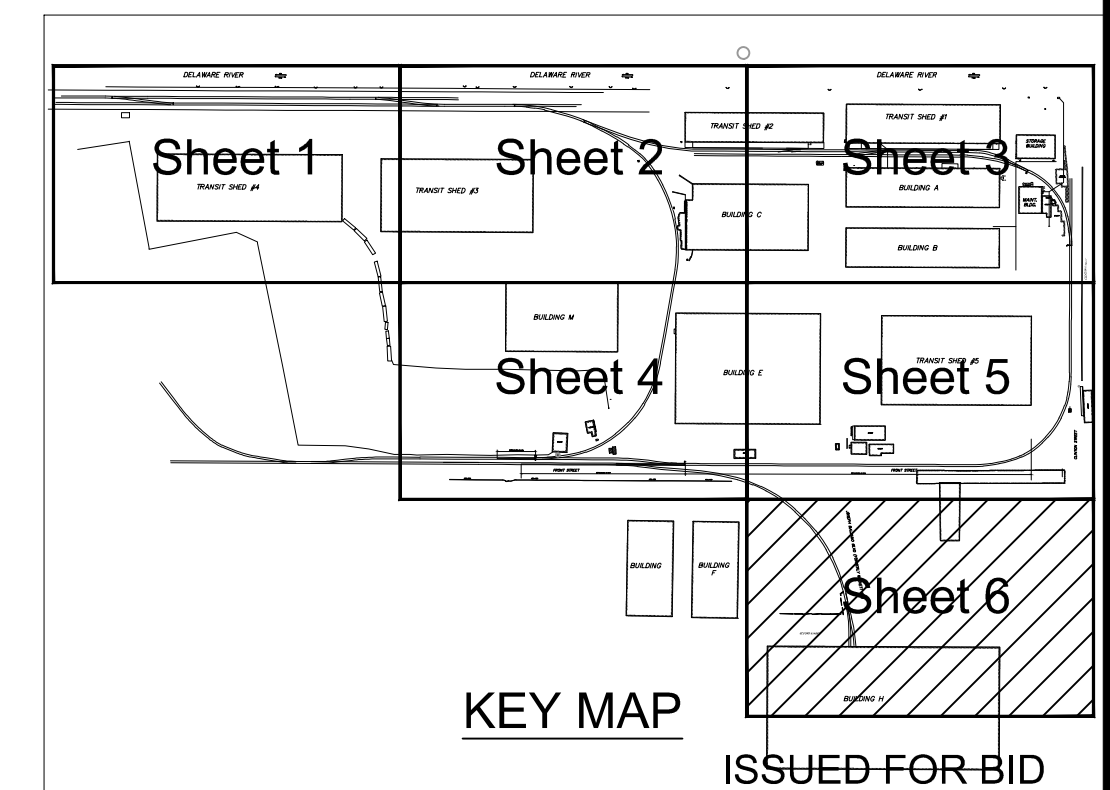

KEY MAP ISSUED FOR BID

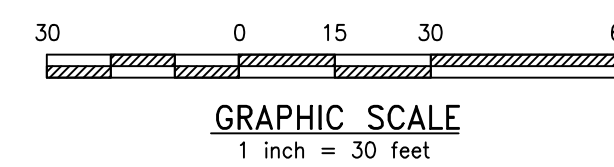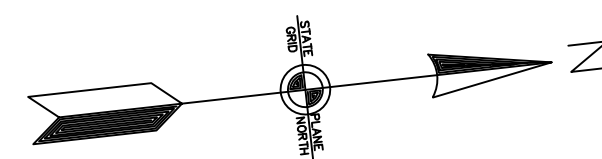

REV	BY	DATE	DESCRIPTION

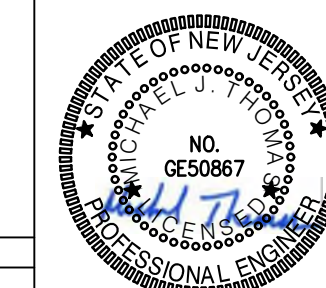


URBAN ENGINEERS, INC.
 530 Walnut Street
 Philadelphia, PA 19106
 (215) 922-8080 Fax (215) 922-8082

LOCATION: CAMDEN, NJ

TITLE: SJPC BALZANO MARINE TERMINAL RAIL INFRASTRUCTURE REHABILITATION EXISTING CONDITIONS 6


OWN: GJB PROJ # 2021500064.000 DRAWING NUMBER: C-106
 CHK: MJT DATE 06/24/2022

DELAWARE RIVER


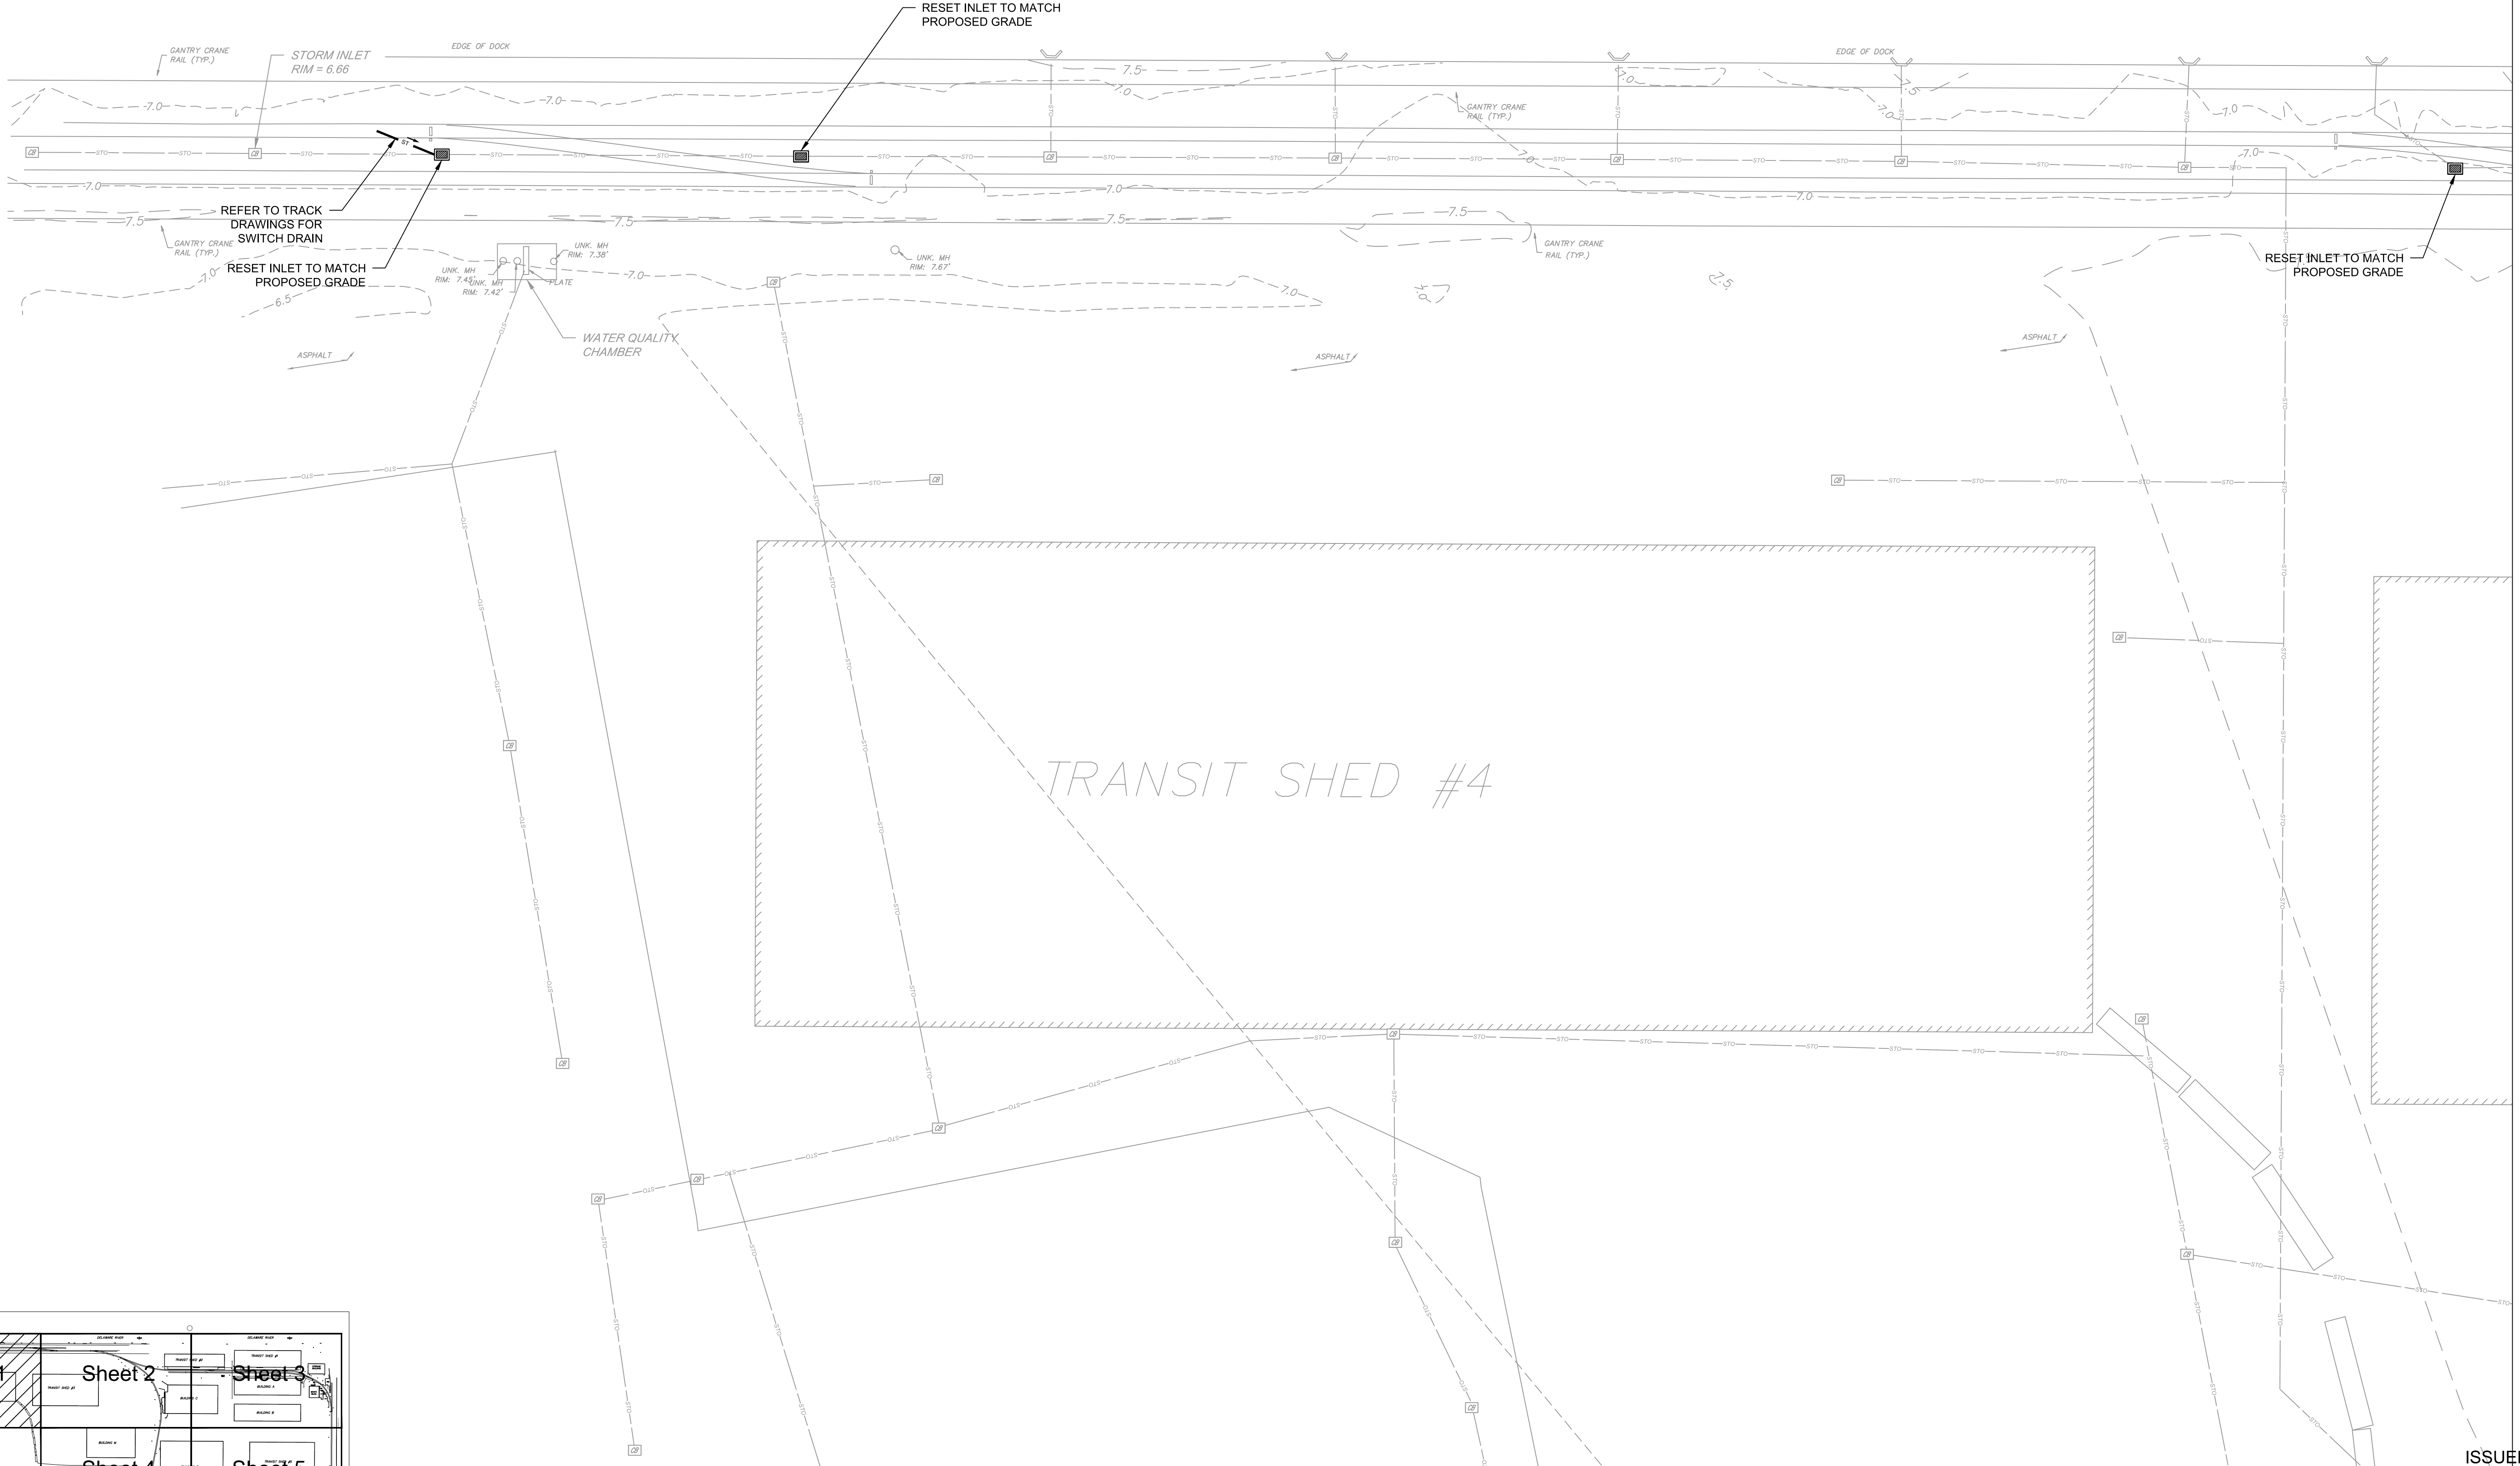


SHEET 2


MATCH LINE

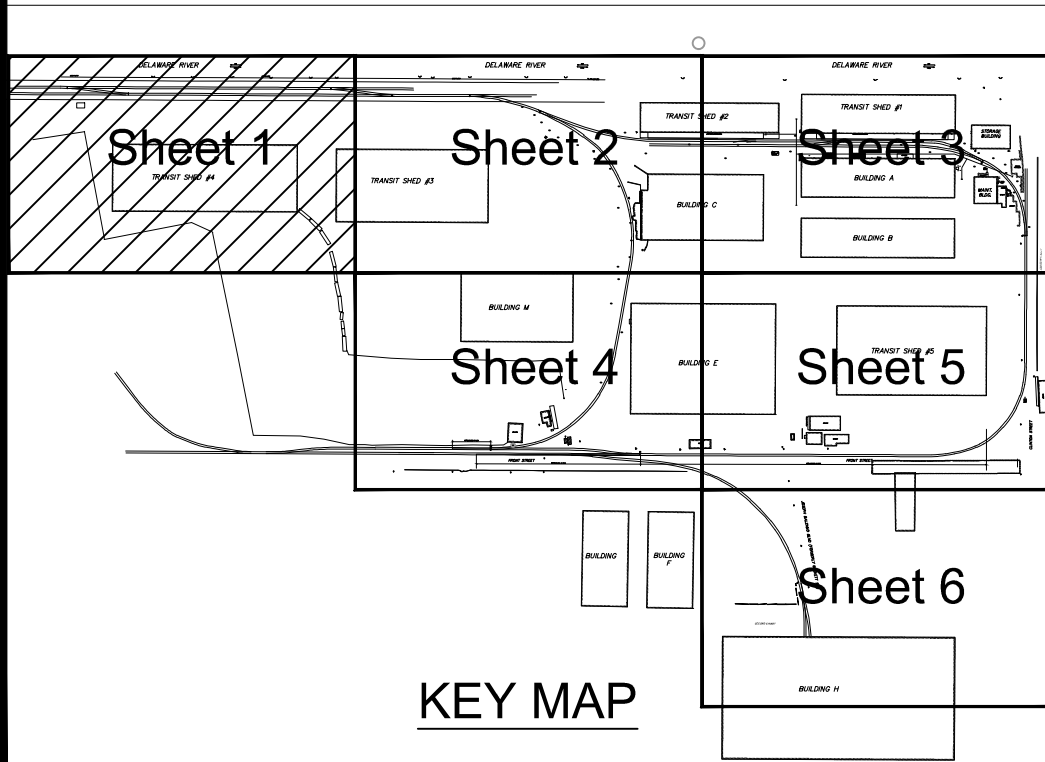

- STORMWATER NOTES:**
- WHERE NEW STORMWATER PIPES ARE TO BE INSTALLED THE CONTRACTOR IS TO FIELD VERIFY EXISTING DOWNSTREAM STORMWATER PIPE SIZE. NEW STORMWATER PIPE TO BE INSTALLED IS TO MATCH THE DOWNSTREAM SIZE.
 - NEW STORMWATER PIPE INVERTS MUST MATCH OR BE BETWEEN UPSTREAM AND DOWNSTREAM PIPE INVERTS WHILE MAINTAINING MINIMUM SLOPE PER NOTE #3.
 - CONTRACTOR TO MAINTAIN MINIMUM 0.50% SLOPE, IN A DOWNSTREAM DIRECTION, ON STORMWATER PIPES.
 - NEW STORMWATER PIPES SHALL MAINTAIN 18" MINIMUM COVER TO CROWN OF PIPE.
 - ALL STORMWATER PIPES SHALL BE CONNECTED TO STORMWATER CONVEYANCE NETWORK AS SHOWN AND SHALL DRAIN TO EXISTING OUTLETS AND OUTFALLS.
 - CONTRACTOR TO FIELD VERIFY LOCATION OF EXISTING UTILITIES PRIOR TO INSTALLATION OF NEW STORMWATER PIPE TO AVOID POTENTIAL CONFLICTS. WHERE UTILITY/PIPE CROSSINGS ARE REQUIRED, CONTRACTOR TO NOTIFY ENGINEER.
 - CONTRACTOR TO INSPECT AND CLEAR ALL EXISTING DOWNSTREAM PIPES IN ACCORDANCE TO SPECIFICATION 330130.11, TELEVISION INSPECTION OF SEWERS.

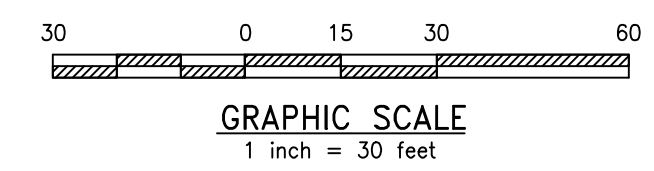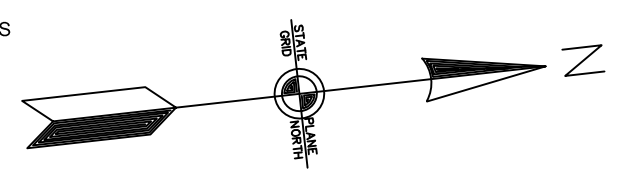

REV	BY	DATE	DESCRIPTION

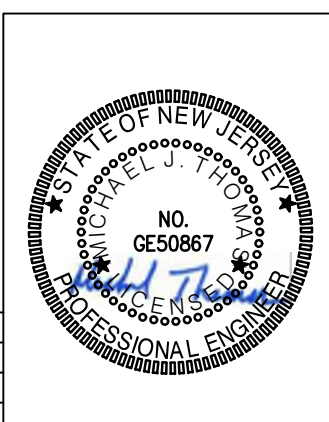

URBAN ENGINEERS, INC.
 530 Walnut Street
 Philadelphia, PA 19106
 (215) 922-8080 Fax (215) 922-8082


LOCATION: **CAMDEN, NJ**

TITLE: **SJPC BALZANO MARINE TERMINAL RAIL INFRASTRUCTURE REHABILITATION PROPOSED STORM & WATER 1**

DWN: GJB PROJ # 2021500064.000 DRAWING NUMBER: **C-201**
 CHR: MJT DATE 06/24/2022


ISSUED FOR BID

DELAWARE RIVER

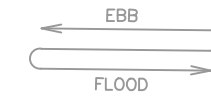


SHEET 1

SHEET 3

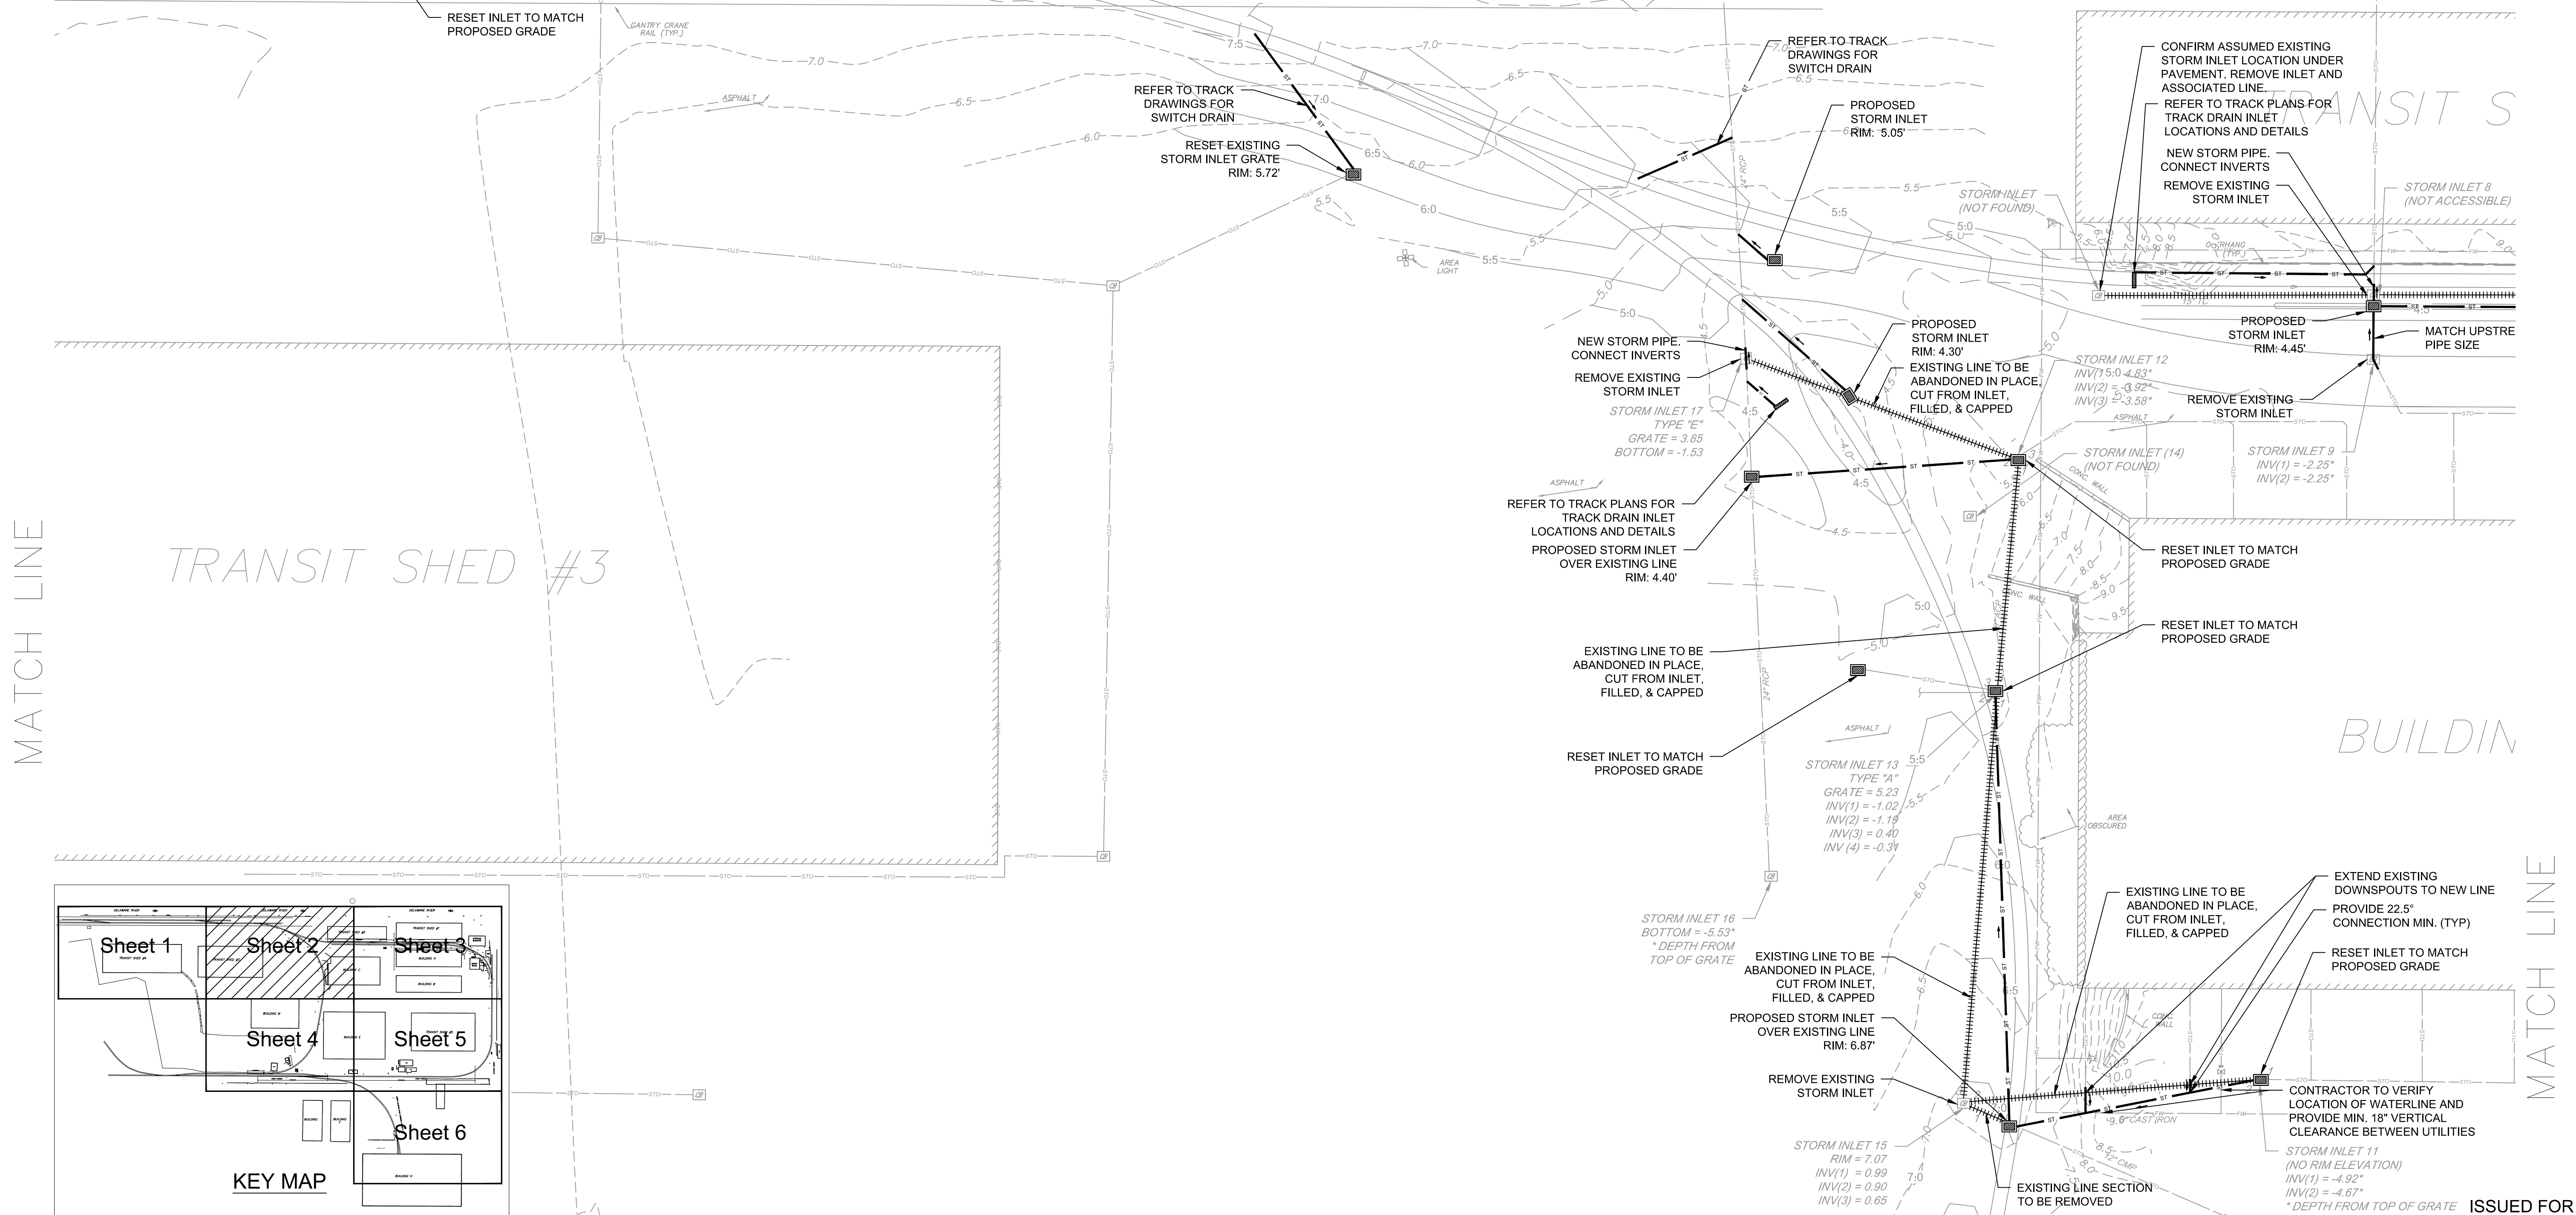



MATCH LINE

MATCH LINE

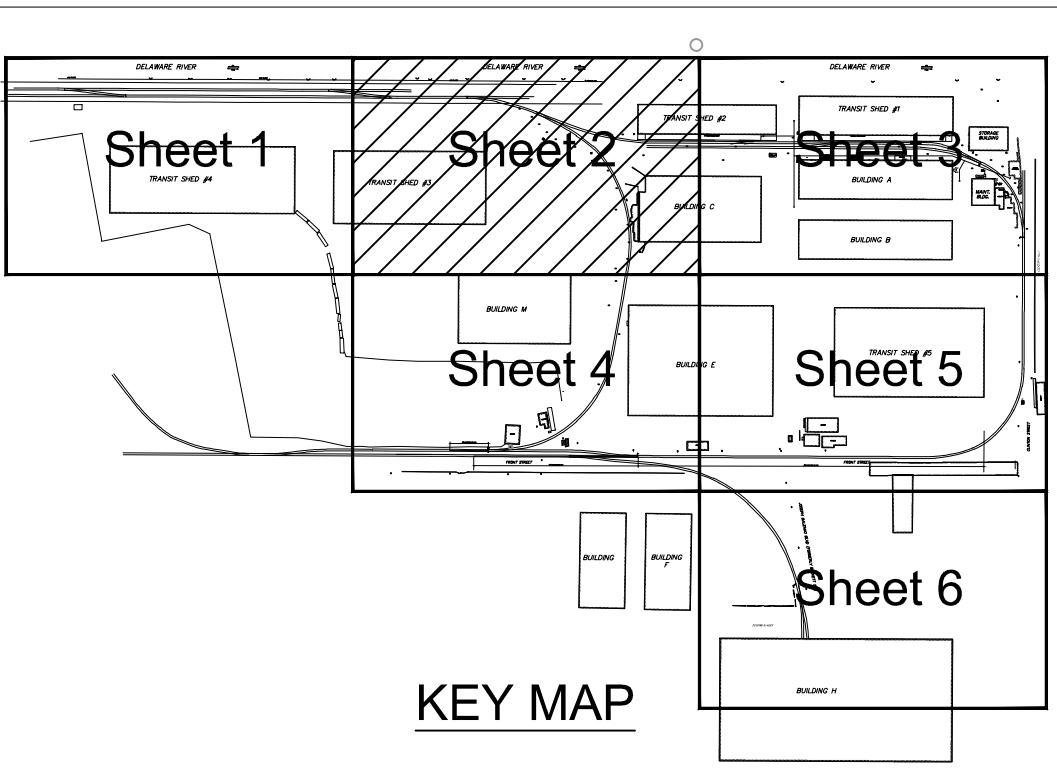

- STORMWATER NOTES:**
- WHERE NEW STORMWATER PIPES ARE TO BE INSTALLED THE CONTRACTOR IS TO FIELD VERIFY EXISTING DOWNSTREAM STORMWATER PIPE SIZE. NEW STORMWATER PIPE TO BE INSTALLED IS TO MATCH THE DOWNSTREAM SIZE.
 - NEW STORMWATER PIPE INVERTS MUST MATCH OR BE BETWEEN UPSTREAM AND DOWNSTREAM PIPE INVERTS WHILE MAINTAINING MINIMUM SLOPE PER NOTE #3.
 - CONTRACTOR TO MAINTAIN MINIMUM 0.50% SLOPE, IN A DOWNSTREAM DIRECTION, ON STORMWATER PIPES.
 - NEW STORMWATER PIPES SHALL MAINTAIN 18" MINIMUM COVER TO CROWN OF PIPE.
 - ALL STORMWATER PIPES SHALL BE CONNECTED TO STORMWATER CONVEYANCE NETWORK AS SHOWN AND SHALL DRAIN TO EXISTING OUTLETS AND OUTFALLS.
 - CONTRACTOR TO FIELD VERIFY LOCATION OF EXISTING UTILITIES PRIOR TO INSTALLATION OF NEW STORMWATER PIPE TO AVOID POTENTIAL CONFLICTS. WHERE UTILITY/PIPE CROSSINGS ARE REQUIRED, CONTRACTOR TO NOTIFY ENGINEER.
 - CONTRACTOR TO INSPECT AND CLEAR ALL EXISTING DOWNSTREAM PIPES IN ACCORDANCE TO SPECIFICATION 330130.11, TELEVISION INSPECTION OF SEWERS.

MATCH LINE

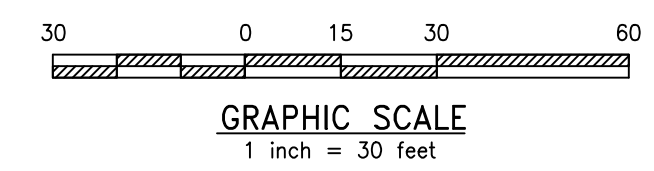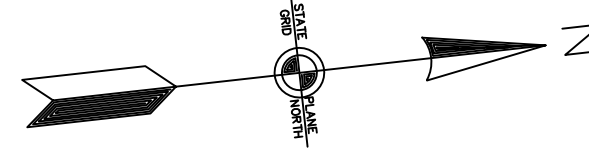

SHEET 4

REV	BY	DATE	DESCRIPTION




URBAN ENGINEERS, INC.
 530 Walnut Street
 Philadelphia, PA 19106
 (215) 922-8080 Fax (215) 922-8082

LOCATION: **CAMDEN, NJ**

TITLE: **SJPC BALZANO MARINE TERMINAL RAIL INFRASTRUCTURE REHABILITATION PROPOSED STORM & WATER 2**



DWN: GJB PROJ #: 2021500064.000 DRAWING NUMBER: **C-202**
 CHR: MJT DATE: 06/24/2022

DELAWARE RIVER

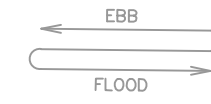

SHEET 2



MATCH LINE

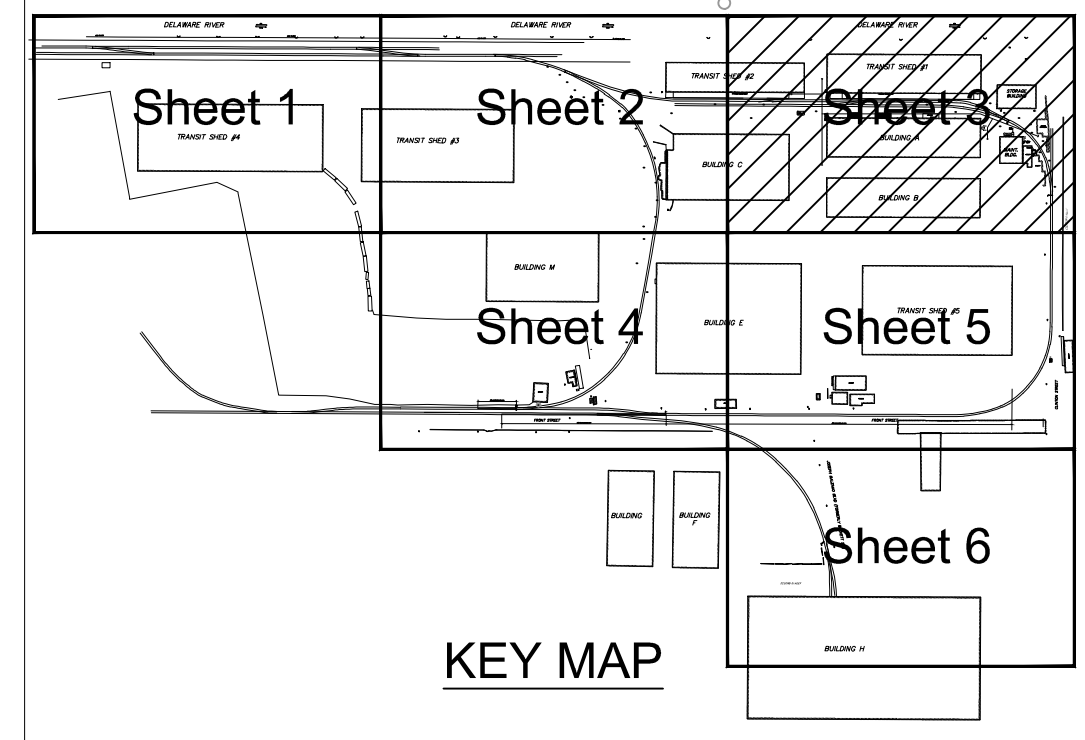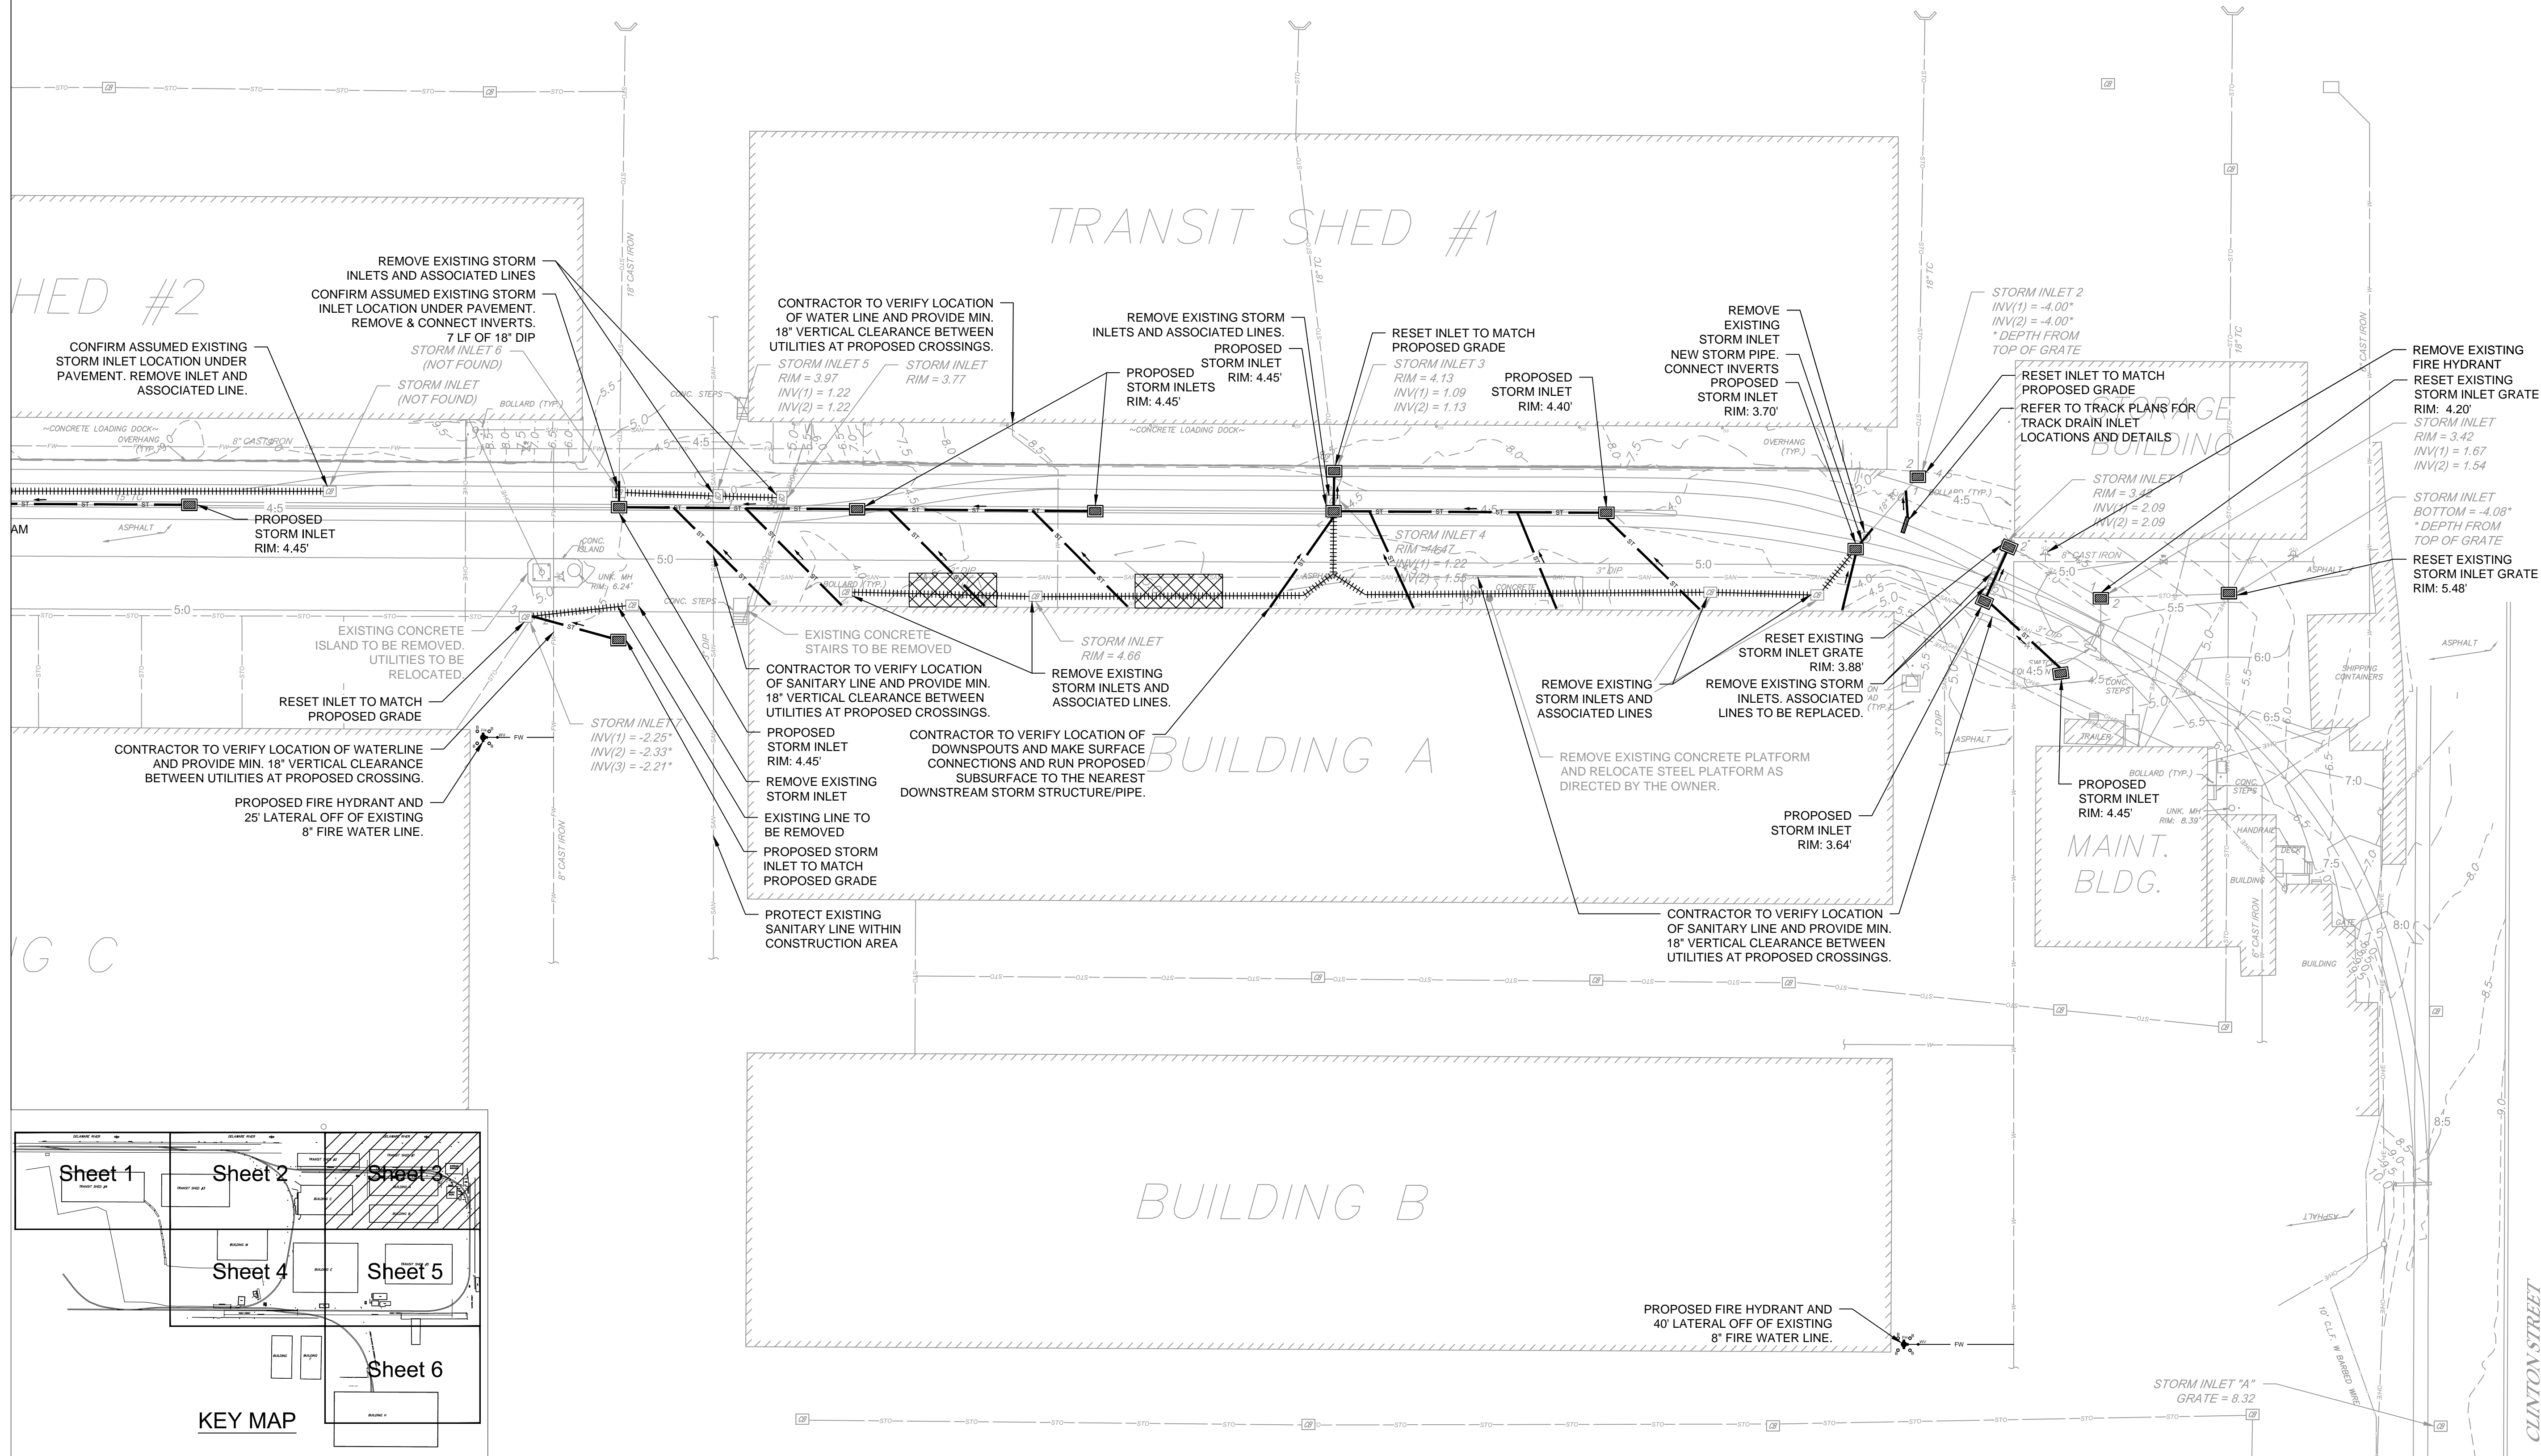


- STORMWATER NOTES:**
- WHERE NEW STORMWATER PIPES ARE TO BE INSTALLED THE CONTRACTOR IS TO FIELD VERIFY EXISTING DOWNSTREAM STORMWATER PIPE SIZE. NEW STORMWATER PIPE TO BE INSTALLED IS TO MATCH THE DOWNSTREAM SIZE.
 - NEW STORMWATER PIPE INVERTS MUST MATCH OR BE BETWEEN UPSTREAM AND DOWNSTREAM PIPE INVERTS WHILE MAINTAINING MINIMUM SLOPE PER NOTE #3.
 - CONTRACTOR TO MAINTAIN MINIMUM 0.50% SLOPE, IN A DOWNSTREAM DIRECTION, ON STORMWATER PIPES.
 - NEW STORMWATER PIPES SHALL MAINTAIN 18" MINIMUM COVER TO CROWN OF PIPE.
 - ALL STORMWATER PIPES SHALL BE CONNECTED TO STORMWATER CONVEYANCE NETWORK AS SHOWN AND SHALL DRAIN TO EXISTING OUTLETS AND OUTFALLS.
 - CONTRACTOR TO FIELD VERIFY LOCATION OF EXISTING UTILITIES PRIOR TO INSTALLATION OF NEW STORMWATER PIPE TO AVOID POTENTIAL CONFLICTS. WHERE UTILITY/PIPE CROSSINGS ARE REQUIRED, CONTRACTOR TO NOTIFY ENGINEER.
 - CONTRACTOR TO INSPECT AND CLEAR ALL EXISTING DOWNSTREAM PIPES IN ACCORDANCE TO SPECIFICATION 330130.11, TELEVISION INSPECTION OF SEWERS.

MATCH LINE

SHEET 5

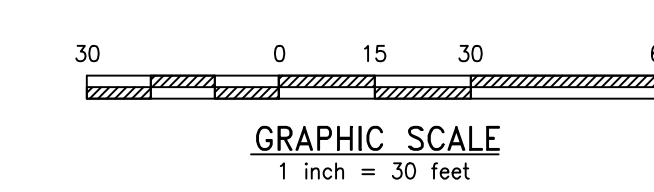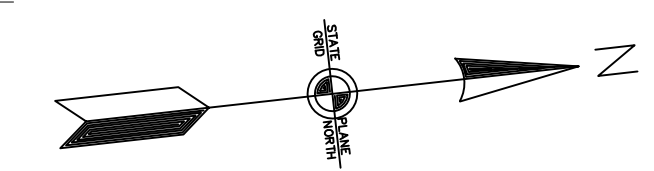

REV	BY	DATE	DESCRIPTION

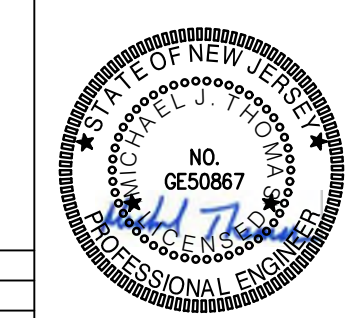

ISSUED FOR BID

URBAN ENGINEERS, INC.
530 Walnut Street
Philadelphia, PA 19106
(215) 922-8080 Fax (215) 922-8082

LOCATION CAMDEN, NJ

TITLE SJPC BALZANO MARINE TERMINAL RAIL INFRASTRUCTURE REHABILITATION PROPOSED STORM & WATER 3

DWN: GJB PROJ #: 2021500064.000 DRAWING NUMBER: C-203
CHK: MJT DATE: 06/24/2022

MATCH LINE


SHEET 2

SHEET 5



BUILDING M

BUILDING

MATCH LINE

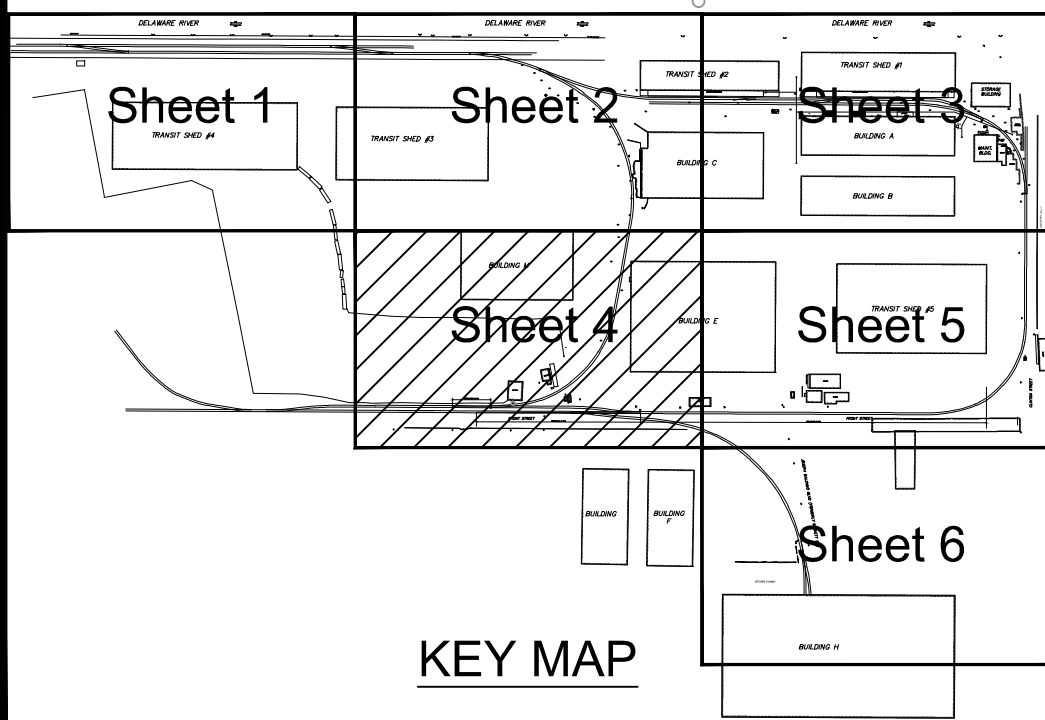

- STORMWATER NOTES:**
1. WHERE NEW STORMWATER PIPES ARE TO BE INSTALLED THE CONTRACTOR IS TO FIELD VERIFY EXISTING DOWNSTREAM STORMWATER PIPE SIZE. NEW STORMWATER PIPE TO BE INSTALLED IS TO MATCH THE DOWNSTREAM SIZE.
 2. NEW STORMWATER PIPE INVERTS MUST MATCH OR BE BETWEEN UPSTREAM AND DOWNSTREAM PIPE INVERTS WHILE MAINTAINING MINIMUM SLOPE PER NOTE #3.
 3. CONTRACTOR TO MAINTAIN MINIMUM 0.50% SLOPE, IN A DOWNSTREAM DIRECTION, ON STORMWATER PIPES.
 4. NEW STORMWATER PIPES SHALL MAINTAIN 18" MINIMUM COVER TO CROWN OF PIPE.
 5. ALL STORMWATER PIPES SHALL BE CONNECTED TO STORMWATER CONVEYANCE NETWORK AS SHOWN AND SHALL DRAIN TO EXISTING OUTLETS AND OUTFALLS.
 6. CONTRACTOR TO FIELD VERIFY LOCATION OF EXISTING UTILITIES PRIOR TO INSTALLATION OF NEW STORMWATER PIPE TO AVOID POTENTIAL CONFLICTS. WHERE UTILITY/PIPE CROSSINGS ARE REQUIRED, CONTRACTOR TO NOTIFY ENGINEER.
 7. CONTRACTOR TO INSPECT AND CLEAR ALL EXISTING DOWNSTREAM PIPES IN ACCORDANCE TO SPECIFICATION 330130.11, TELEVISION INSPECTION OF SEWERS.

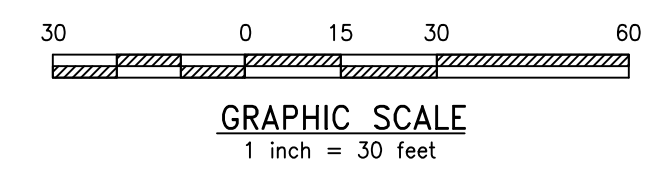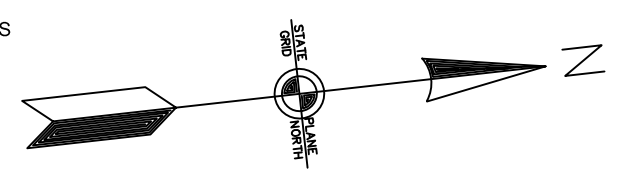

ISSUED FOR BID



URBAN ENGINEERS, INC.
530 Walnut Street
Philadelphia, PA 19106
(215) 922-8080 Fax (215) 922-8082


LOCATION: **CAMDEN, NJ**
TITLE: **SJPC BALZANO MARINE TERMINAL RAIL INFRASTRUCTURE REHABILITATION PROPOSED STORM & WATER 4**

DWN: GJB PROJ # 2021500064.000 DRAWING NUMBER: **C-204**
CHK: MJT DATE 06/24/2022

REV	BY	DATE	DESCRIPTION


MATCH LINE

SHEET 3

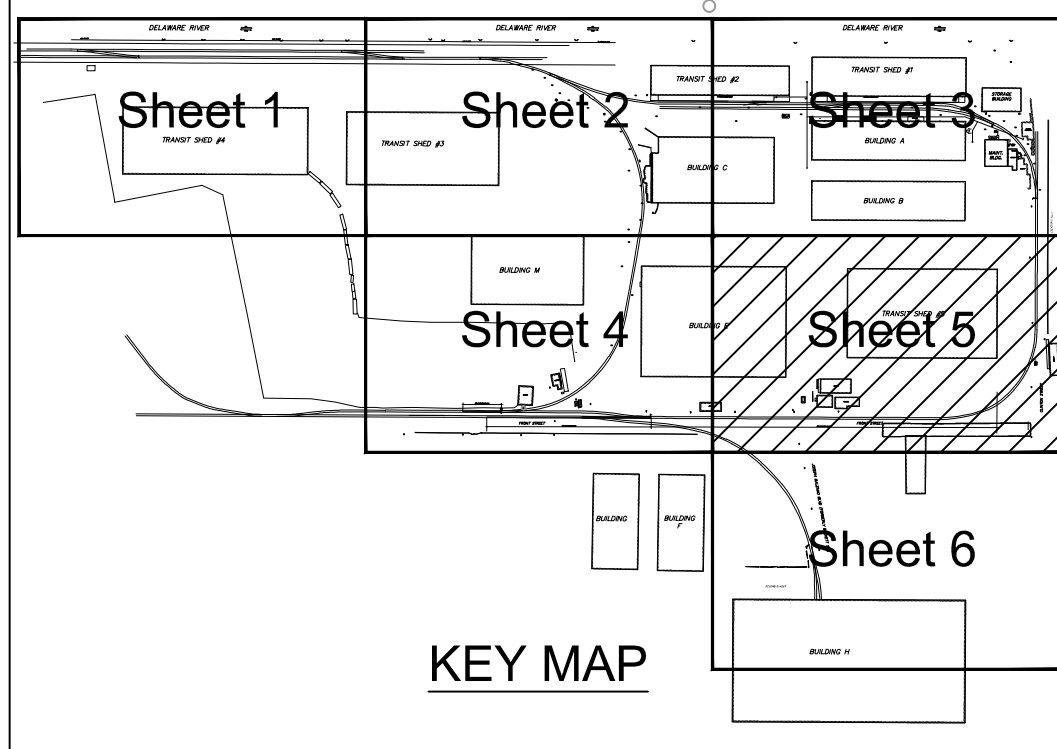

SHEET 4

TRANSIT SHED #5


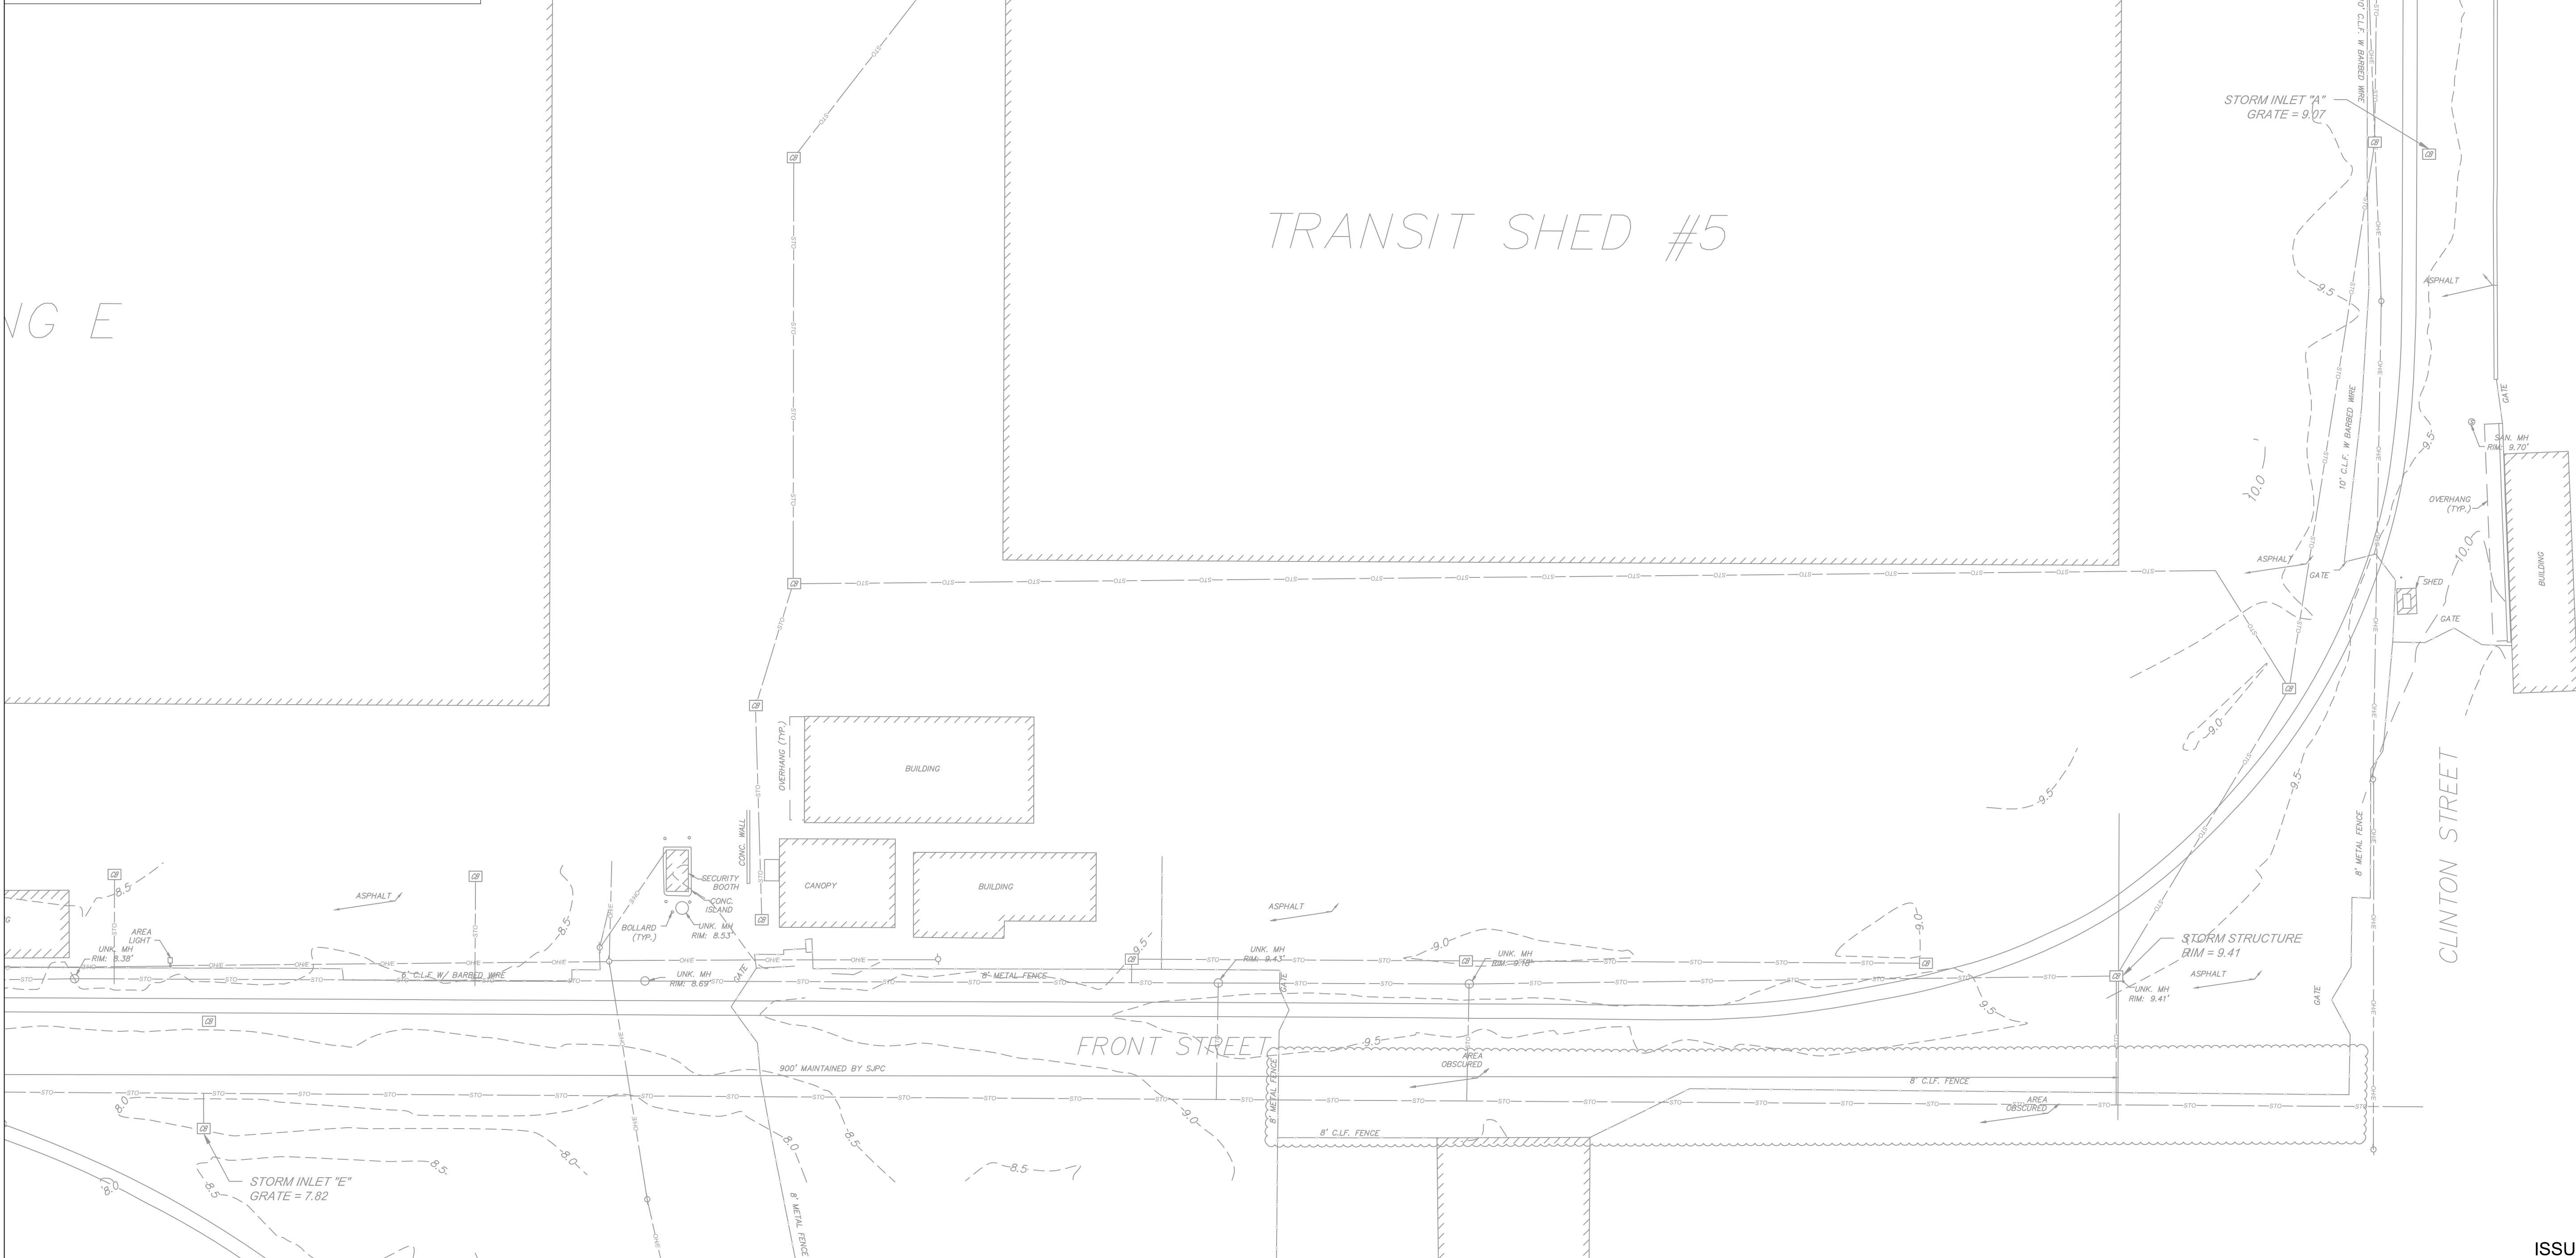


MATCH LINE

MATCH LINE


STORMWATER NOTES:

1. WHERE NEW STORMWATER PIPES ARE TO BE INSTALLED THE CONTRACTOR IS TO FIELD VERIFY EXISTING DOWNSTREAM STORMWATER PIPE SIZE. NEW STORMWATER PIPE TO BE INSTALLED IS TO MATCH THE DOWNSTREAM SIZE.
2. NEW STORMWATER PIPE INVERTS MUST MATCH OR BE BETWEEN UPSTREAM AND DOWNSTREAM PIPE INVERTS WHILE MAINTAINING MINIMUM SLOPE PER NOTE #3.
3. CONTRACTOR TO MAINTAIN MINIMUM 0.50% SLOPE, IN A DOWNSTREAM DIRECTION, ON STORMWATER PIPES.
4. NEW STORMWATER PIPES SHALL MAINTAIN 18" MINIMUM COVER TO CROWN OF PIPE.
5. ALL STORMWATER PIPES SHALL BE CONNECTED TO STORMWATER CONVEYANCE NETWORK AS SHOWN AND SHALL DRAIN TO EXISTING OUTLETS AND OUTFALLS.
6. CONTRACTOR TO FIELD VERIFY LOCATION OF EXISTING UTILITIES PRIOR TO INSTALLATION OF NEW STORMWATER PIPE TO AVOID POTENTIAL CONFLICTS. WHERE UTILITY/PIPE CROSSINGS ARE REQUIRED, CONTRACTOR TO NOTIFY ENGINEER.
7. CONTRACTOR TO INSPECT AND CLEAR ALL EXISTING DOWNSTREAM PIPES IN ACCORDANCE TO SPECIFICATION 330130.11. TELEVISION INSPECTION OF SEWERS.

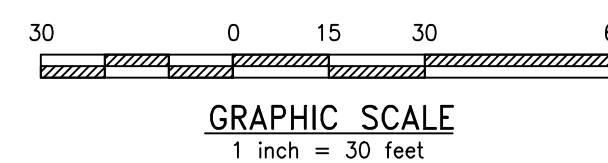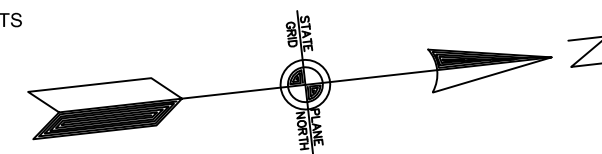

SHEET 6

ISSUED FOR BID


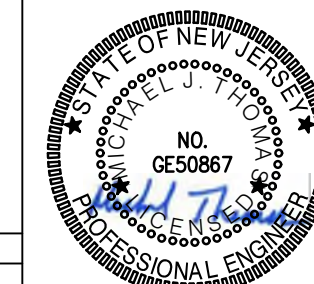


URBAN ENGINEERS, INC.
 530 Walnut Street
 Philadelphia, PA 19106
 (215) 922-8080 Fax (215) 922-8082

LOCATION: **CAMDEN, NJ**
 TITLE: **SJPC BALZANO MARINE TERMINAL RAIL INFRASTRUCTURE REHABILITATION PROPOSED STORM & WATER 5**
 EWN: GJB PROJ #: 2021500064.000 DRAWING NUMBER: **C-205**
 CHK: MJT DATE: 06/24/2022

REV	BY	DATE	DESCRIPTION

MATCH LINE



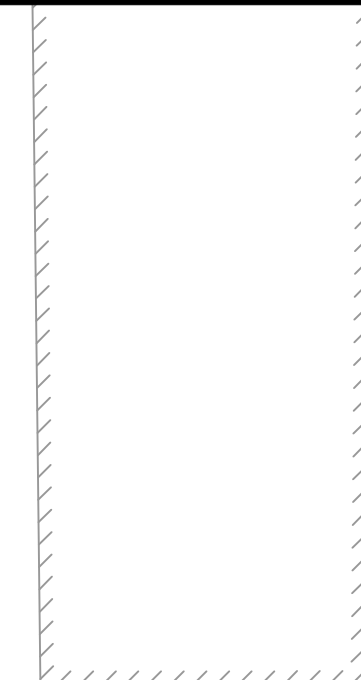
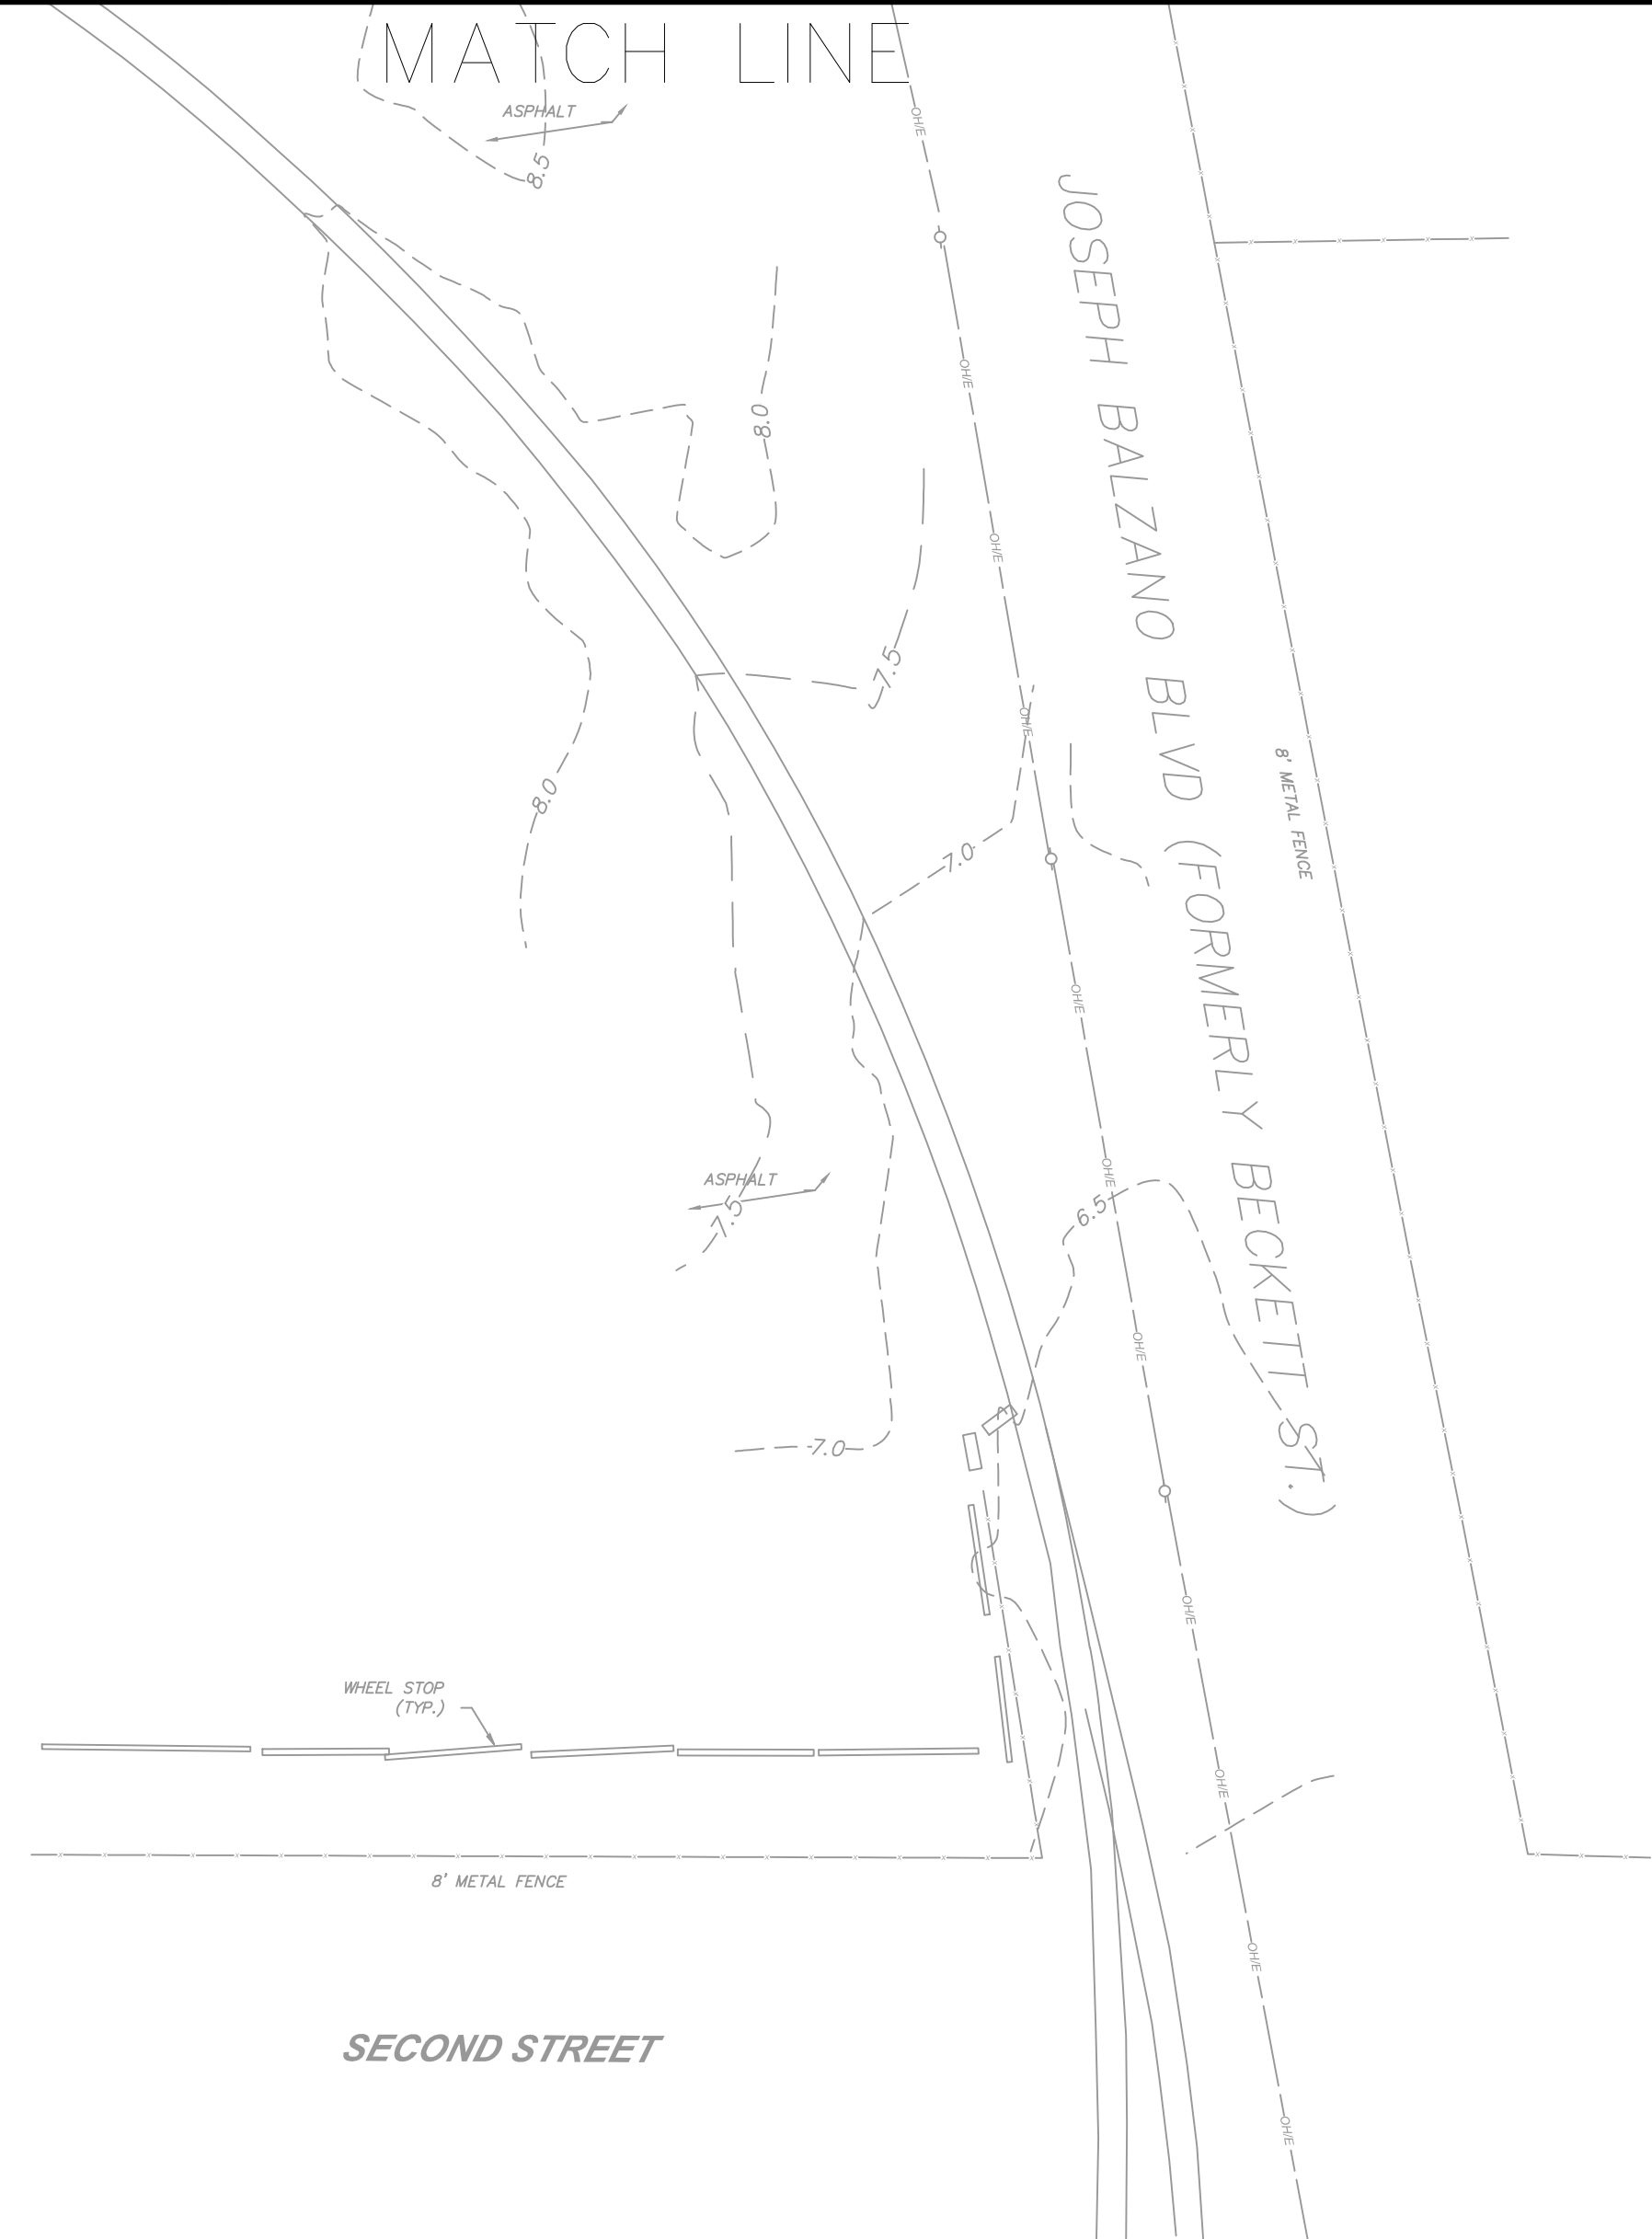


SECOND STREET

BUILDING H

STORMWATER NOTES:

1. WHERE NEW STORMWATER PIPES ARE TO BE INSTALLED THE CONTRACTOR IS TO FIELD VERIFY EXISTING DOWNSTREAM STORMWATER PIPE SIZE. NEW STORMWATER PIPE TO BE INSTALLED IS TO MATCH THE DOWNSTREAM SIZE.
2. NEW STORMWATER PIPE INVERTS MUST MATCH OR BE BETWEEN UPSTREAM AND DOWNSTREAM PIPE INVERTS WHILE MAINTAINING MINIMUM SLOPE PER NOTE #3.
3. CONTRACTOR TO MAINTAIN MINIMUM 0.50% SLOPE, IN A DOWNSTREAM DIRECTION, ON STORMWATER PIPES.
4. NEW STORMWATER PIPES SHALL MAINTAIN 18" MINIMUM COVER TO CROWN OF PIPE.
5. ALL STORMWATER PIPES SHALL BE CONNECTED TO STORMWATER CONVEYANCE NETWORK AS SHOWN AND SHALL DRAIN TO EXISTING OUTLETS AND OUTFALLS.
6. CONTRACTOR TO FIELD VERIFY LOCATION OF EXISTING UTILITIES PRIOR TO INSTALLATION OF NEW STORMWATER PIPE TO AVOID POTENTIAL CONFLICTS. WHERE UTILITY/PIPE CROSSINGS ARE REQUIRED, CONTRACTOR TO NOTIFY ENGINEER.
7. CONTRACTOR TO INSPECT AND CLEAR ALL EXISTING DOWNSTREAM PIPES IN ACCORDANCE TO SPECIFICATION 330130.11, TELEVISION INSPECTION OF SEWERS.

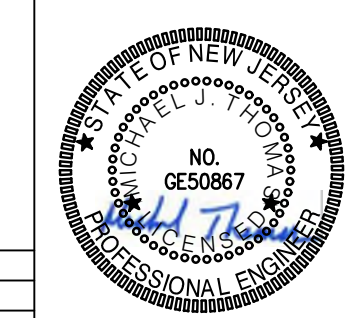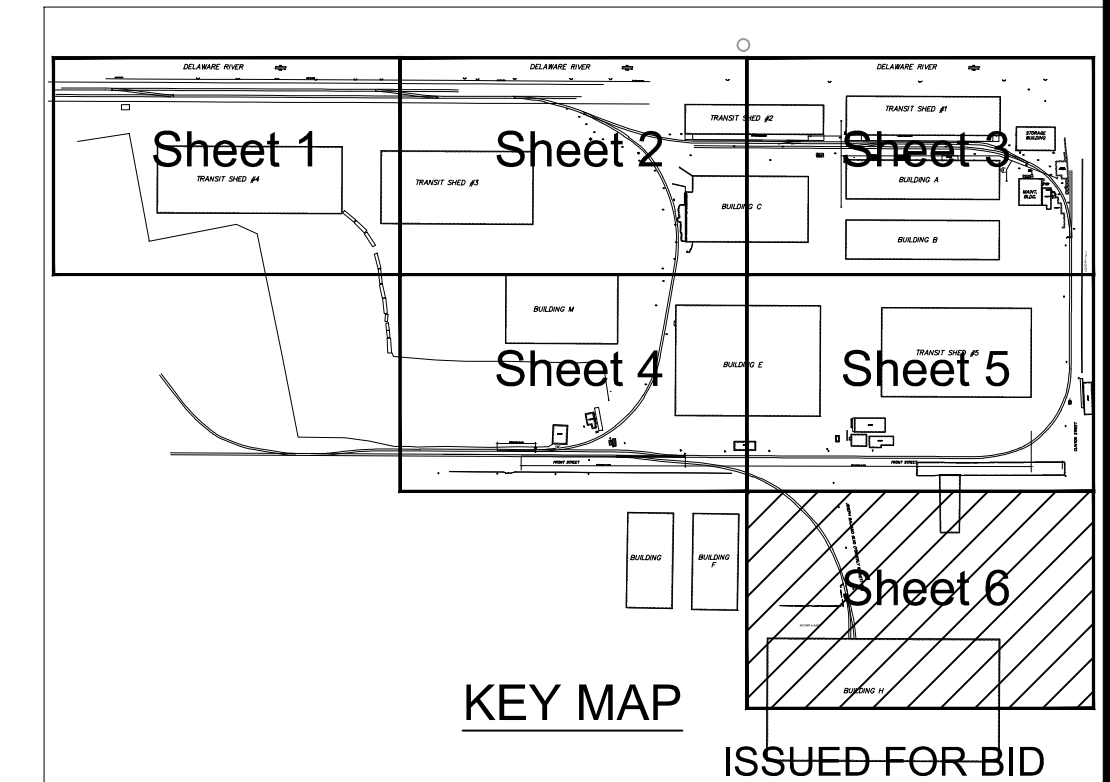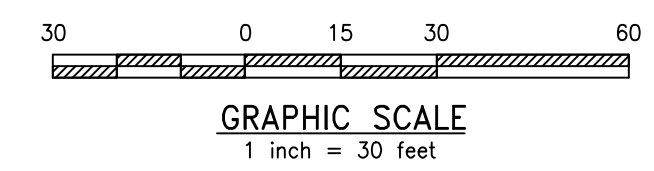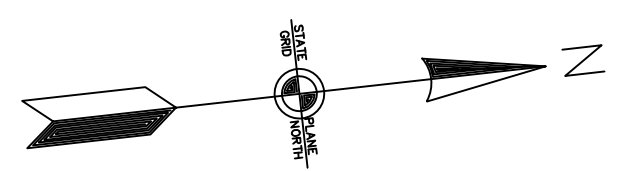

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Philadelphia, PA 19106
(215) 922-8080 Fax (215) 922-8082


LOCATION: CAMDEN, NJ

TITLE: SJPC BALZANO MARINE TERMINAL RAIL INFRASTRUCTURE REHABILITATION PROPOSED STORM & WATER 6

DWN: GJB PROJ #: 2021500064.000 DRAWING NUMBER: C-206
CHK: MJT DATE: 06/24/2022




REV	BY	DATE	DESCRIPTION

DELAWARE RIVER

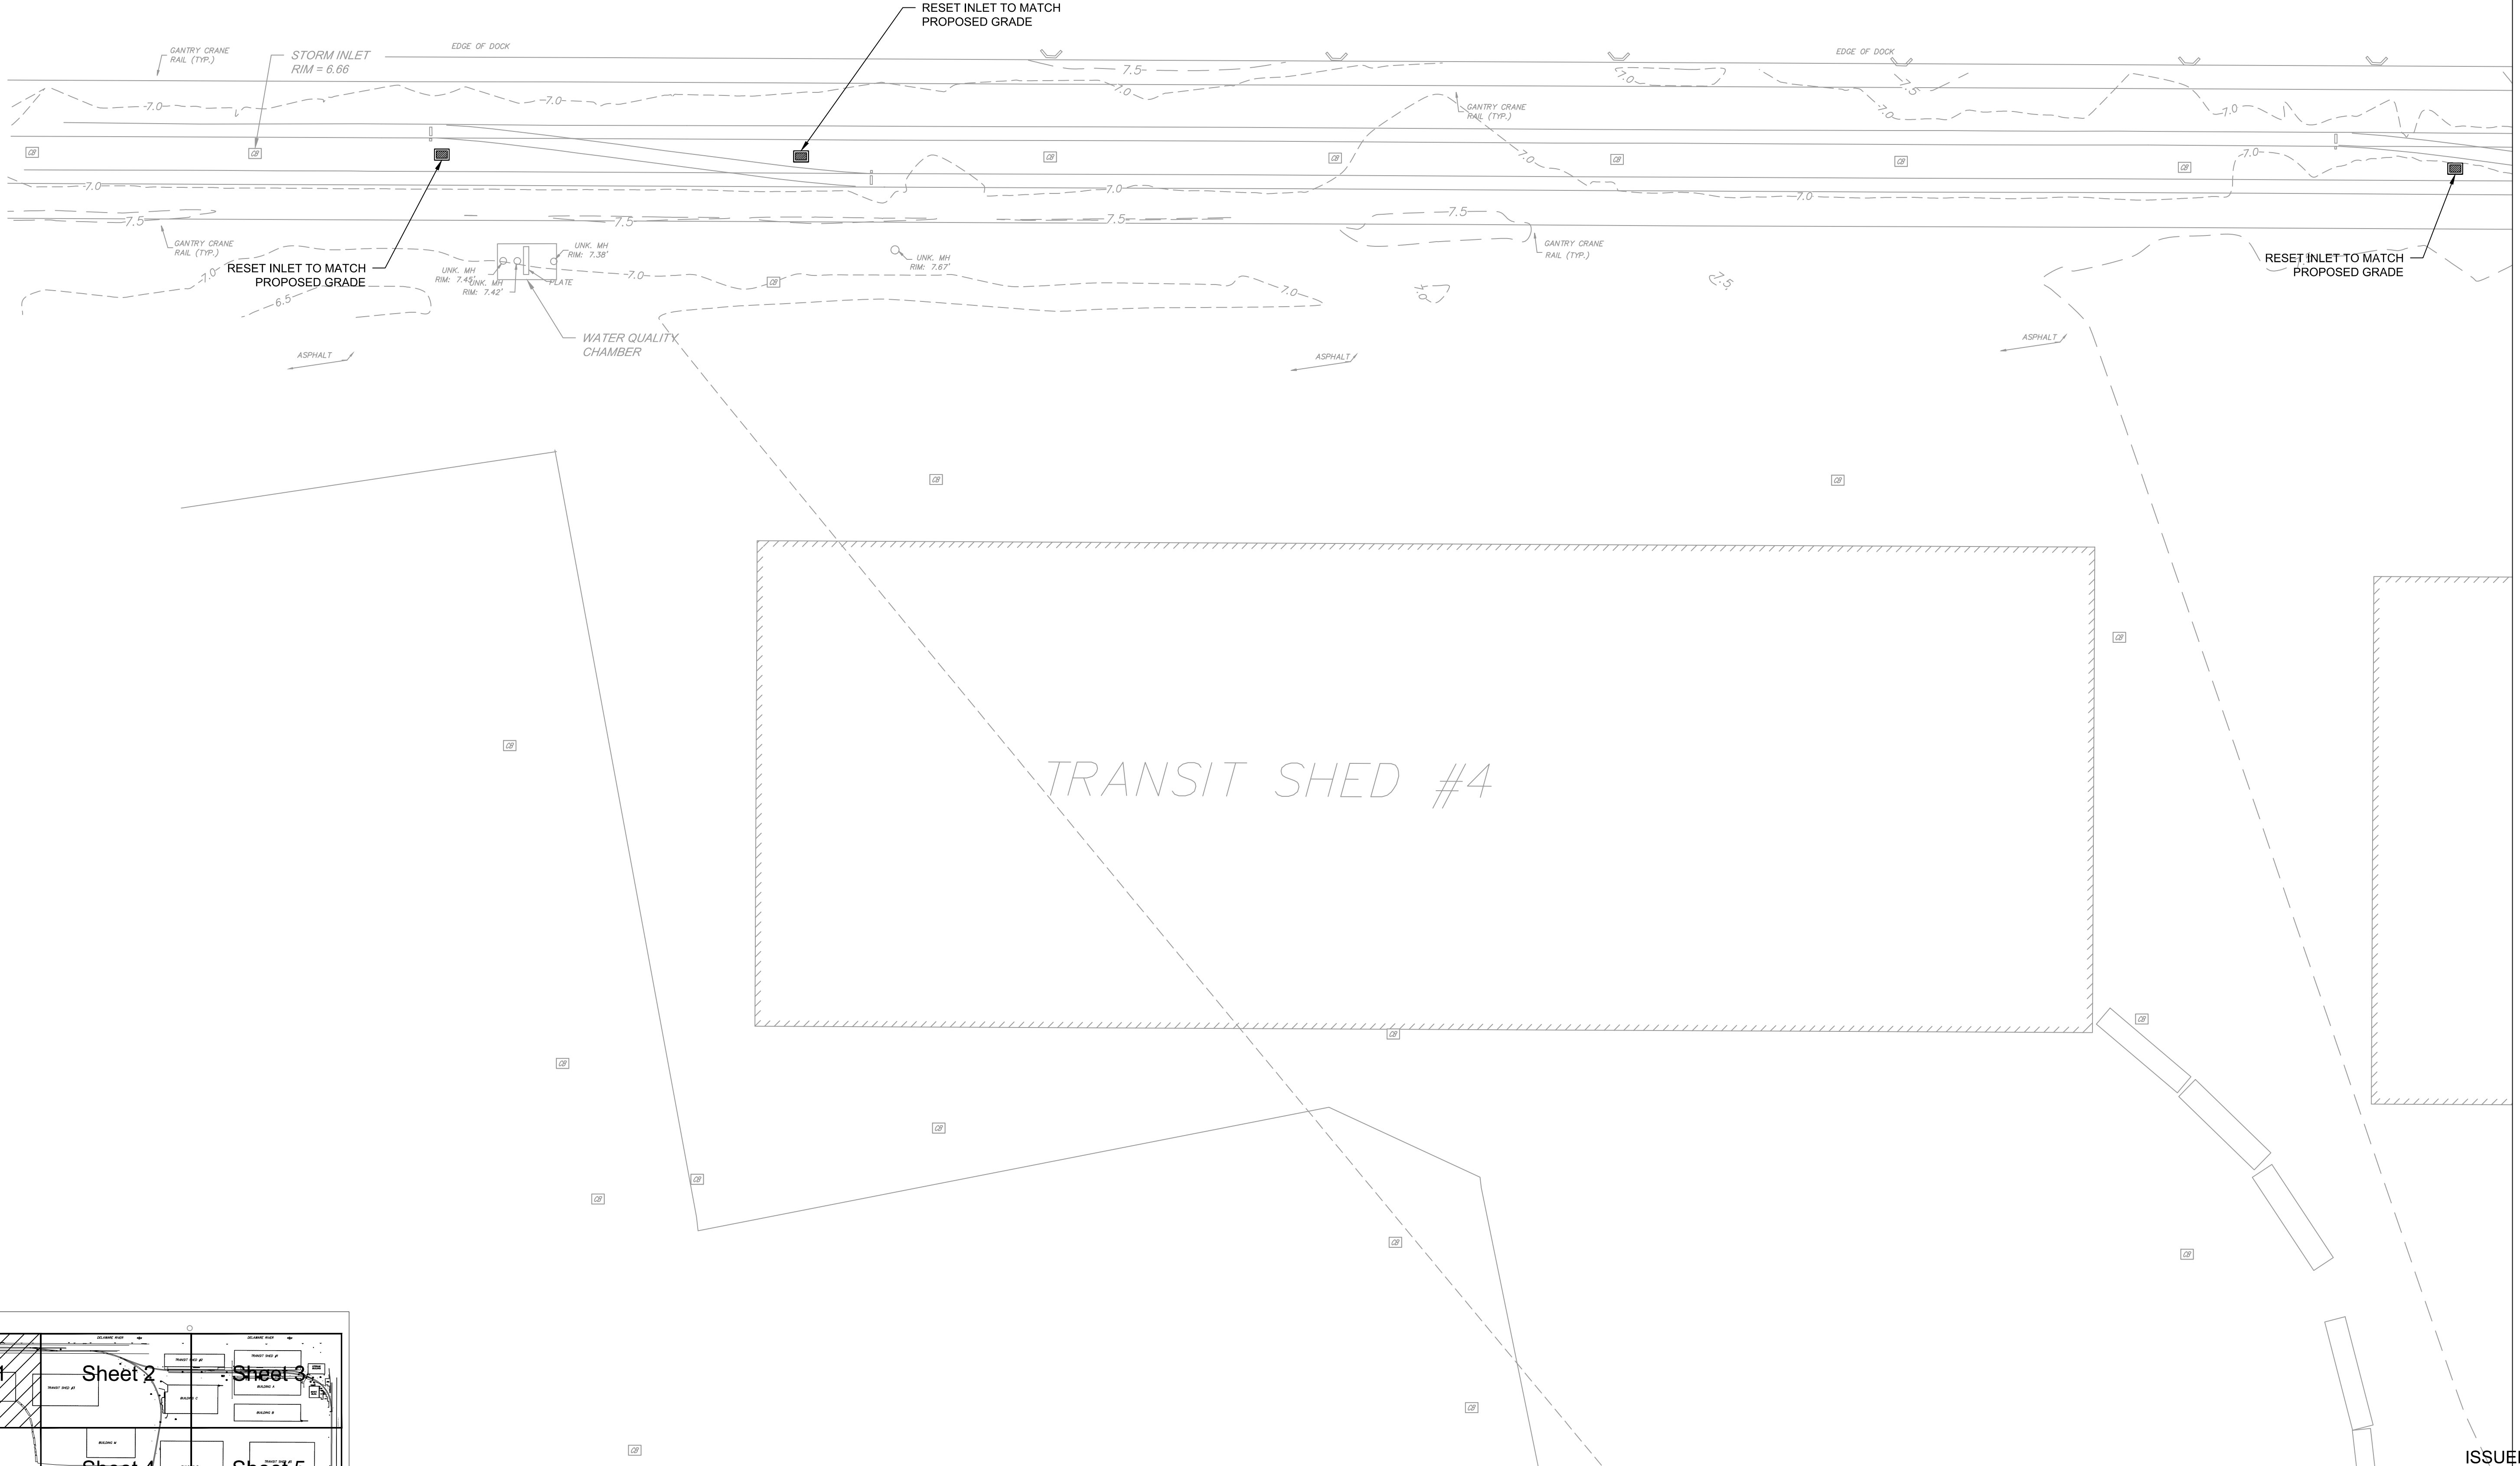


SHEET 2

MATCH LINE

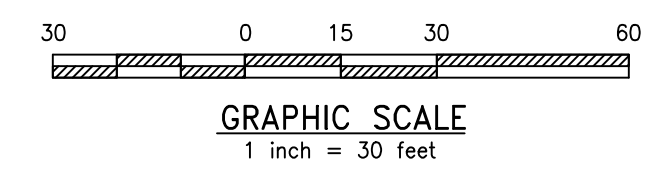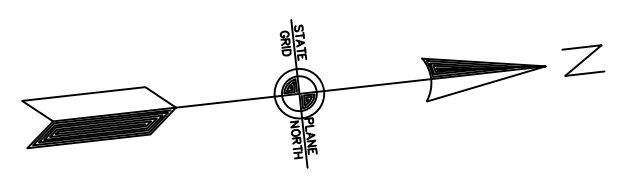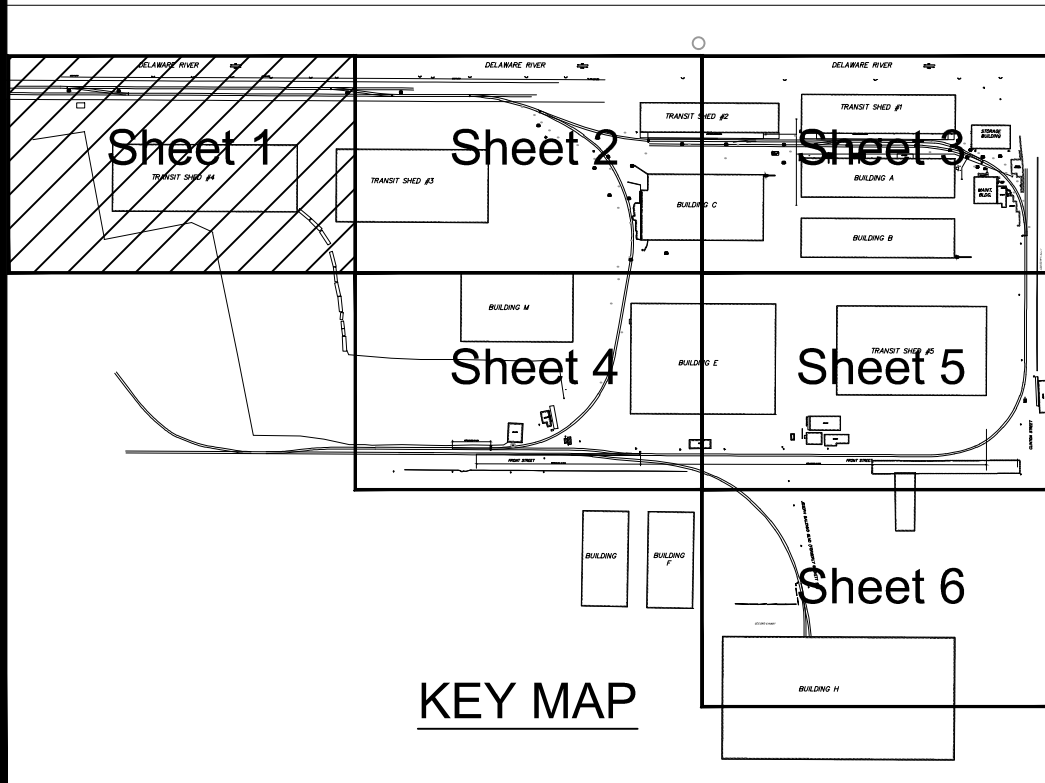

REV	BY	DATE	DESCRIPTION

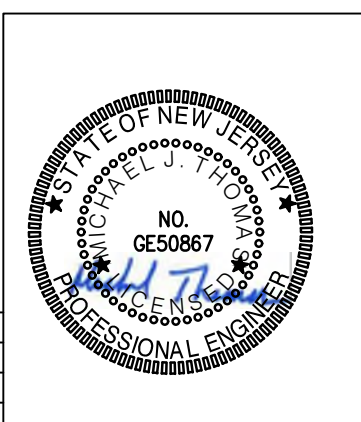

URBAN ENGINEERS, INC.
 530 Walnut Street
 Philadelphia, PA 19106
 (215) 922-8080 Fax (215) 922-8082


LOCATION: **CAMDEN, NJ**

TITLE: **SJPC BALZANO MARINE TERMINAL RAIL INFRASTRUCTURE REHABILITATION PROPOSED GRADING 1**

DWN: GJB PROJ # 2021500064.000 DRAWING NUMBER: **C-301**
 CHR: MJT DATE 06/24/2022

ISSUED FOR BID

DELAWARE RIVER


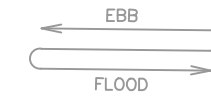


SHEET 1

SHEET 3



MATCH LINE

MATCH LINE

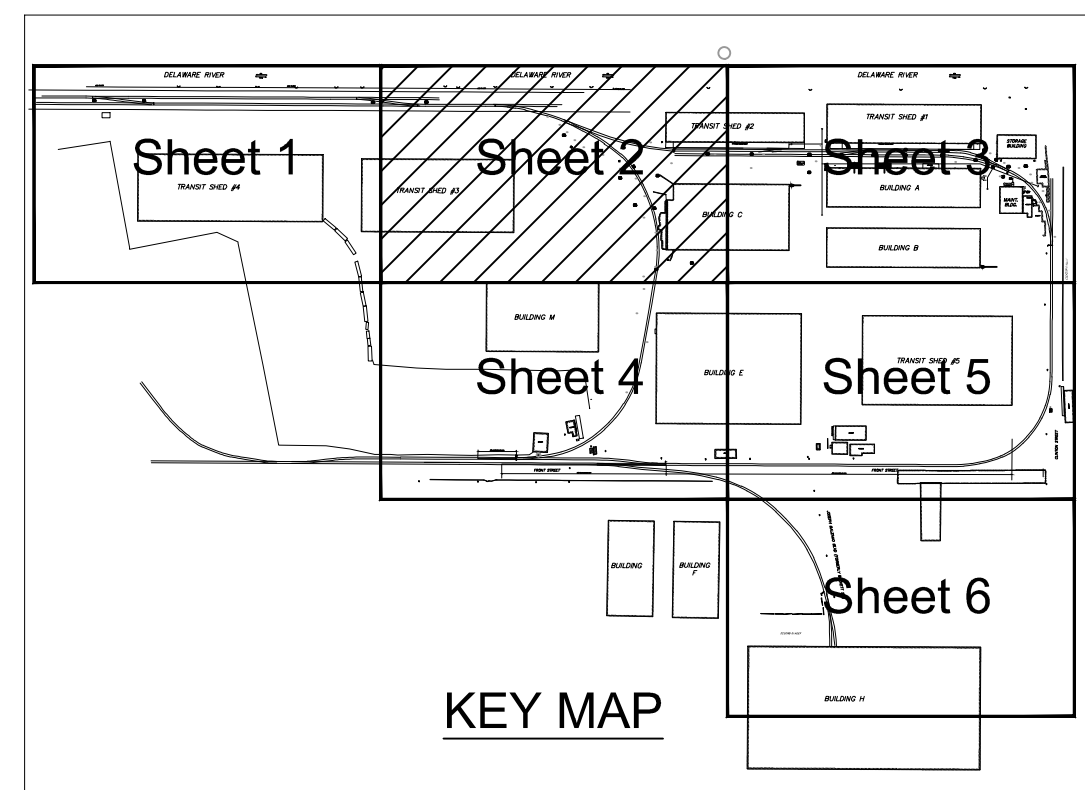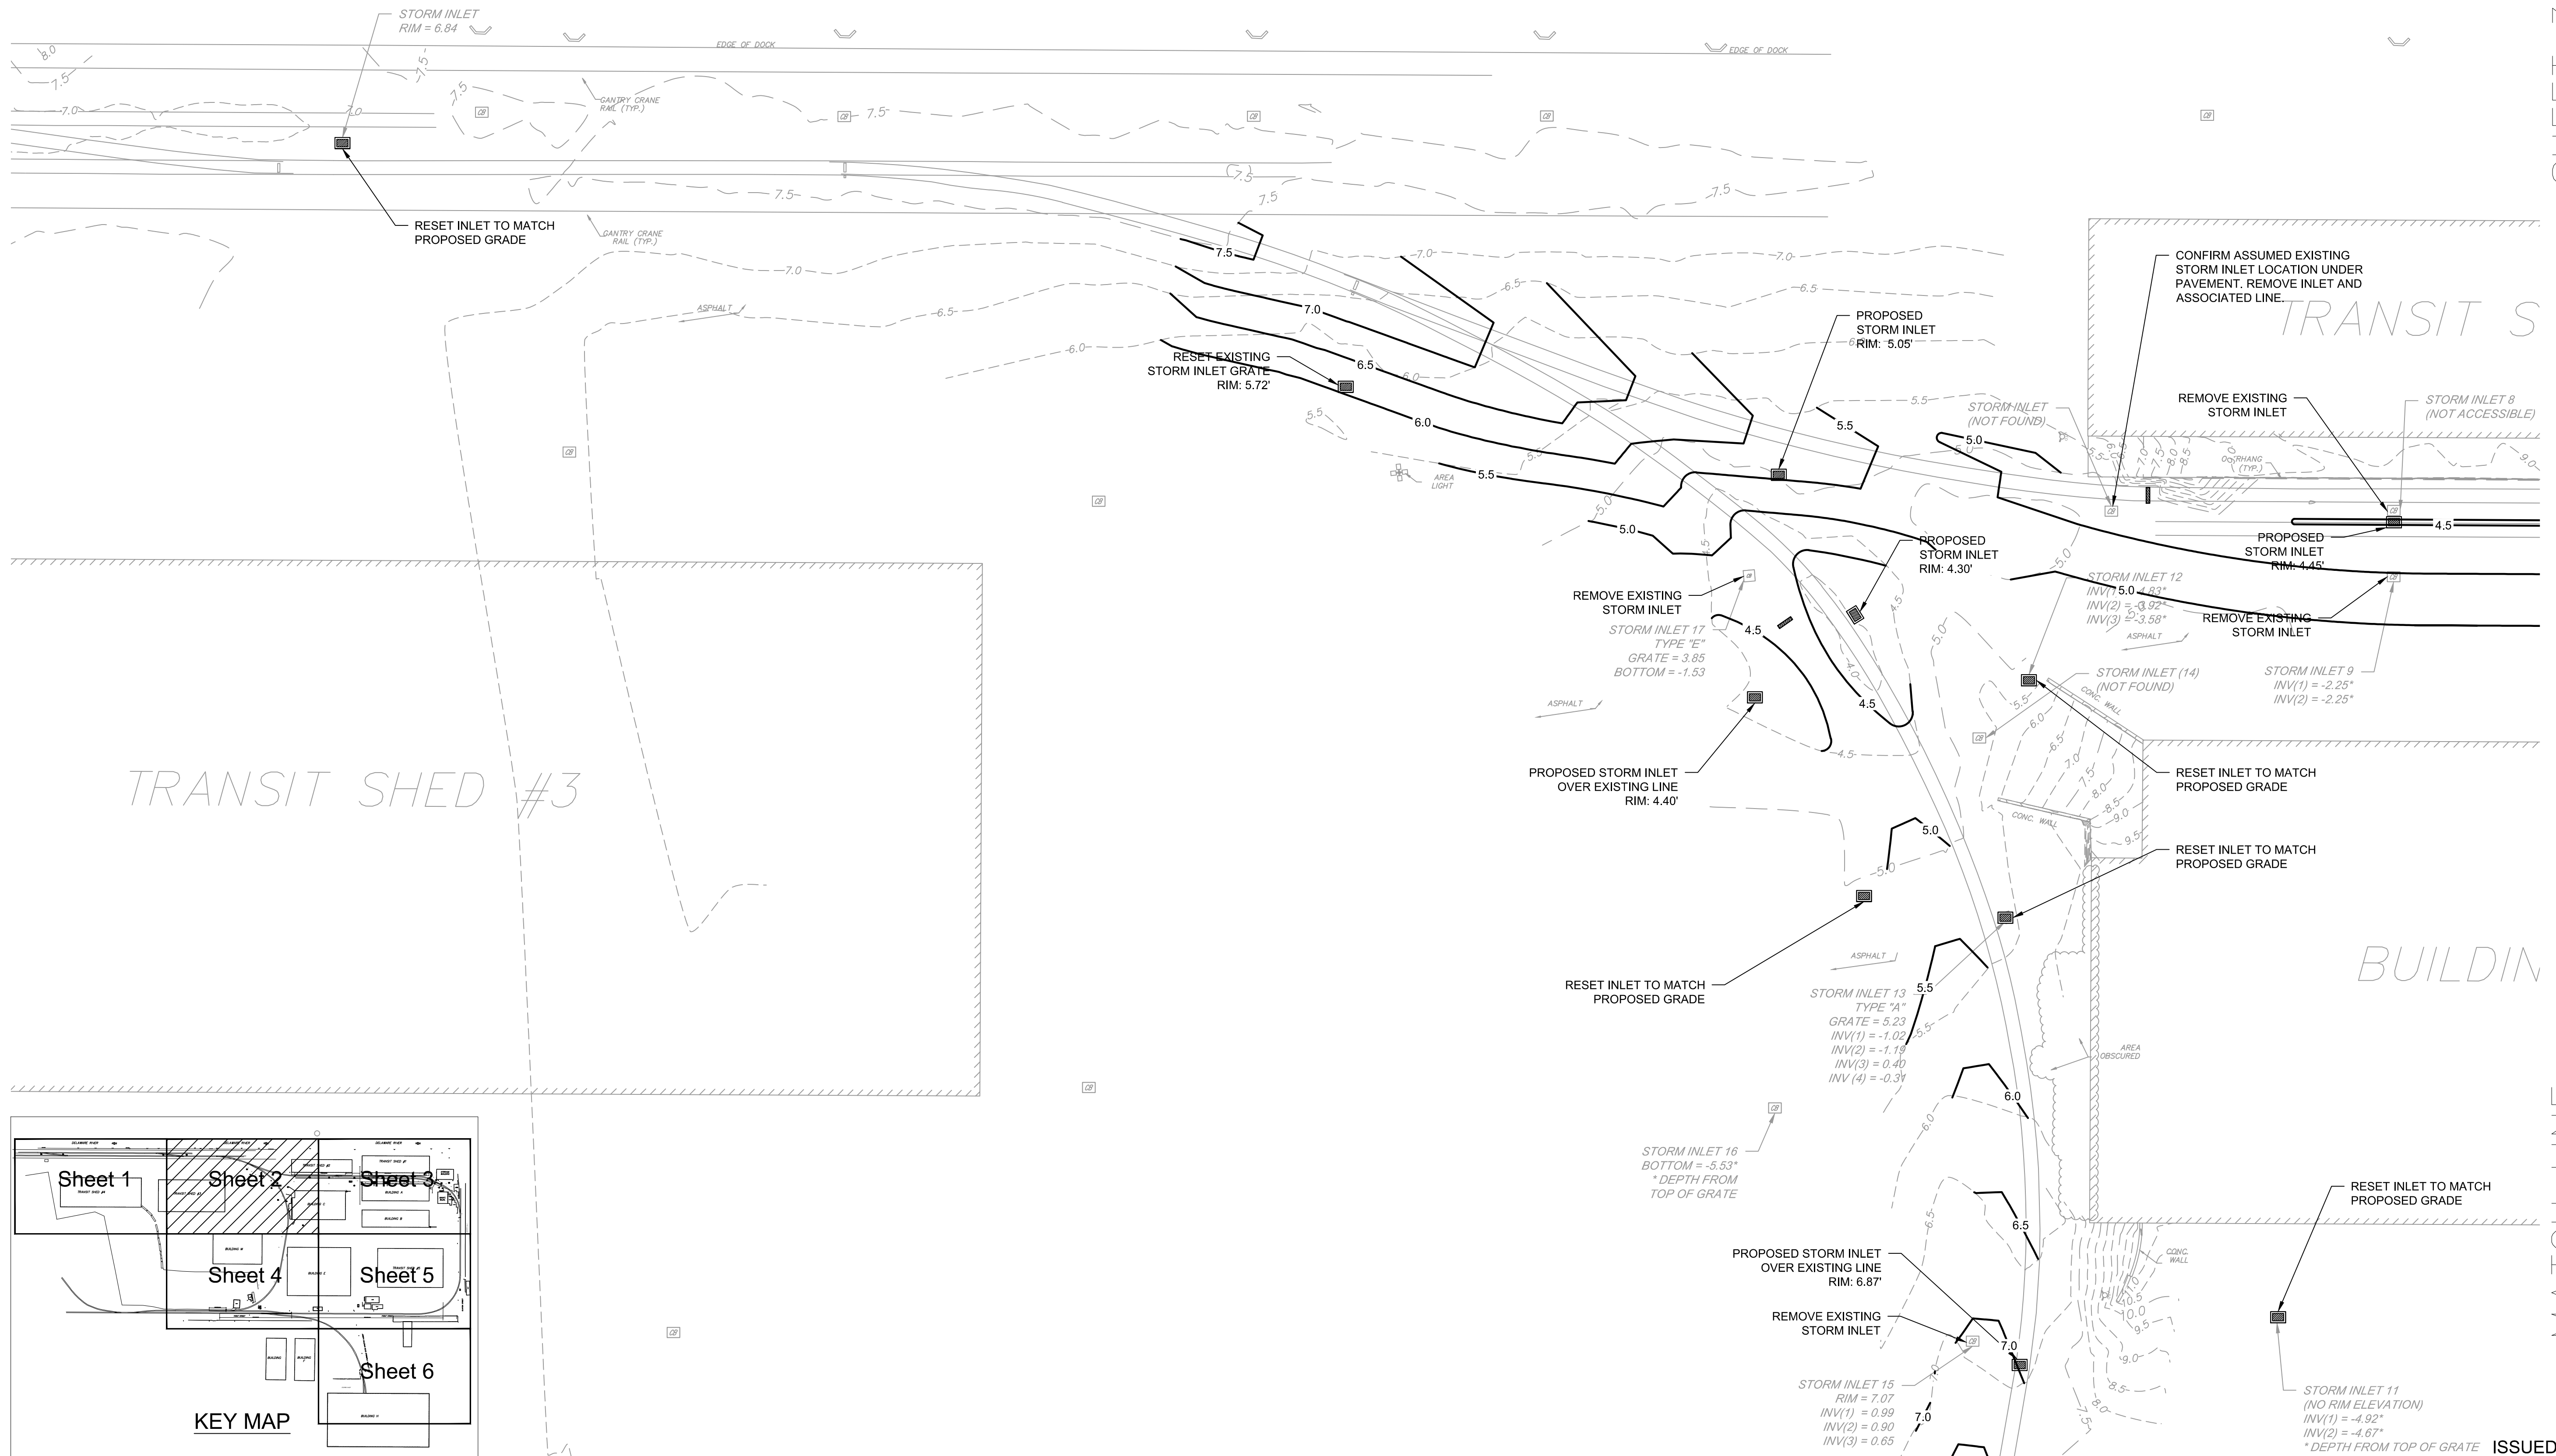

MATCH LINE

SHEET 4

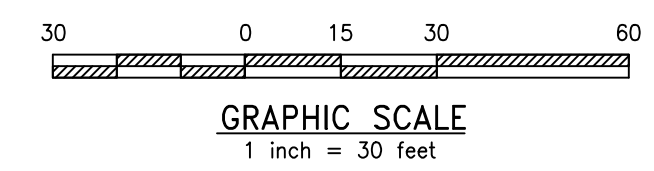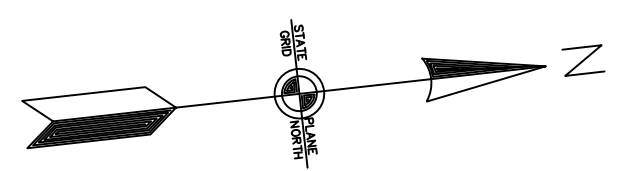

REV	BY	DATE	DESCRIPTION

ISSUED FOR BID

URBAN ENGINEERS, INC.
 530 Walnut Street
 Philadelphia, PA 19106
 (215) 922-8080 Fax (215) 922-8082

LOCATION: **CAMDEN, NJ**


TITLE: **SJPC BALZANO MARINE TERMINAL RAIL INFRASTRUCTURE REHABILITATION PROPOSED GRADING 2**

DWN: GJB PROJ # 2021500064.000 DRAWING NUMBER: **C-302**



CHK: MJT DATE: 06/24/2022

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DELAWARE RIVER

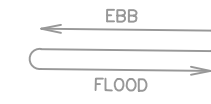



SHEET 2

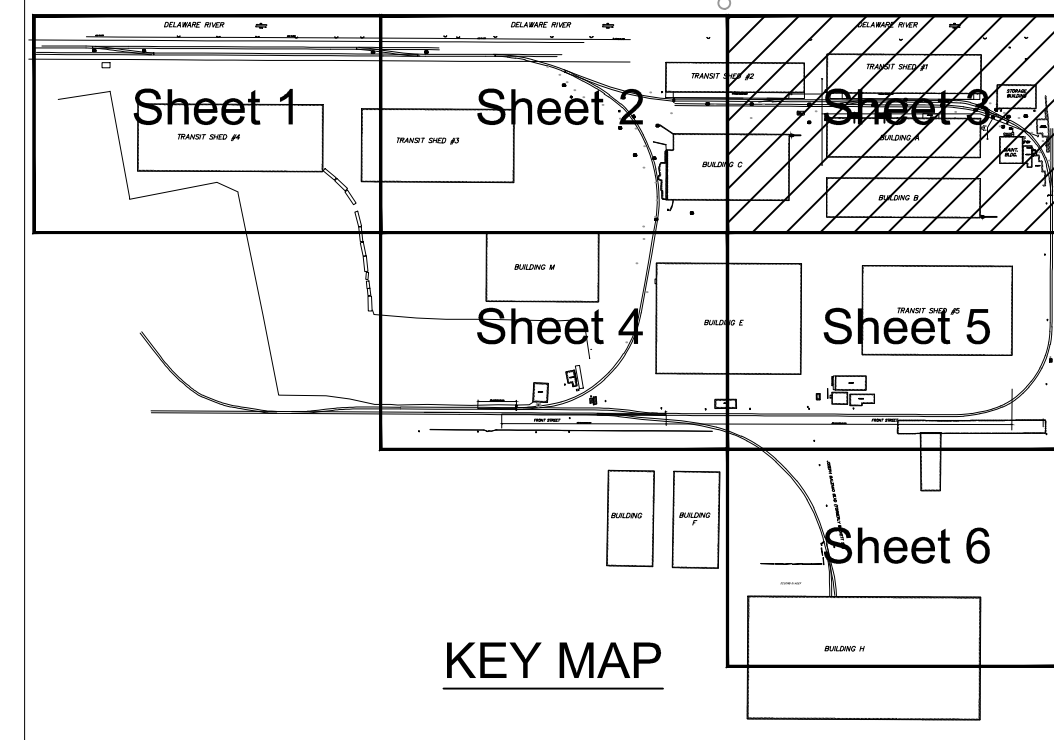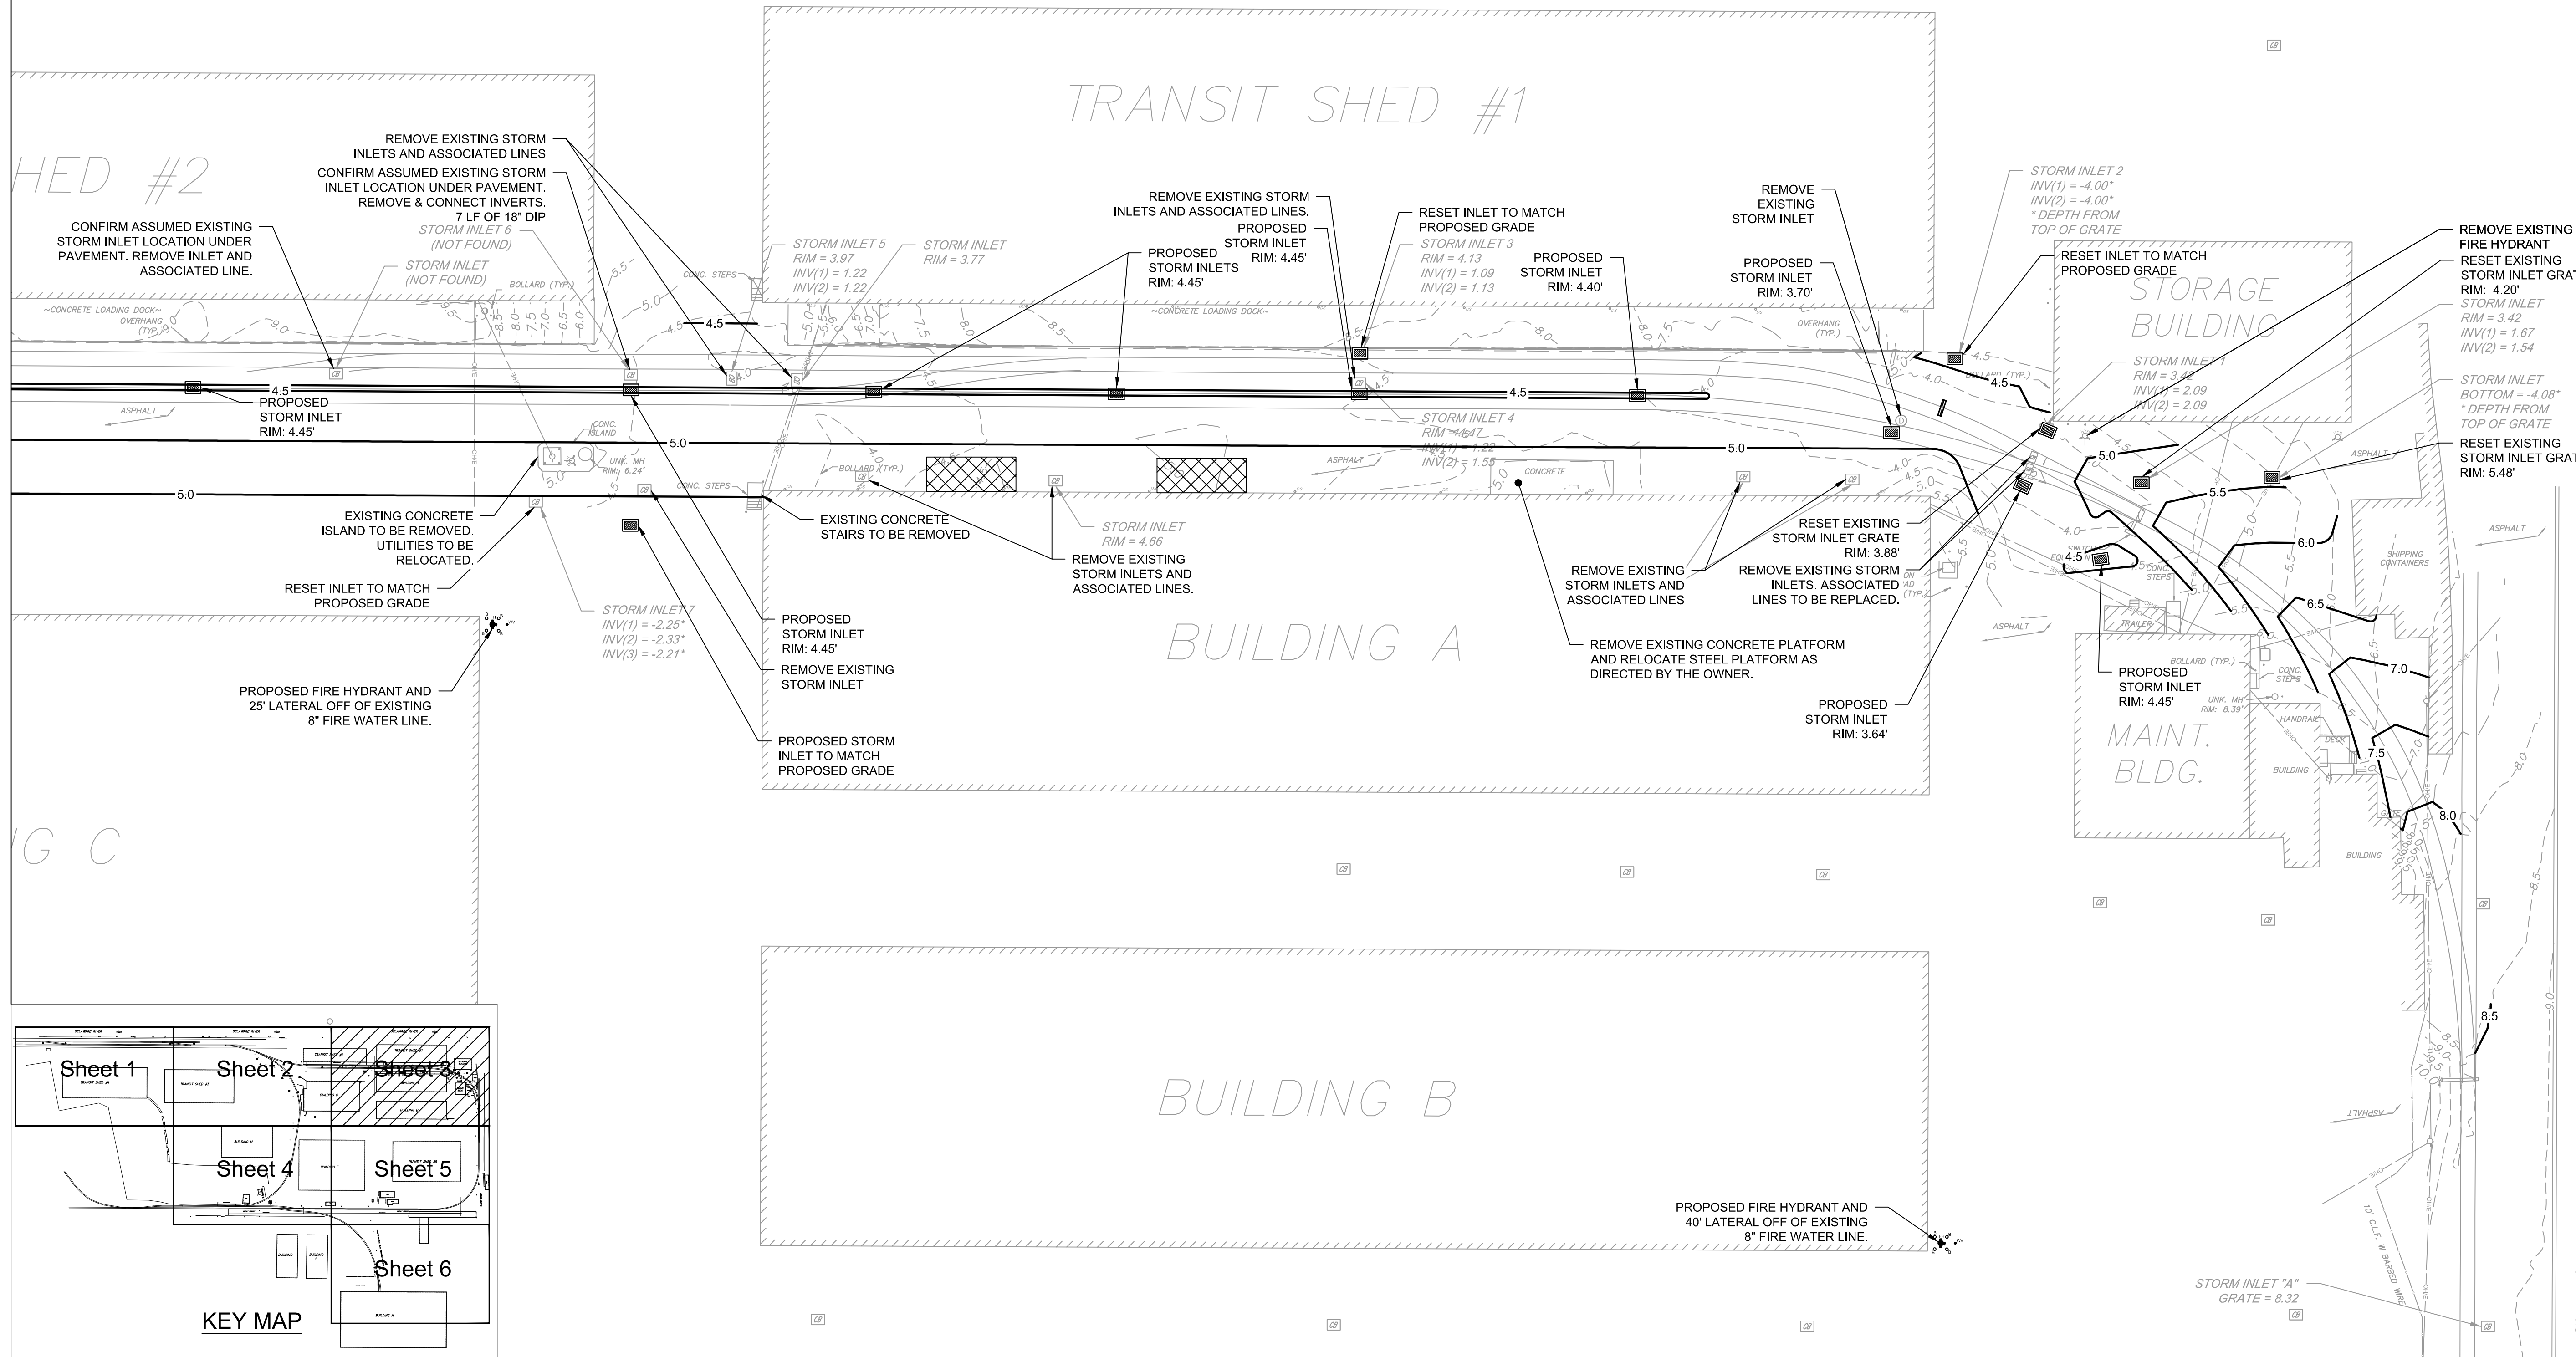

MATCH LINE

MATCH LINE

SHEET 5

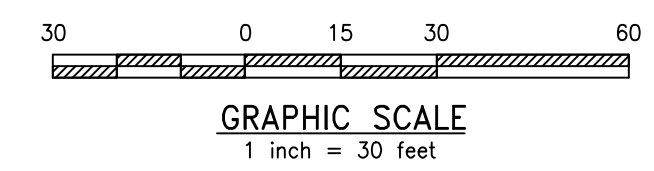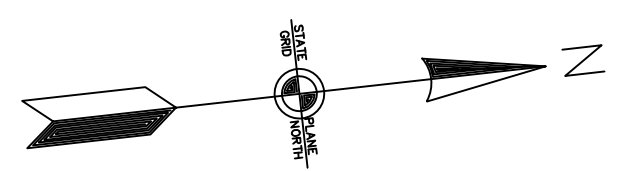

REV	BY	DATE	DESCRIPTION



ISSUED FOR BID

URBAN ENGINEERS, INC.
 530 Walnut Street
 Philadelphia, PA 19106
 (215) 922-8080 Fax (215) 922-8082

LOCATION: **CAMDEN, NJ**

TITLE: **SJPC BALZANO MARINE TERMINAL RAIL INFRASTRUCTURE REHABILITATION PROPOSED GRADING 3**

DWN: GJB PROJ # 2021500064.000 DRAWING NUMBER: **C-303**

CHK: MJT DATE: 06/24/2022

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MATCH LINE

SHEET 2




SHEET 5

BUILDING M


STORM INLET 10
(NO RIM ELEVATION)
INV(1) = -5.21'
INV(2) = -5.54'
* DEPTH FROM TOP OF GRATE

BUILDING

MATCH LINE

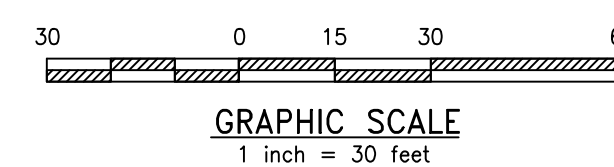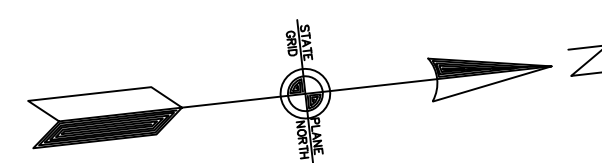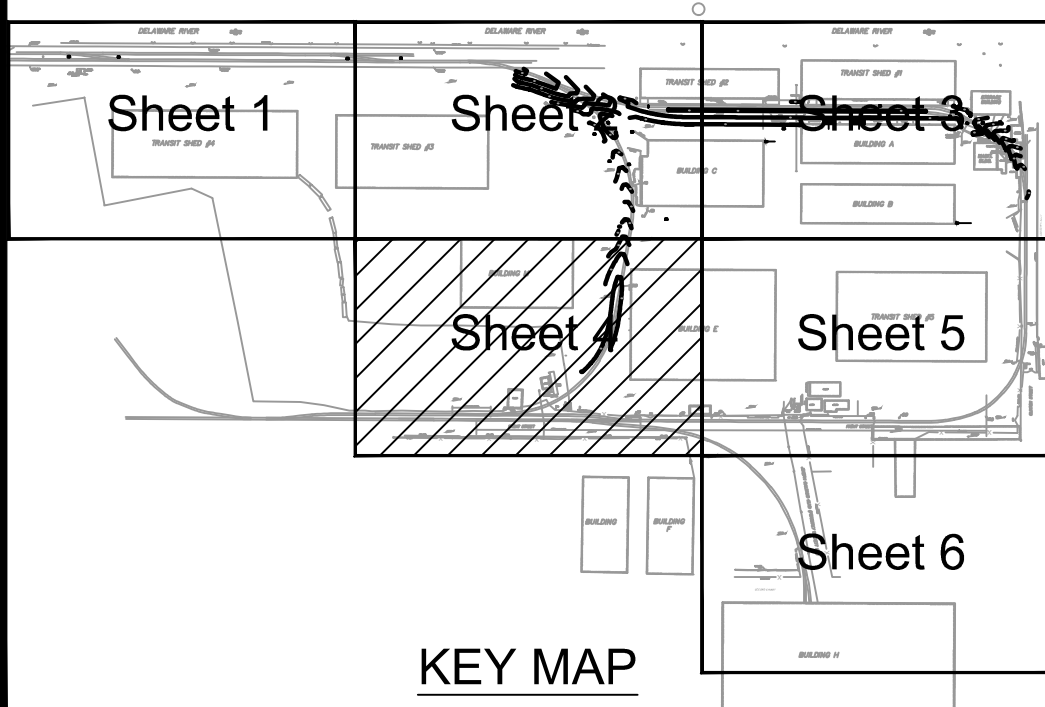

REV	BY	DATE	DESCRIPTION

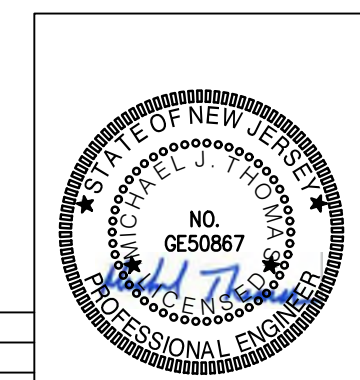


URBAN ENGINEERS, INC.
530 Walnut Street
Philadelphia, PA 19106
(215) 922-8080 Fax (215) 922-8082

LOCATION: CAMDEN, NJ

TITLE: SJPC BALZANO MARINE TERMINAL RAIL INFRASTRUCTURE REHABILITATION PROPOSED GRADING 4



DWN: GJB PROJ # 2021500064.000 DRAWING NUMBER: C-304
CHK: MJT DATE: 06/24/2022

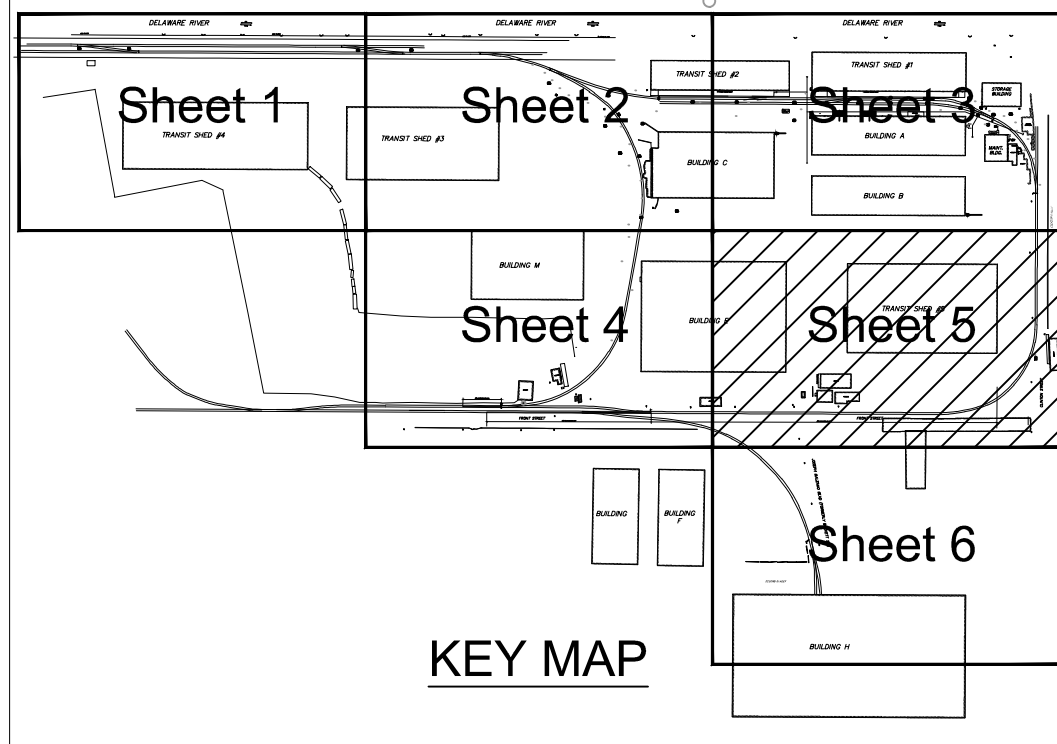

SHEET 4



VG E

MATCH LINE

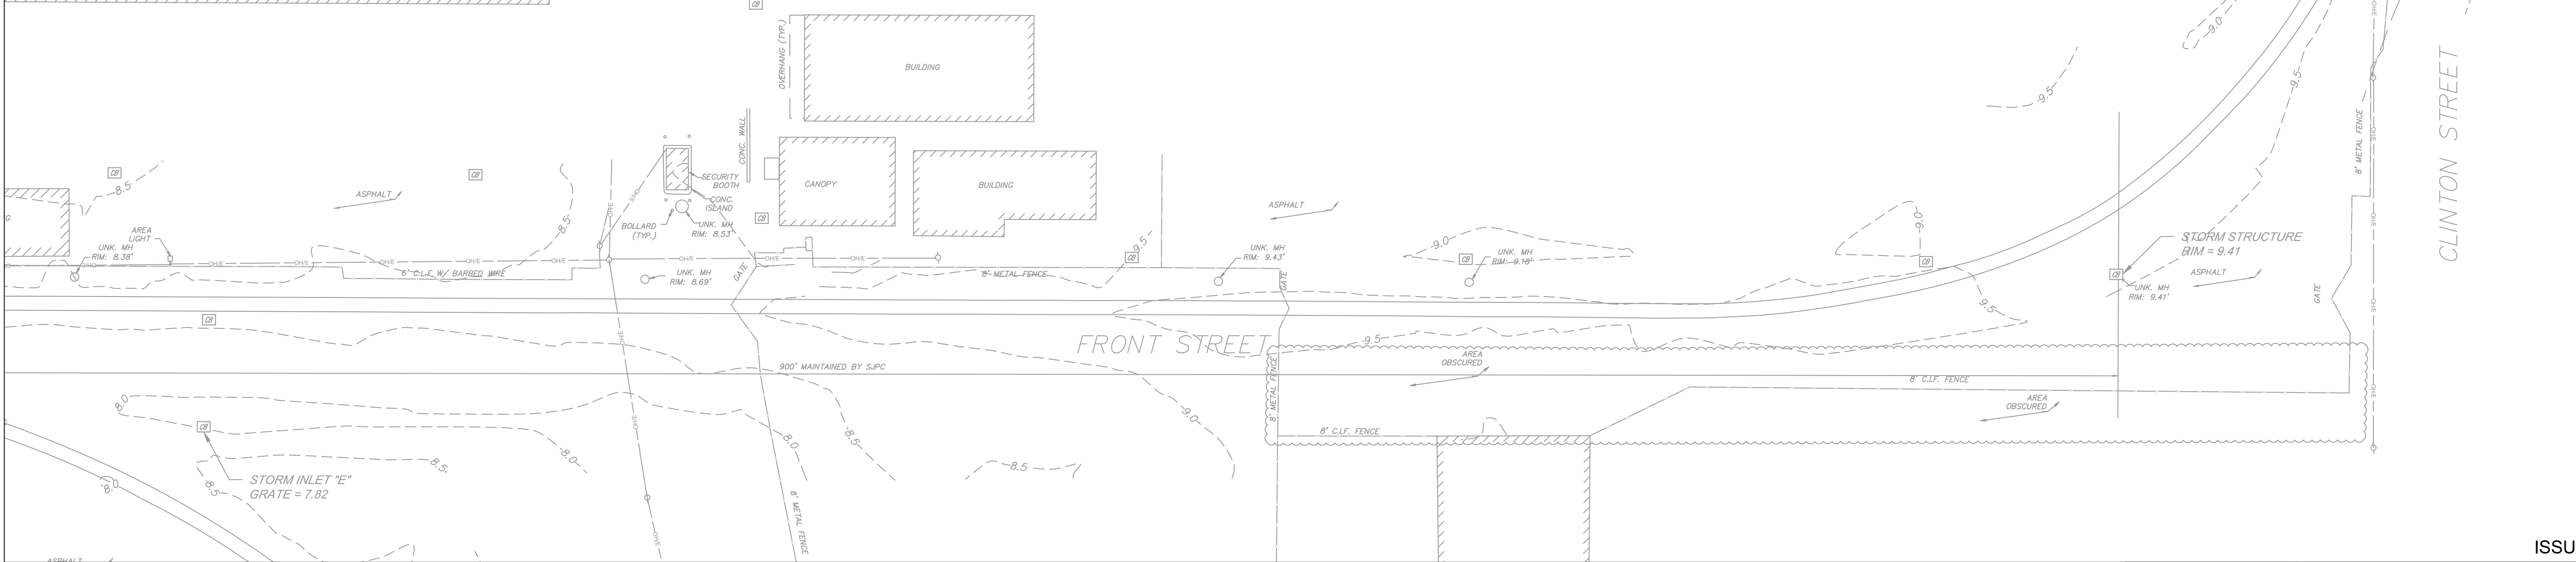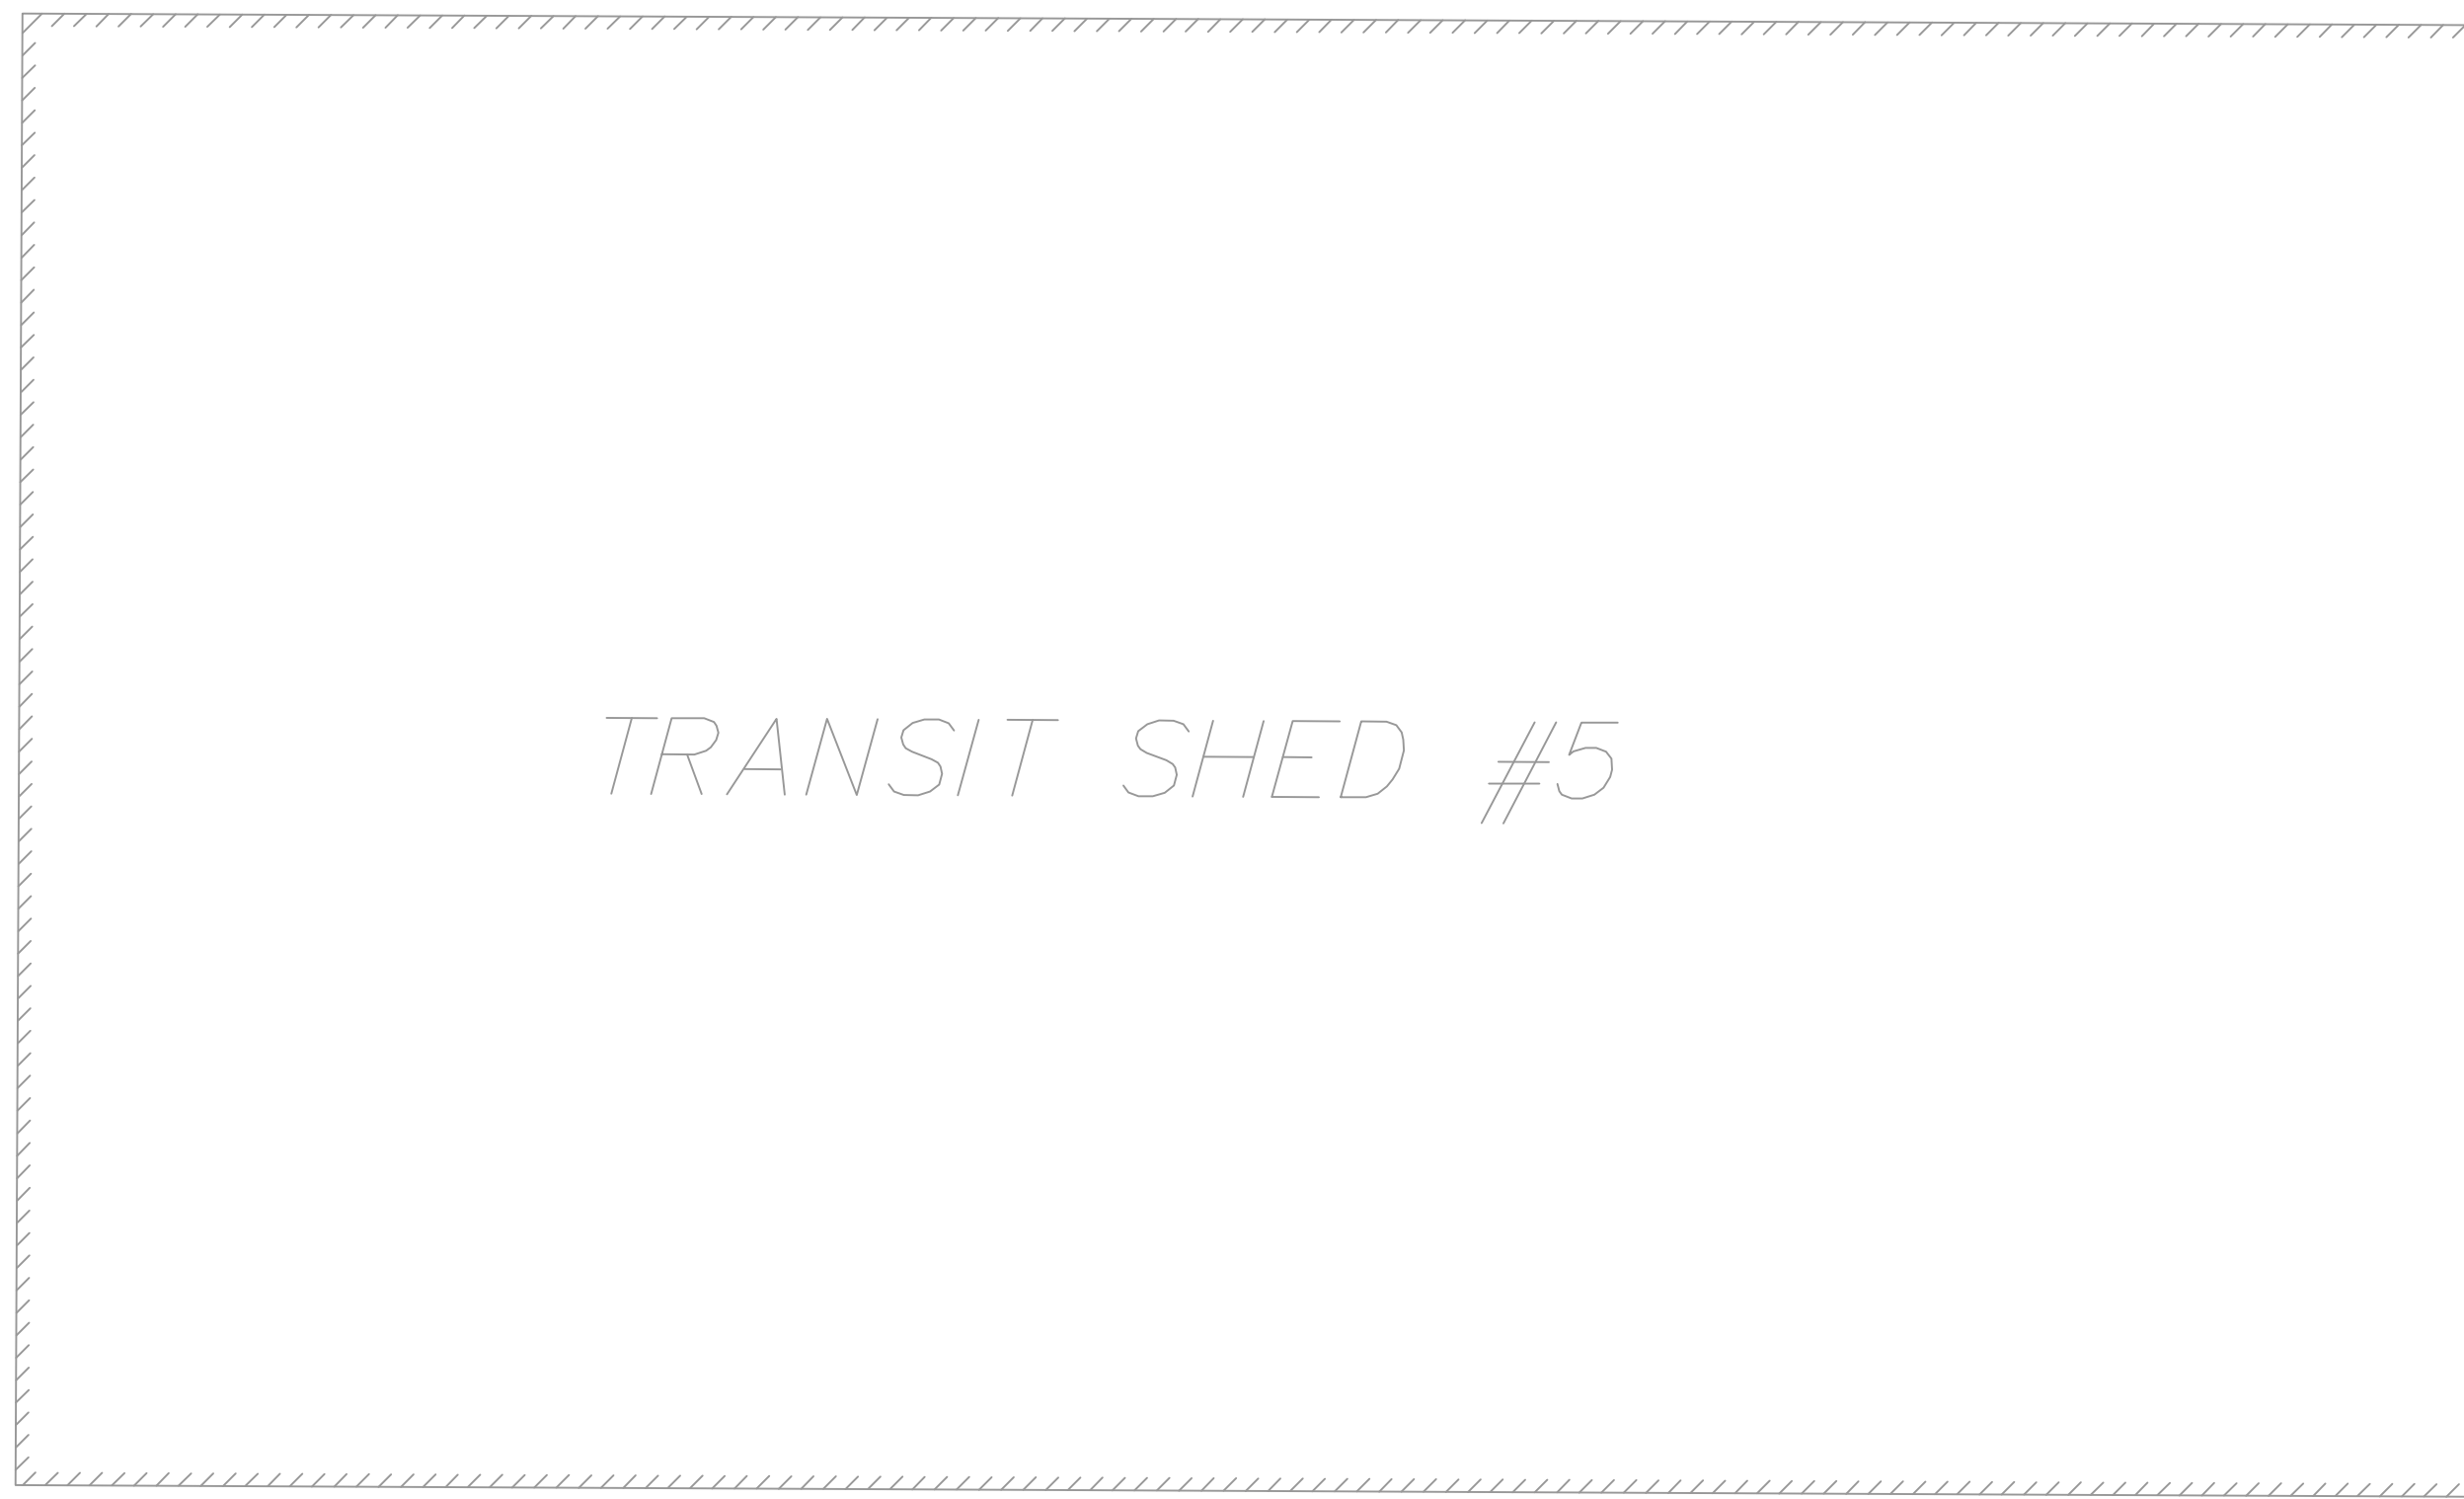


MATCH LINE

SHEET 6

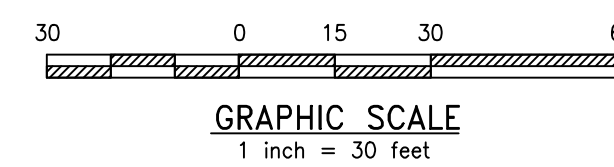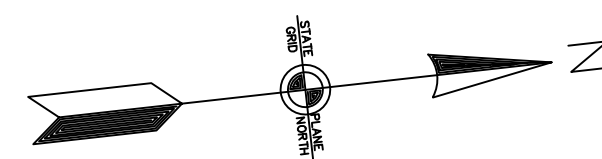

REV	BY	DATE	DESCRIPTION

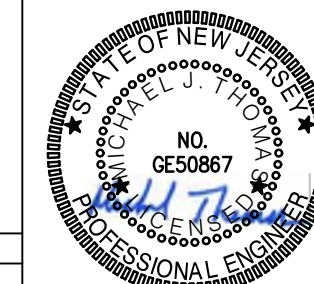

ISSUED FOR BID


URBAN ENGINEERS, INC.
 530 Walnut Street
 Philadelphia, PA 19106
 (215) 922-8080 Fax (215) 922-8082

LOCATION: **CAMDEN, NJ**


TITLE: **SJPC BALZANO MARINE TERMINAL RAIL INFRASTRUCTURE REHABILITATION PROPOSED GRADING 5**

DWN: GJB PROJ # 2021500064.000 DRAWING NUMBER: **C-305**
 CHR: MJT DATE 06/24/2022



MATCH LINE

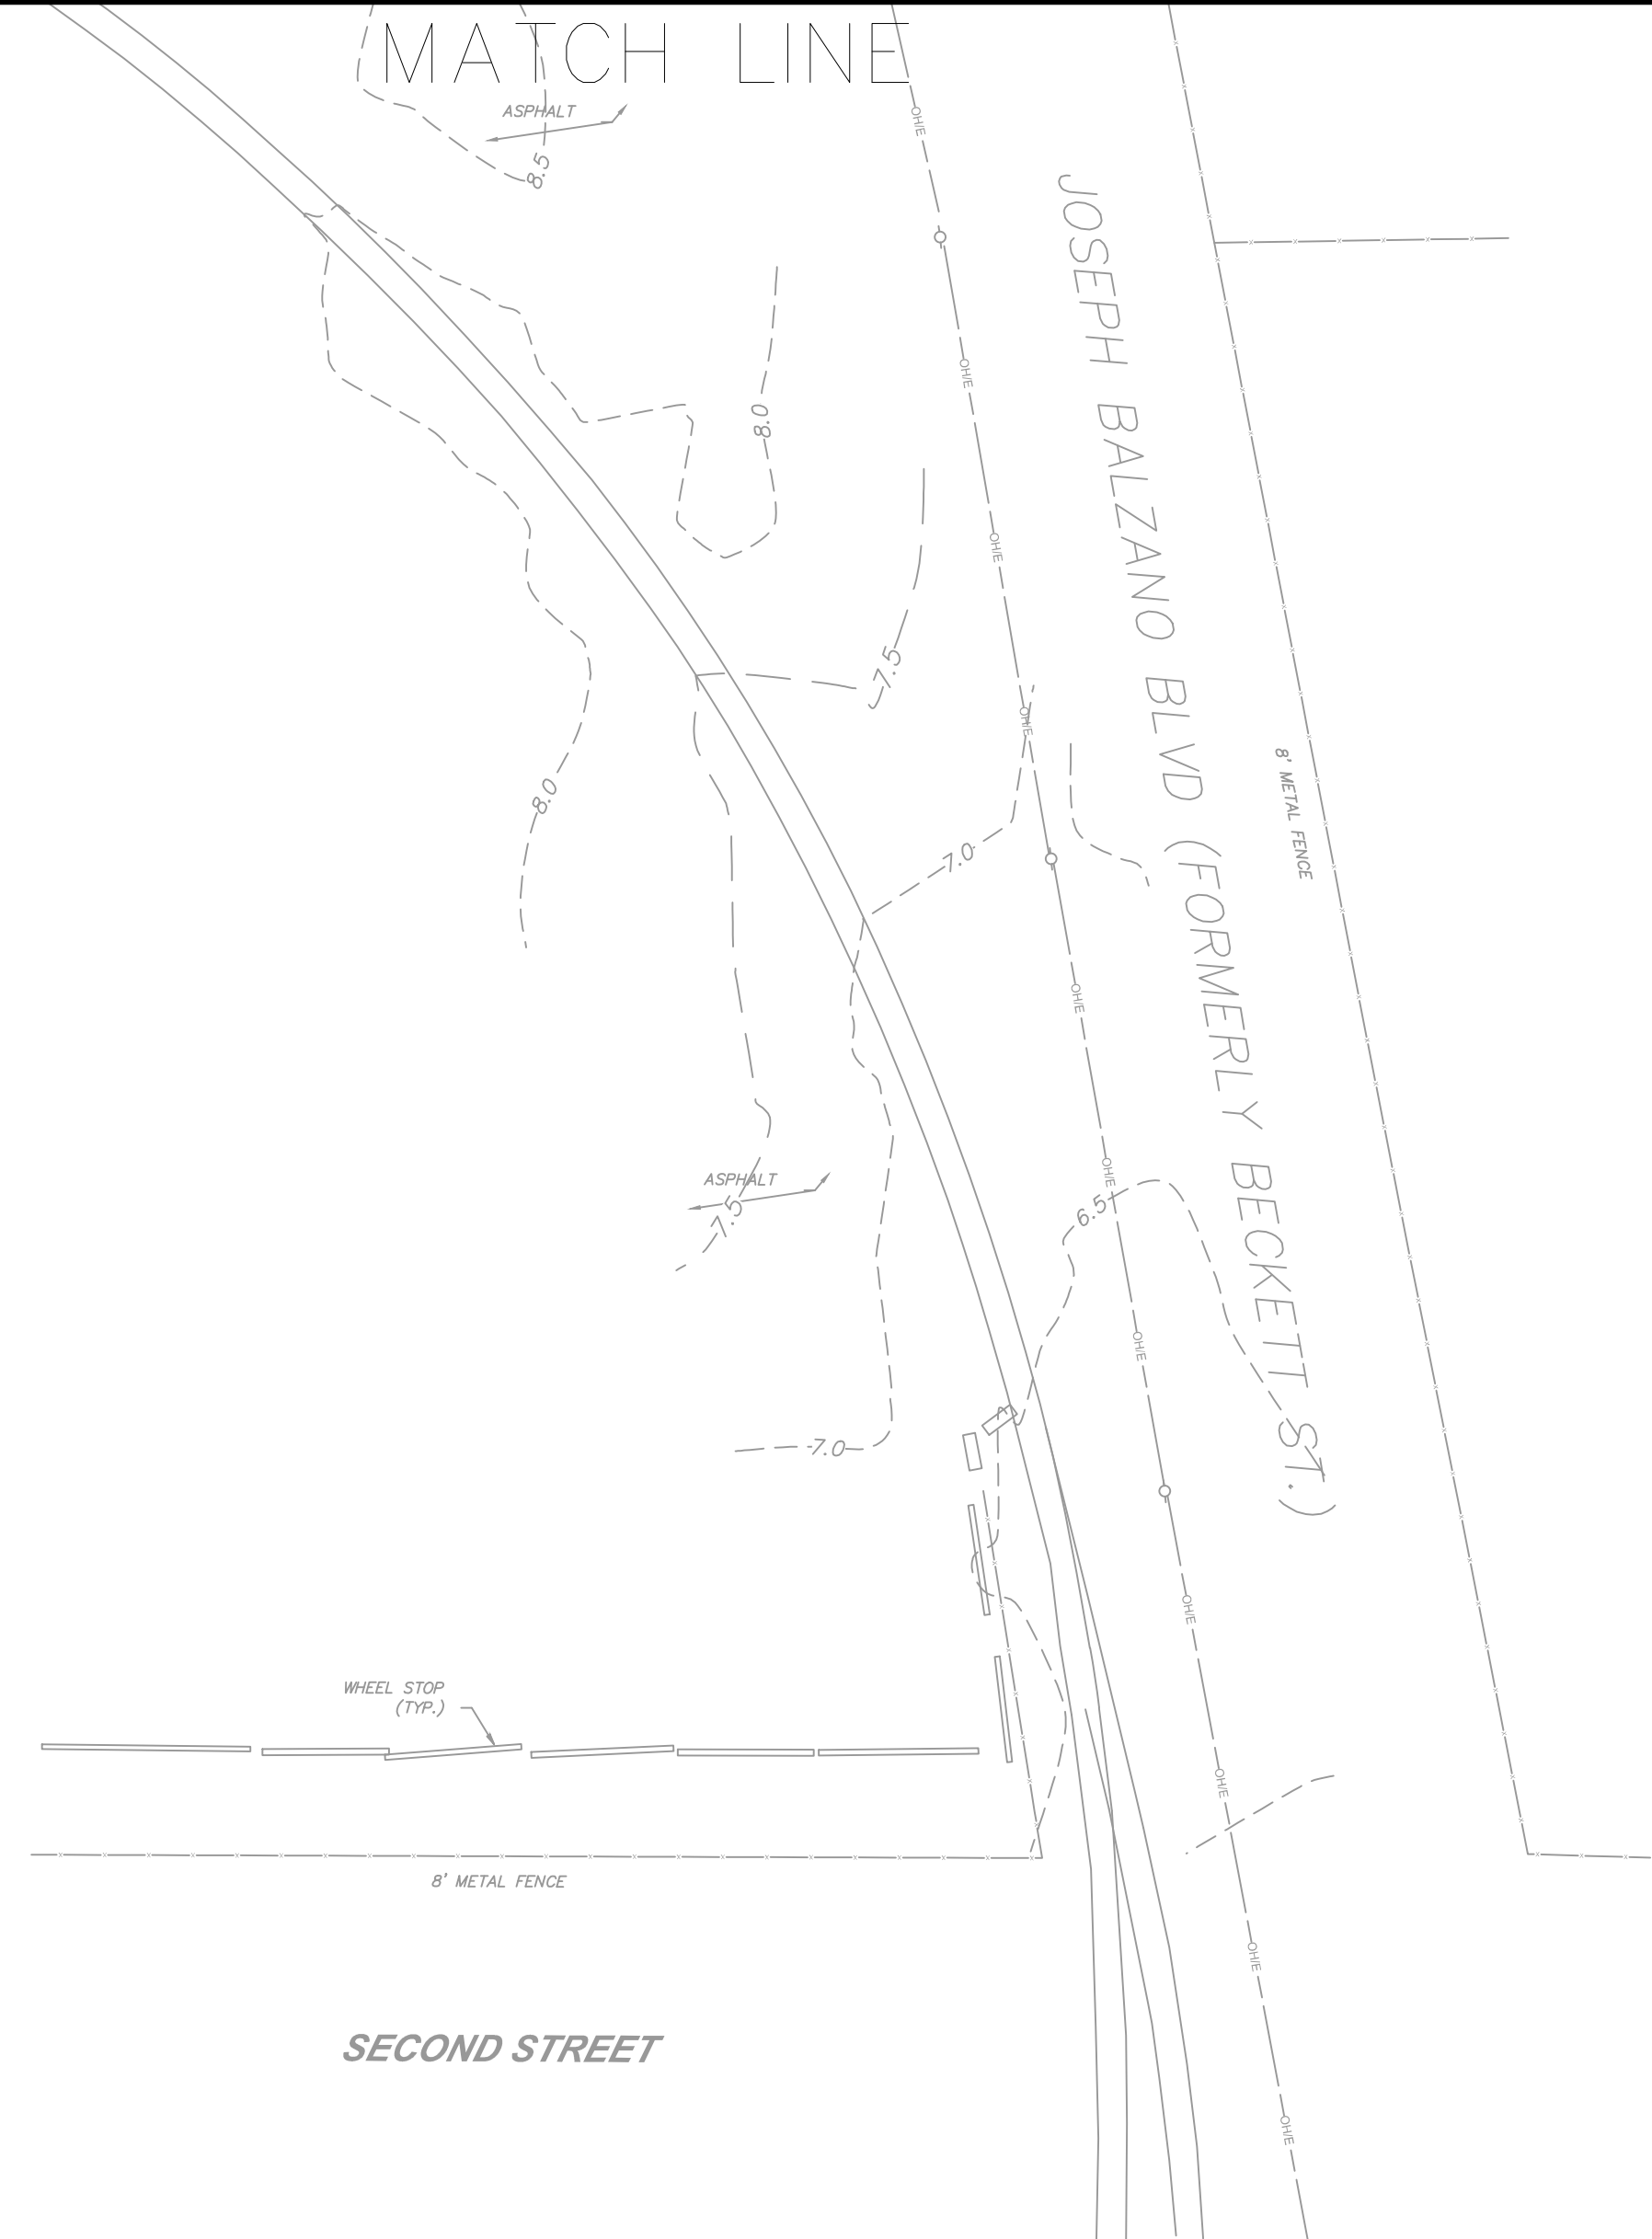

BUILDING H

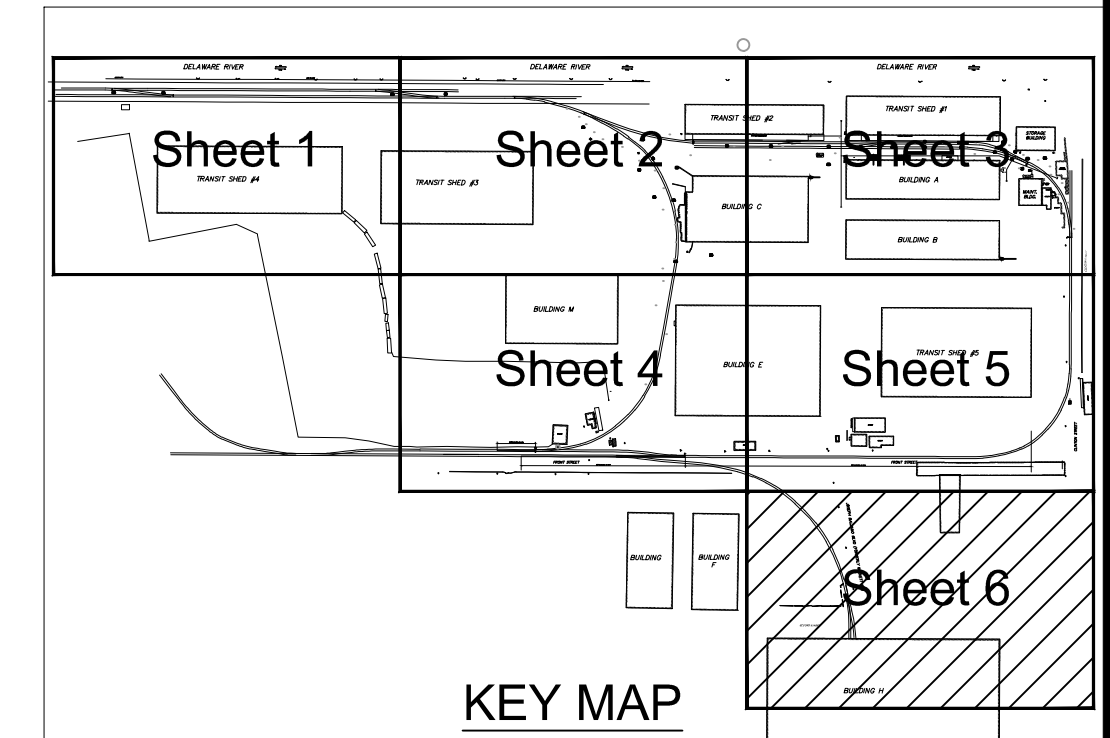

KEY MAP
ISSUED FOR BID

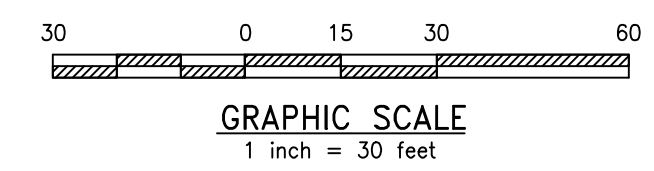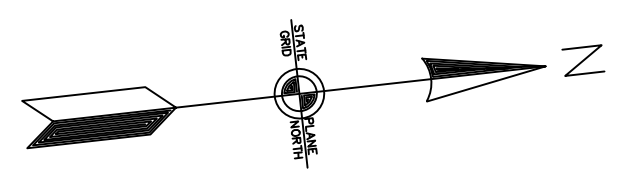

REV	BY	DATE	DESCRIPTION




URBAN ENGINEERS, INC.
 530 Walnut Street
 Philadelphia, PA 19106
 (215) 922-8080 Fax (215) 922-8082

LOCATION: CAMDEN, NJ

TITLE: SJPC BALZANO MARINE TERMINAL RAIL INFRASTRUCTURE REHABILITATION PROPOSED GRADING 6

DWN: GJB PROJ # 2021500064.000 DRAWING NUMBER: C-306
 CHR: MJT DATE 06/24/2022




DELAWARE RIVER

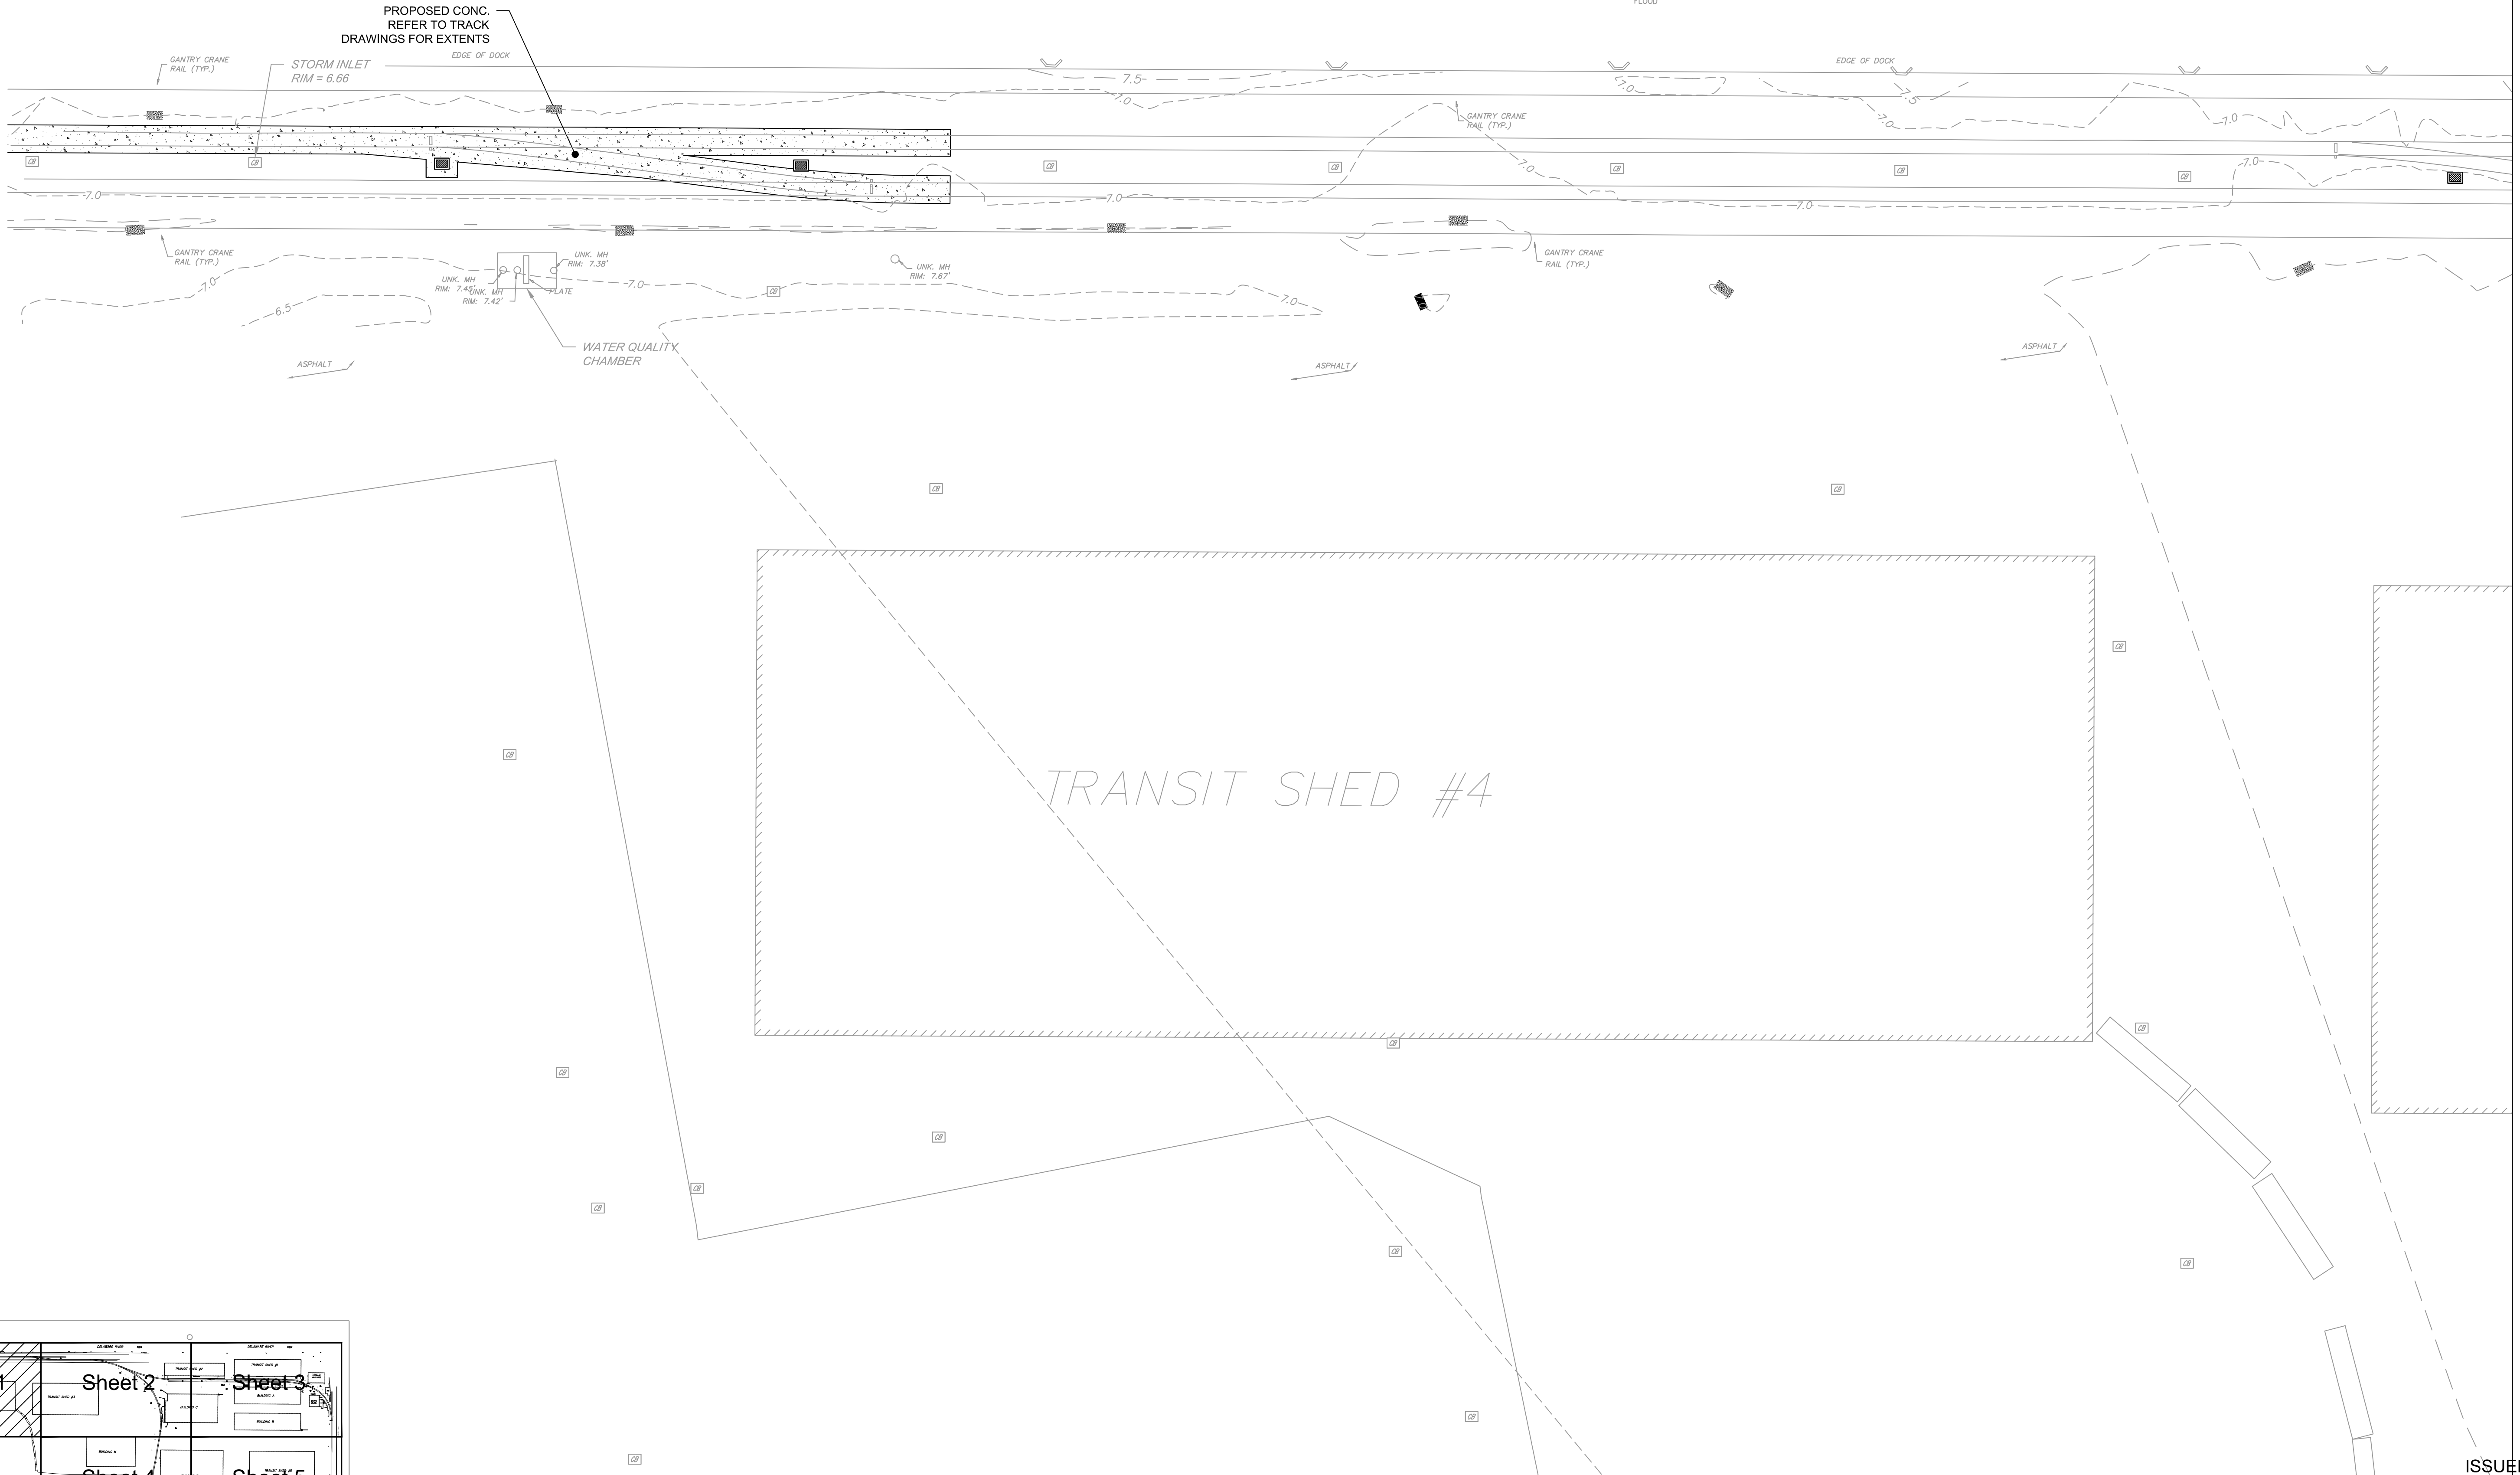


SHEET 2

MATCH LINE

ISSUED FOR BID

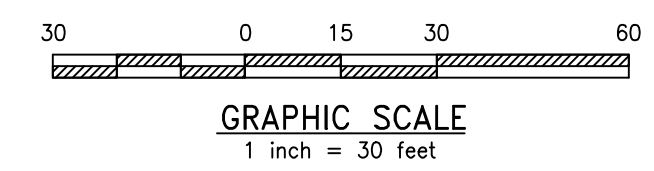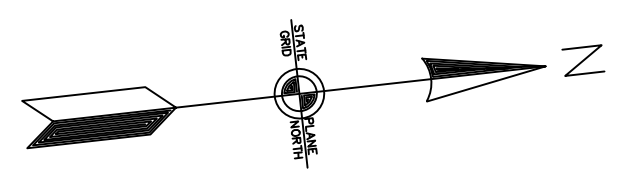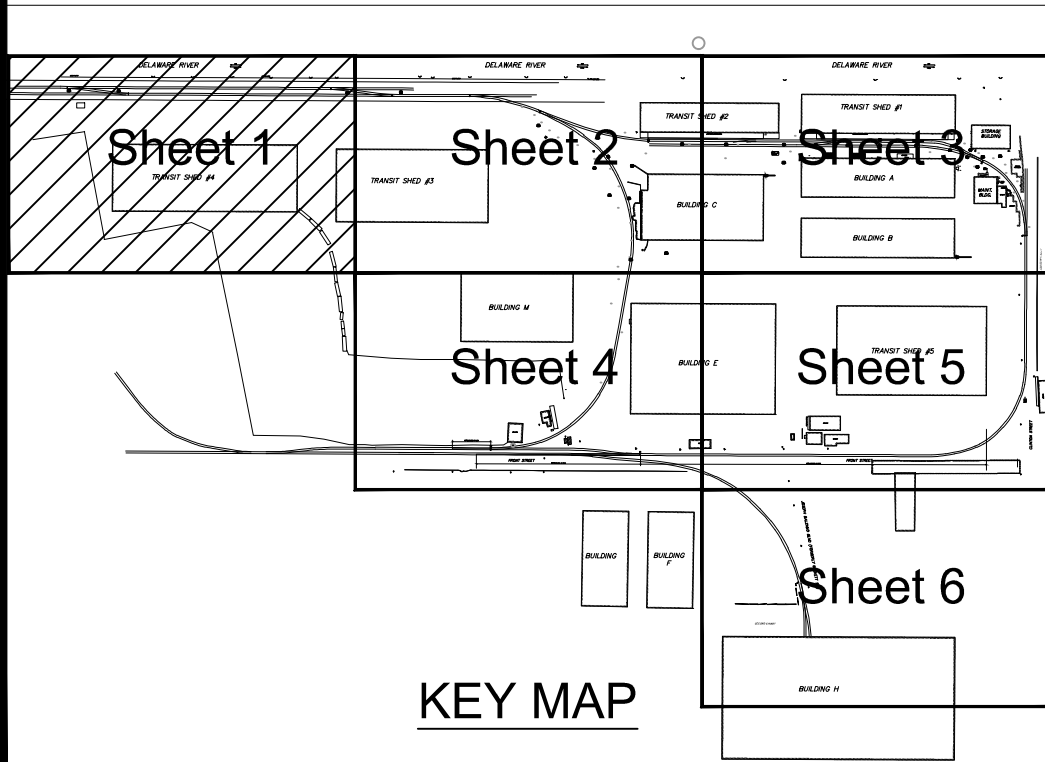

REV	BY	DATE	DESCRIPTION

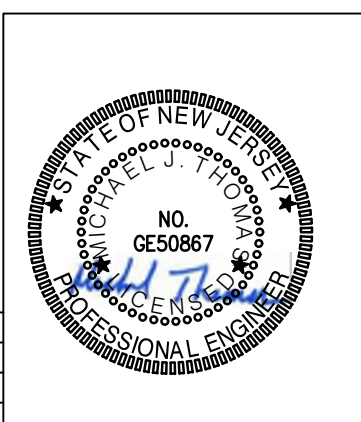


URBAN ENGINEERS, INC.
530 Walnut Street
Philadelphia, PA 19106
(215) 922-8080 Fax (215) 922-8082

LOCATION: CAMDEN, NJ

TITLE: SJPC BALZANO MARINE TERMINAL RAIL INFRASTRUCTURE REHABILITATION PROPOSED MATERIALS 1

DWN: GJB PROJ #: 2021500064.000 DRAWING NUMBER: C-401
CHK: MJT DATE: 06/24/2022

DELAWARE RIVER


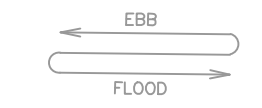


SHEET 1

SHEET 3



MATCH LINE

MATCH LINE

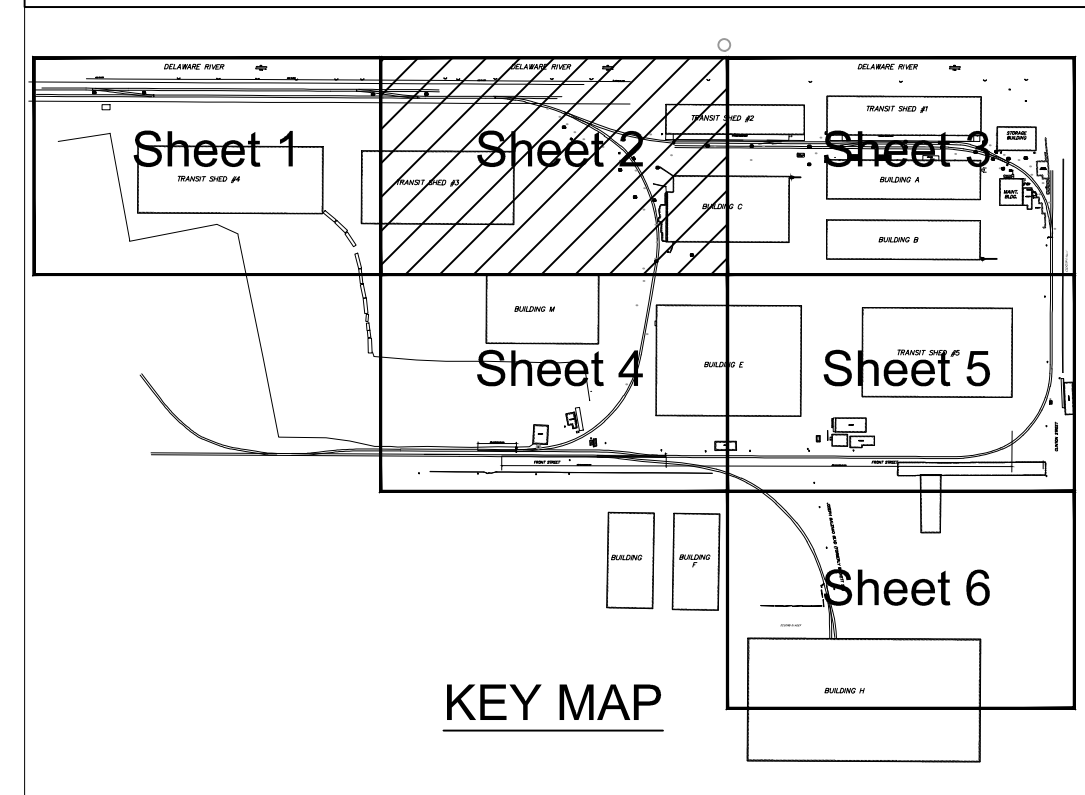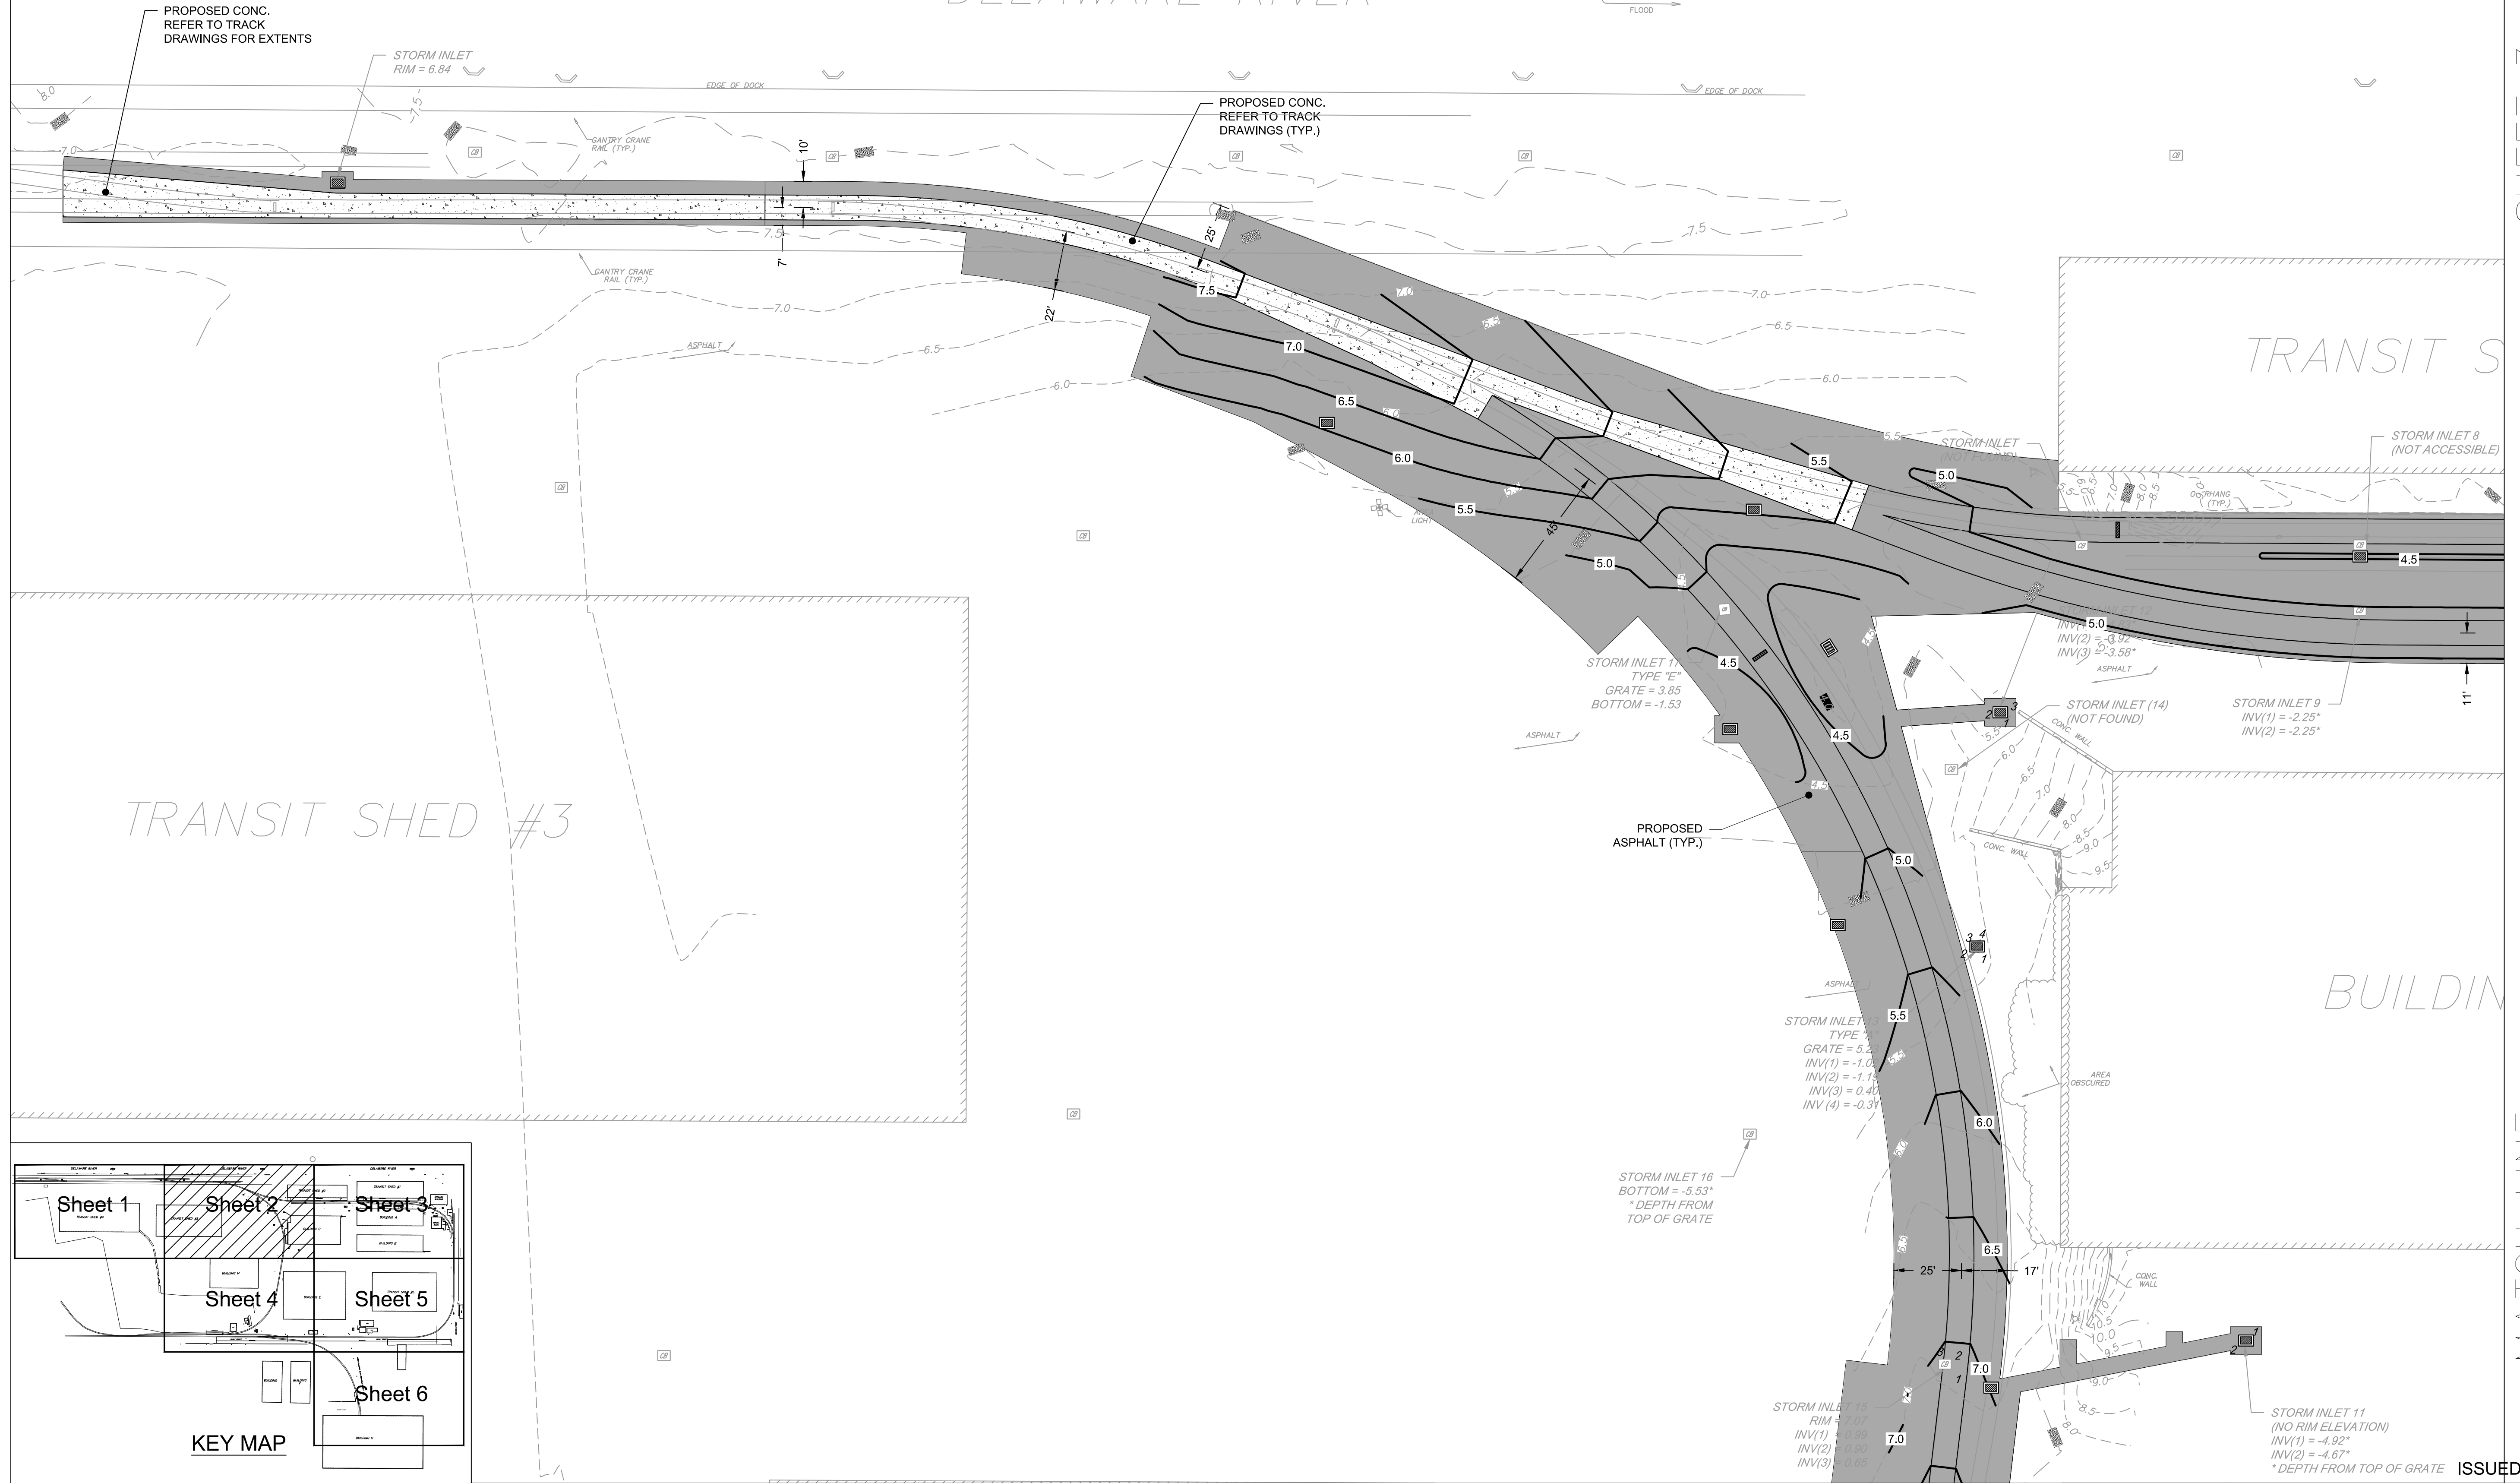

MATCH LINE

SHEET 4

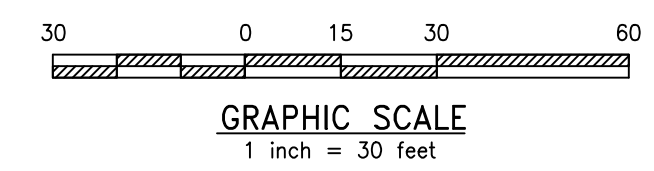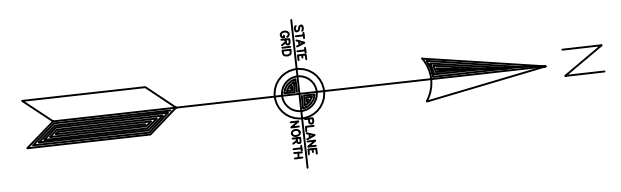

REV	BY	DATE	DESCRIPTION



ISSUED FOR BID

URBAN ENGINEERS, INC.
530 Walnut Street
Philadelphia, PA 19106
(215) 922-8080 Fax (215) 922-8082

LOCATION: **CAMDEN, NJ**

TITLE: **SJPC BALZANO MARINE TERMINAL RAIL INFRASTRUCTURE REHABILITATION PROPOSED MATERIALS 2**


DWN: GJB PROJ # 2021500064.000 DRAWING NUMBER: **C-402**
CHK: MJT DATE: 06/24/2022

X:\2021\000064.000 - SJPC Balzano Rail Rehab\Technical\CD\DWG\Sheets\SHIT-C400-MATERIALS.dwg


DELAWARE RIVER



SHEET 2


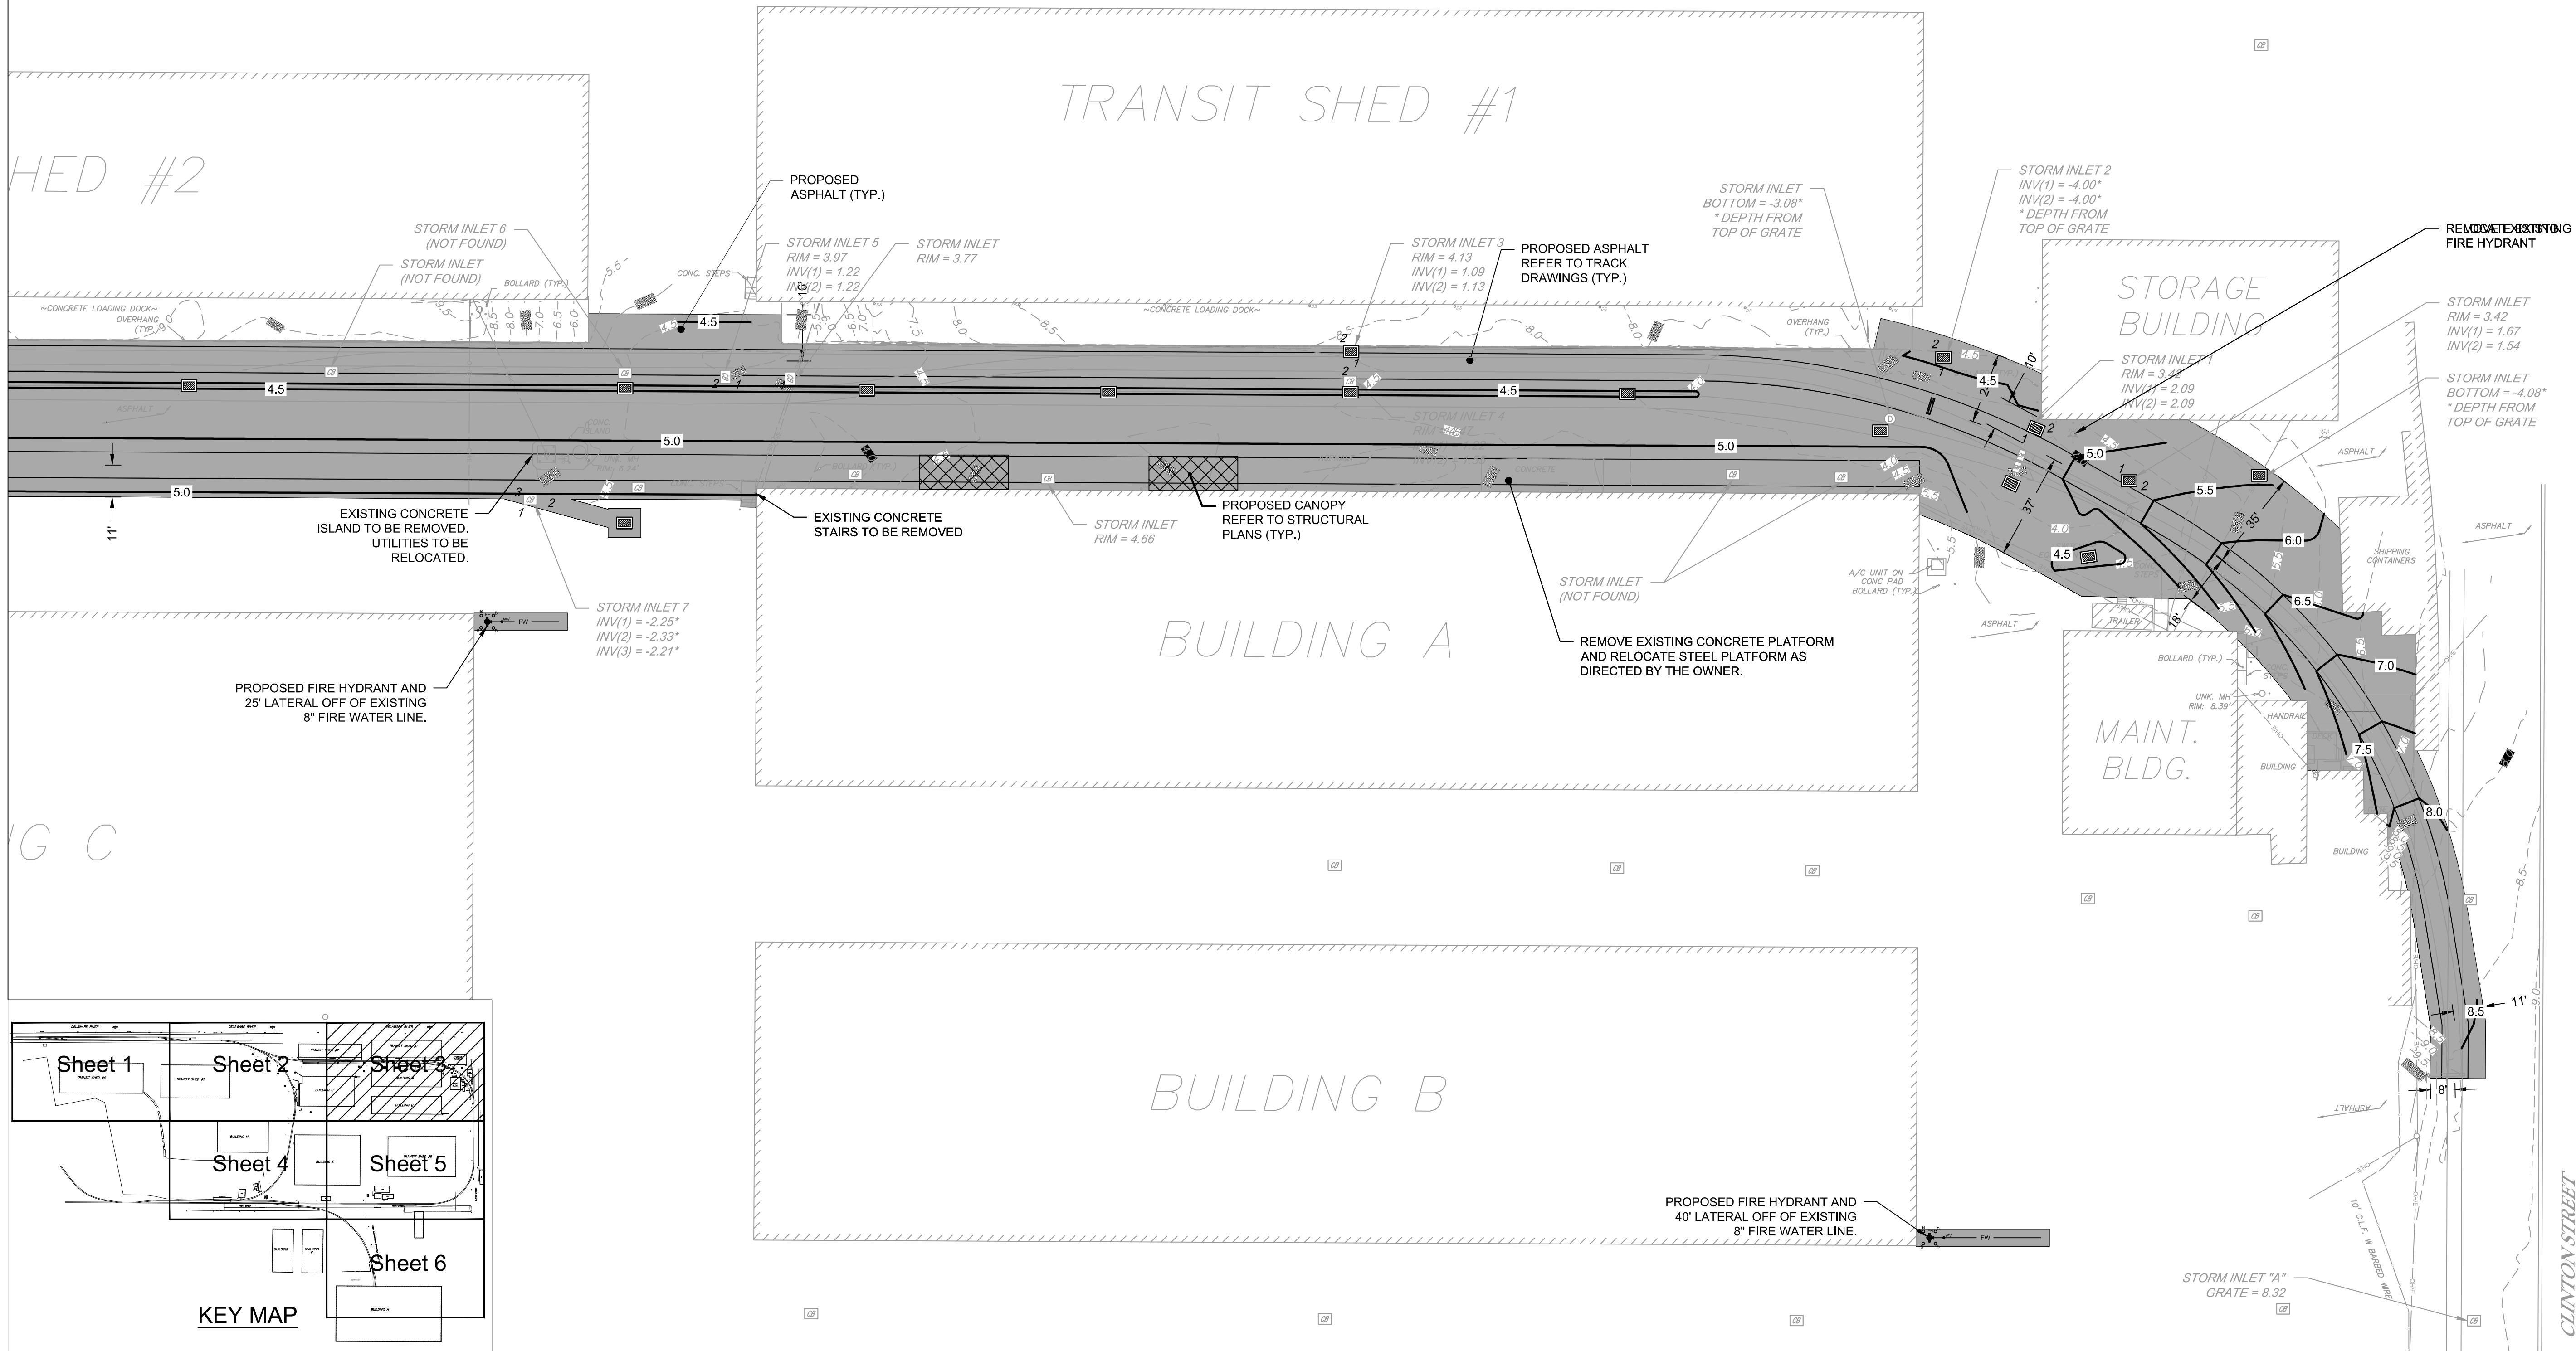


MATCH LINE

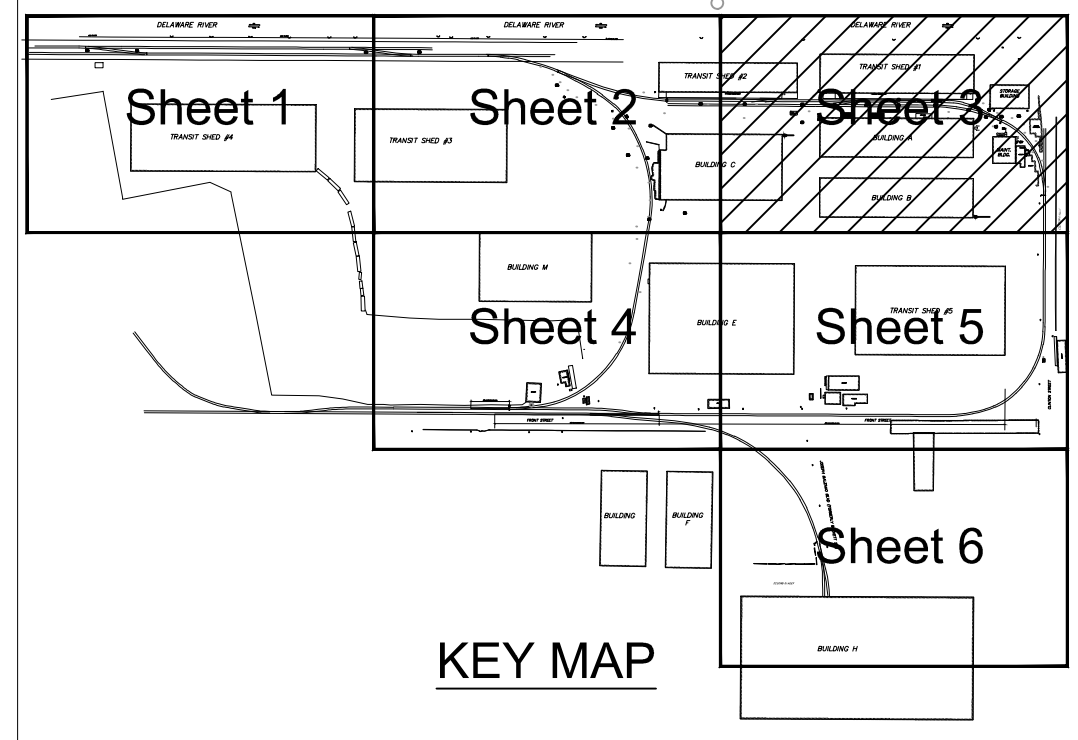

MATCH LINE

SHEET 5

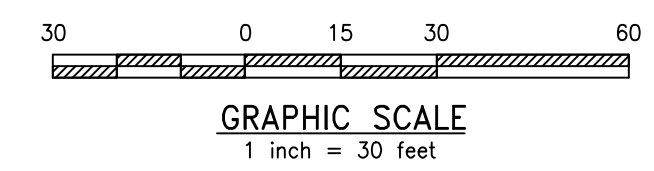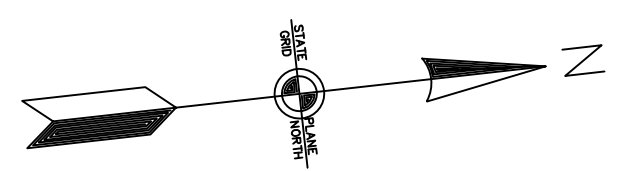

REV	BY	DATE	DESCRIPTION



ISSUED FOR BID

URBAN ENGINEERS, INC.
 530 Walnut Street
 Philadelphia, PA 19106
 (215) 922-8080 Fax (215) 922-8082

LOCATION: CAMDEN, NJ

TITLE: SJPC BALZANO MARINE TERMINAL RAIL INFRASTRUCTURE REHABILITATION PROPOSED MATERIALS 3

DWN: GJB PROJ # 2021500064.000 DRAWING NUMBER: C-403

CHK: MJT DATE: 06/24/2022

MATCH LINE

SHEET 2

SHEET 5

BUILDING M



BUILDING

STORM INLET 10
(NO RIM ELEVATION)
INV(1) = -5.21'
INV(2) = -5.54'
* DEPTH FROM TOP OF GRATE




PROPOSED ASPHALT
REFER TO TRACK
DRAWINGS (TYP.)

PROPOSED
ASPHALT (TYP.)


UNK. MH
RIM: 8.09'

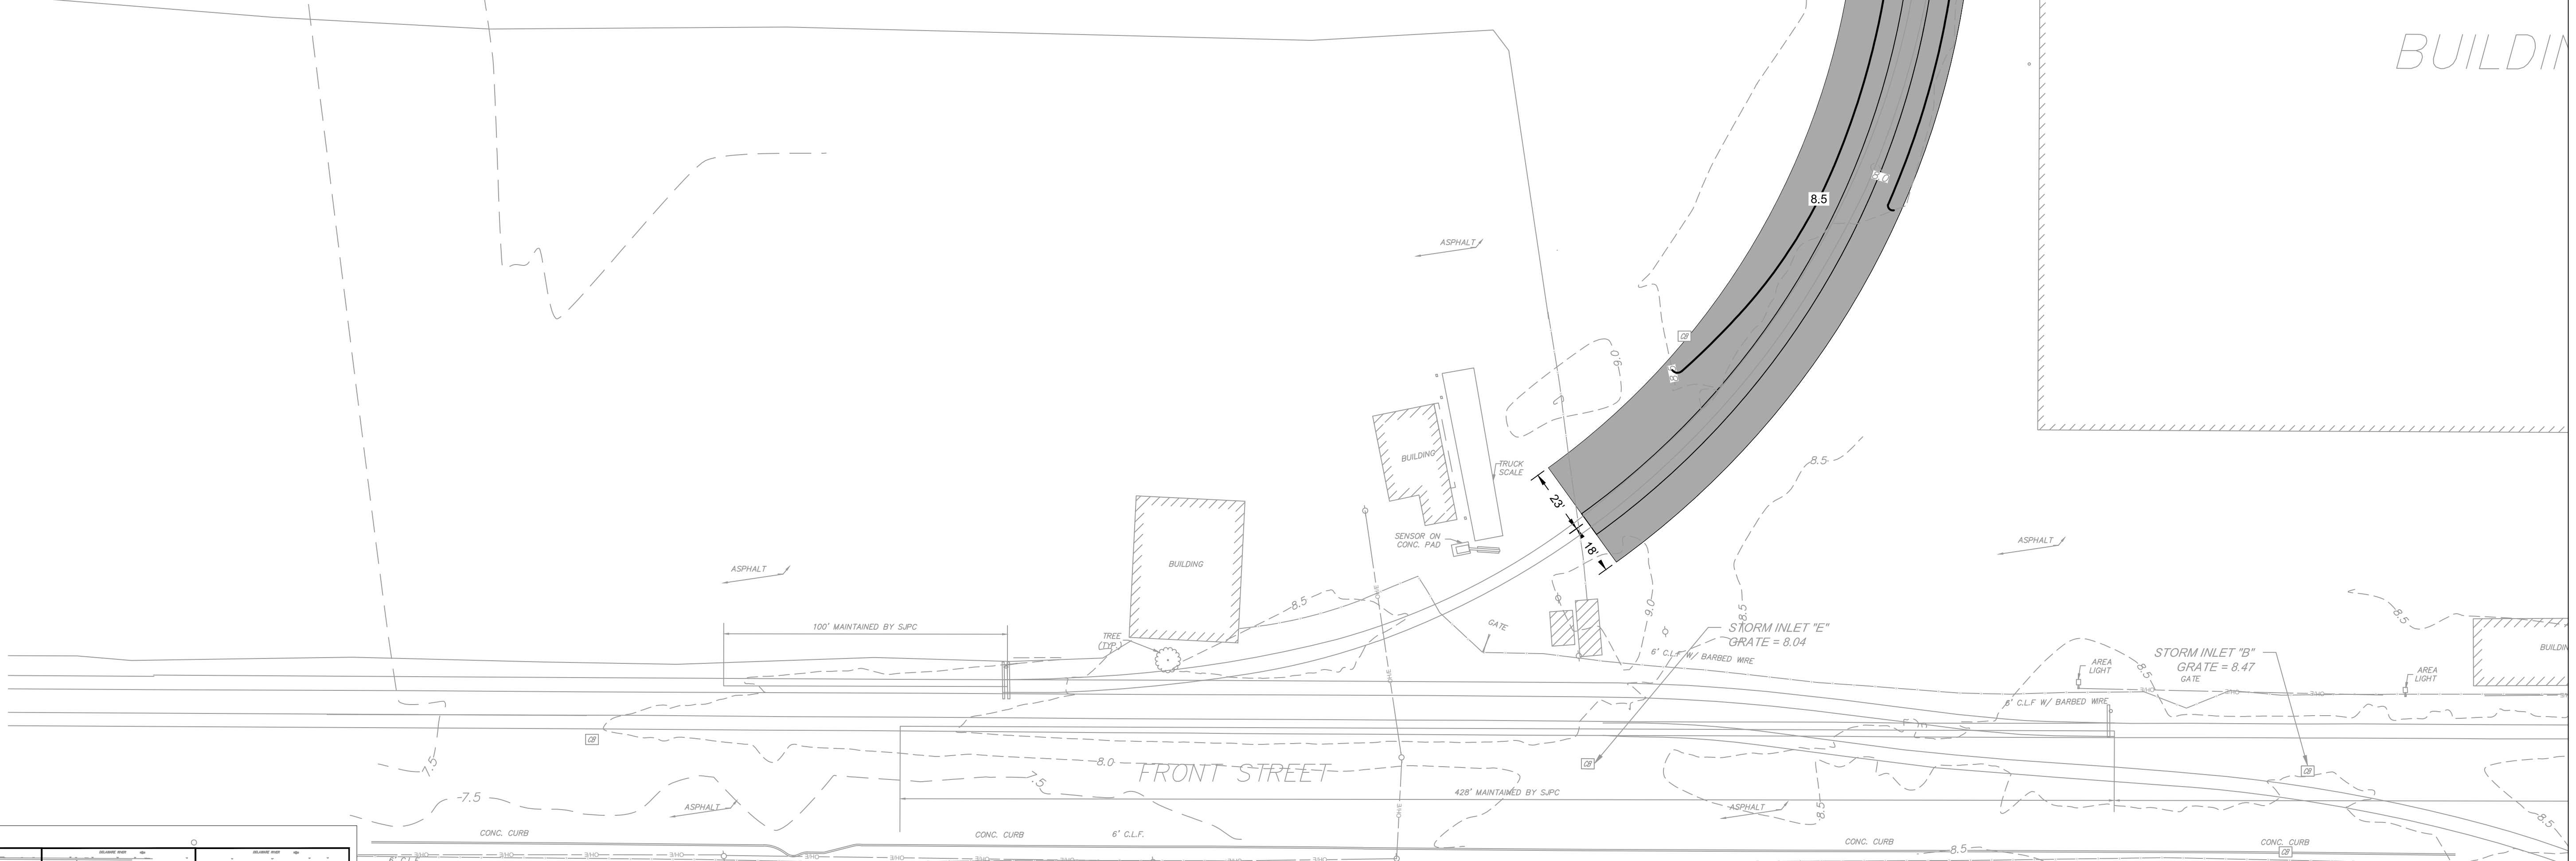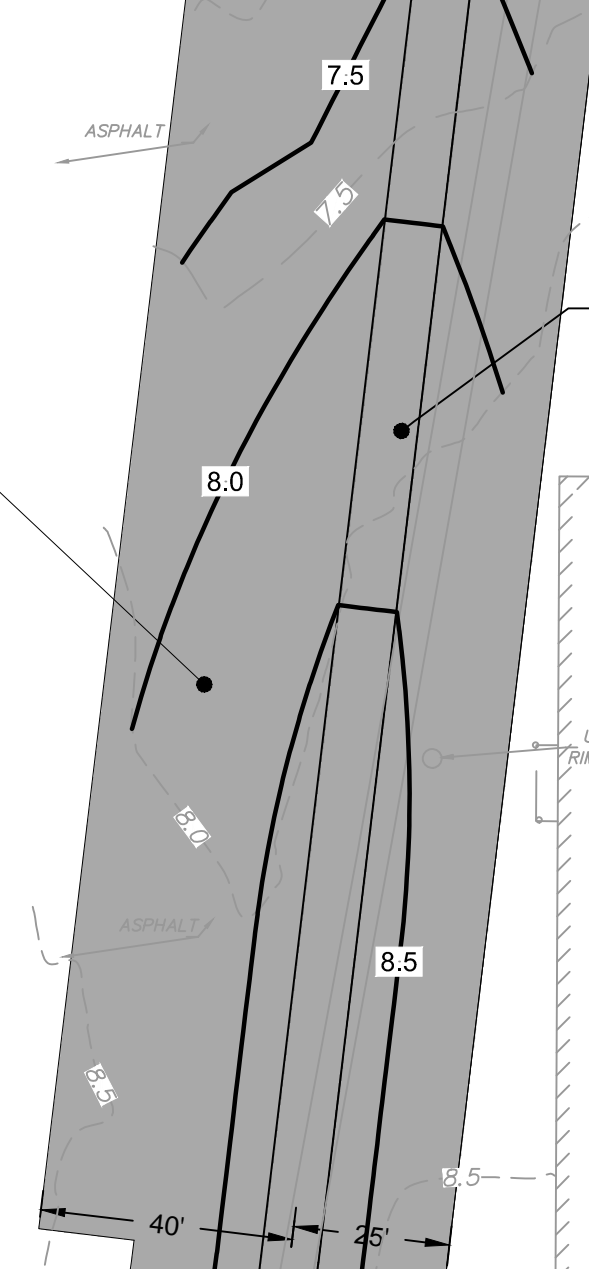

MATCH LINE

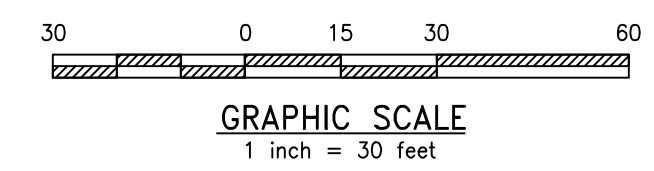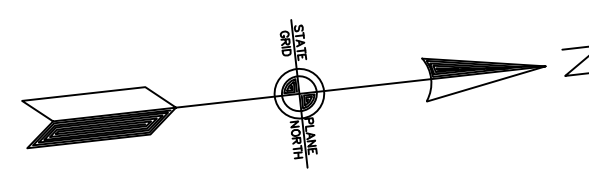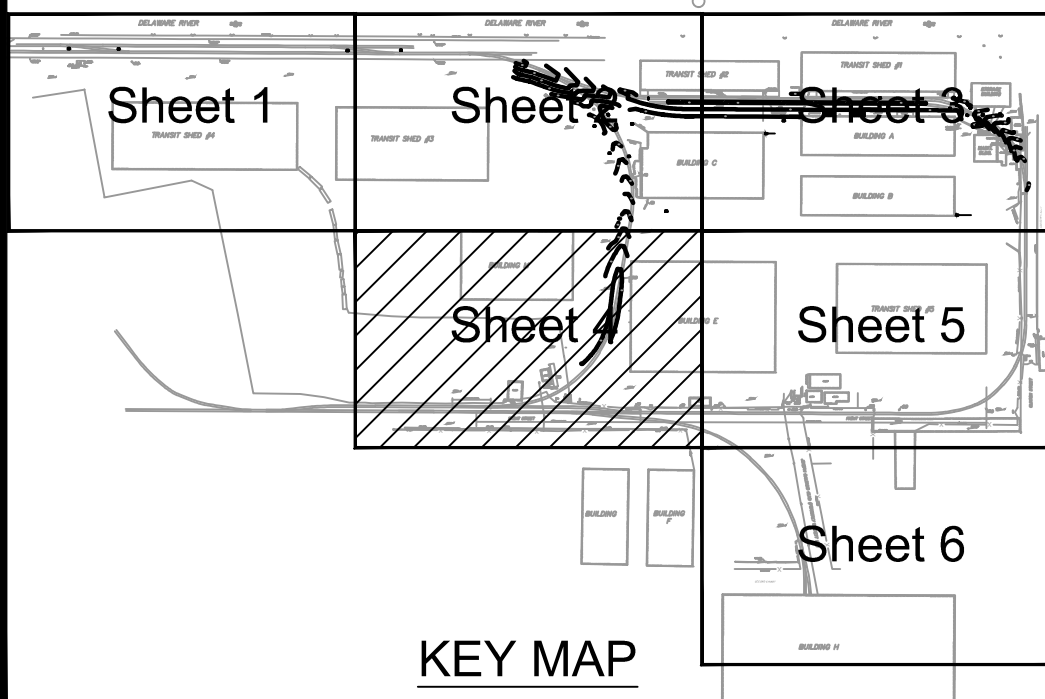

REV	BY	DATE	DESCRIPTION

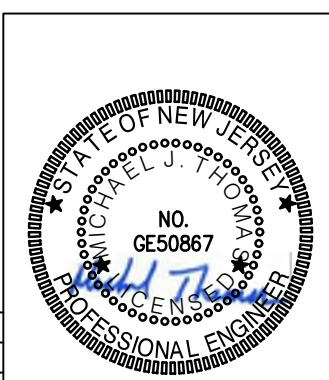


URBAN ENGINEERS, INC.
530 Walnut Street
Philadelphia, PA 19106
(215) 922-8080 Fax (215) 922-8082

LOCATION: CAMDEN, NJ
TITLE: SJPC BALZANO MARINE TERMINAL RAIL
INFRASTRUCTURE REHABILITATION
PROPOSED MATERIALS 4

DWN: GJB PROJ # 2021500064.000 DRAWING NUMBER: C-404
CHK: MJT DATE: 06/24/2022


ISSUED FOR BID

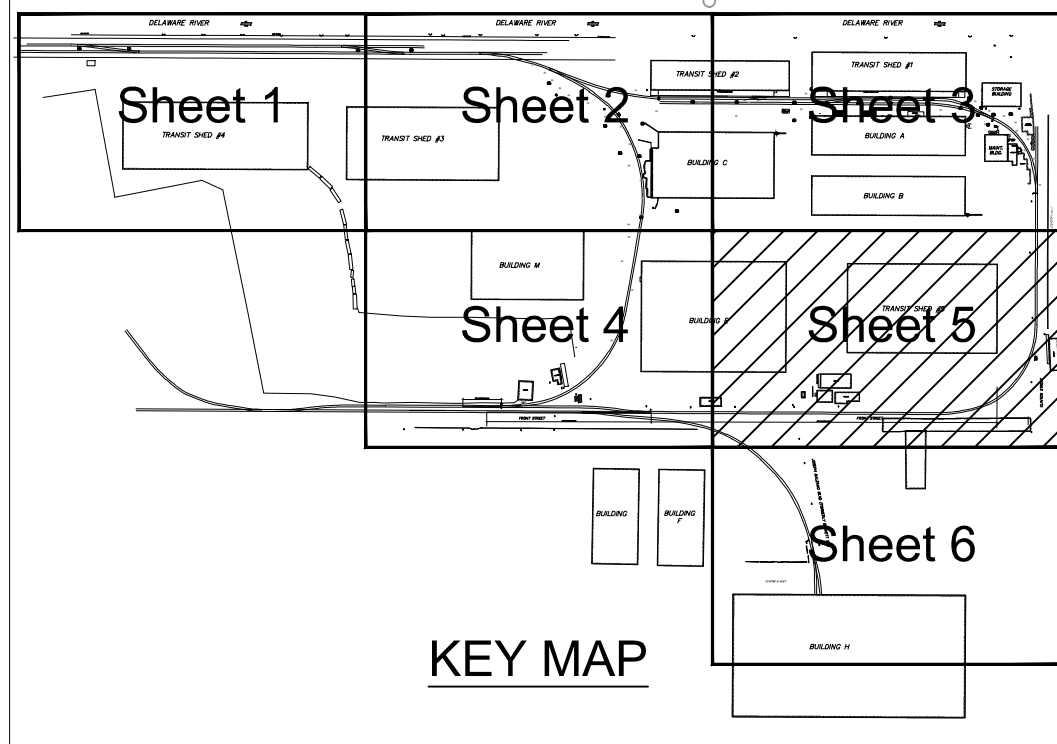


SHEET 4

VG E

MATCH LINE


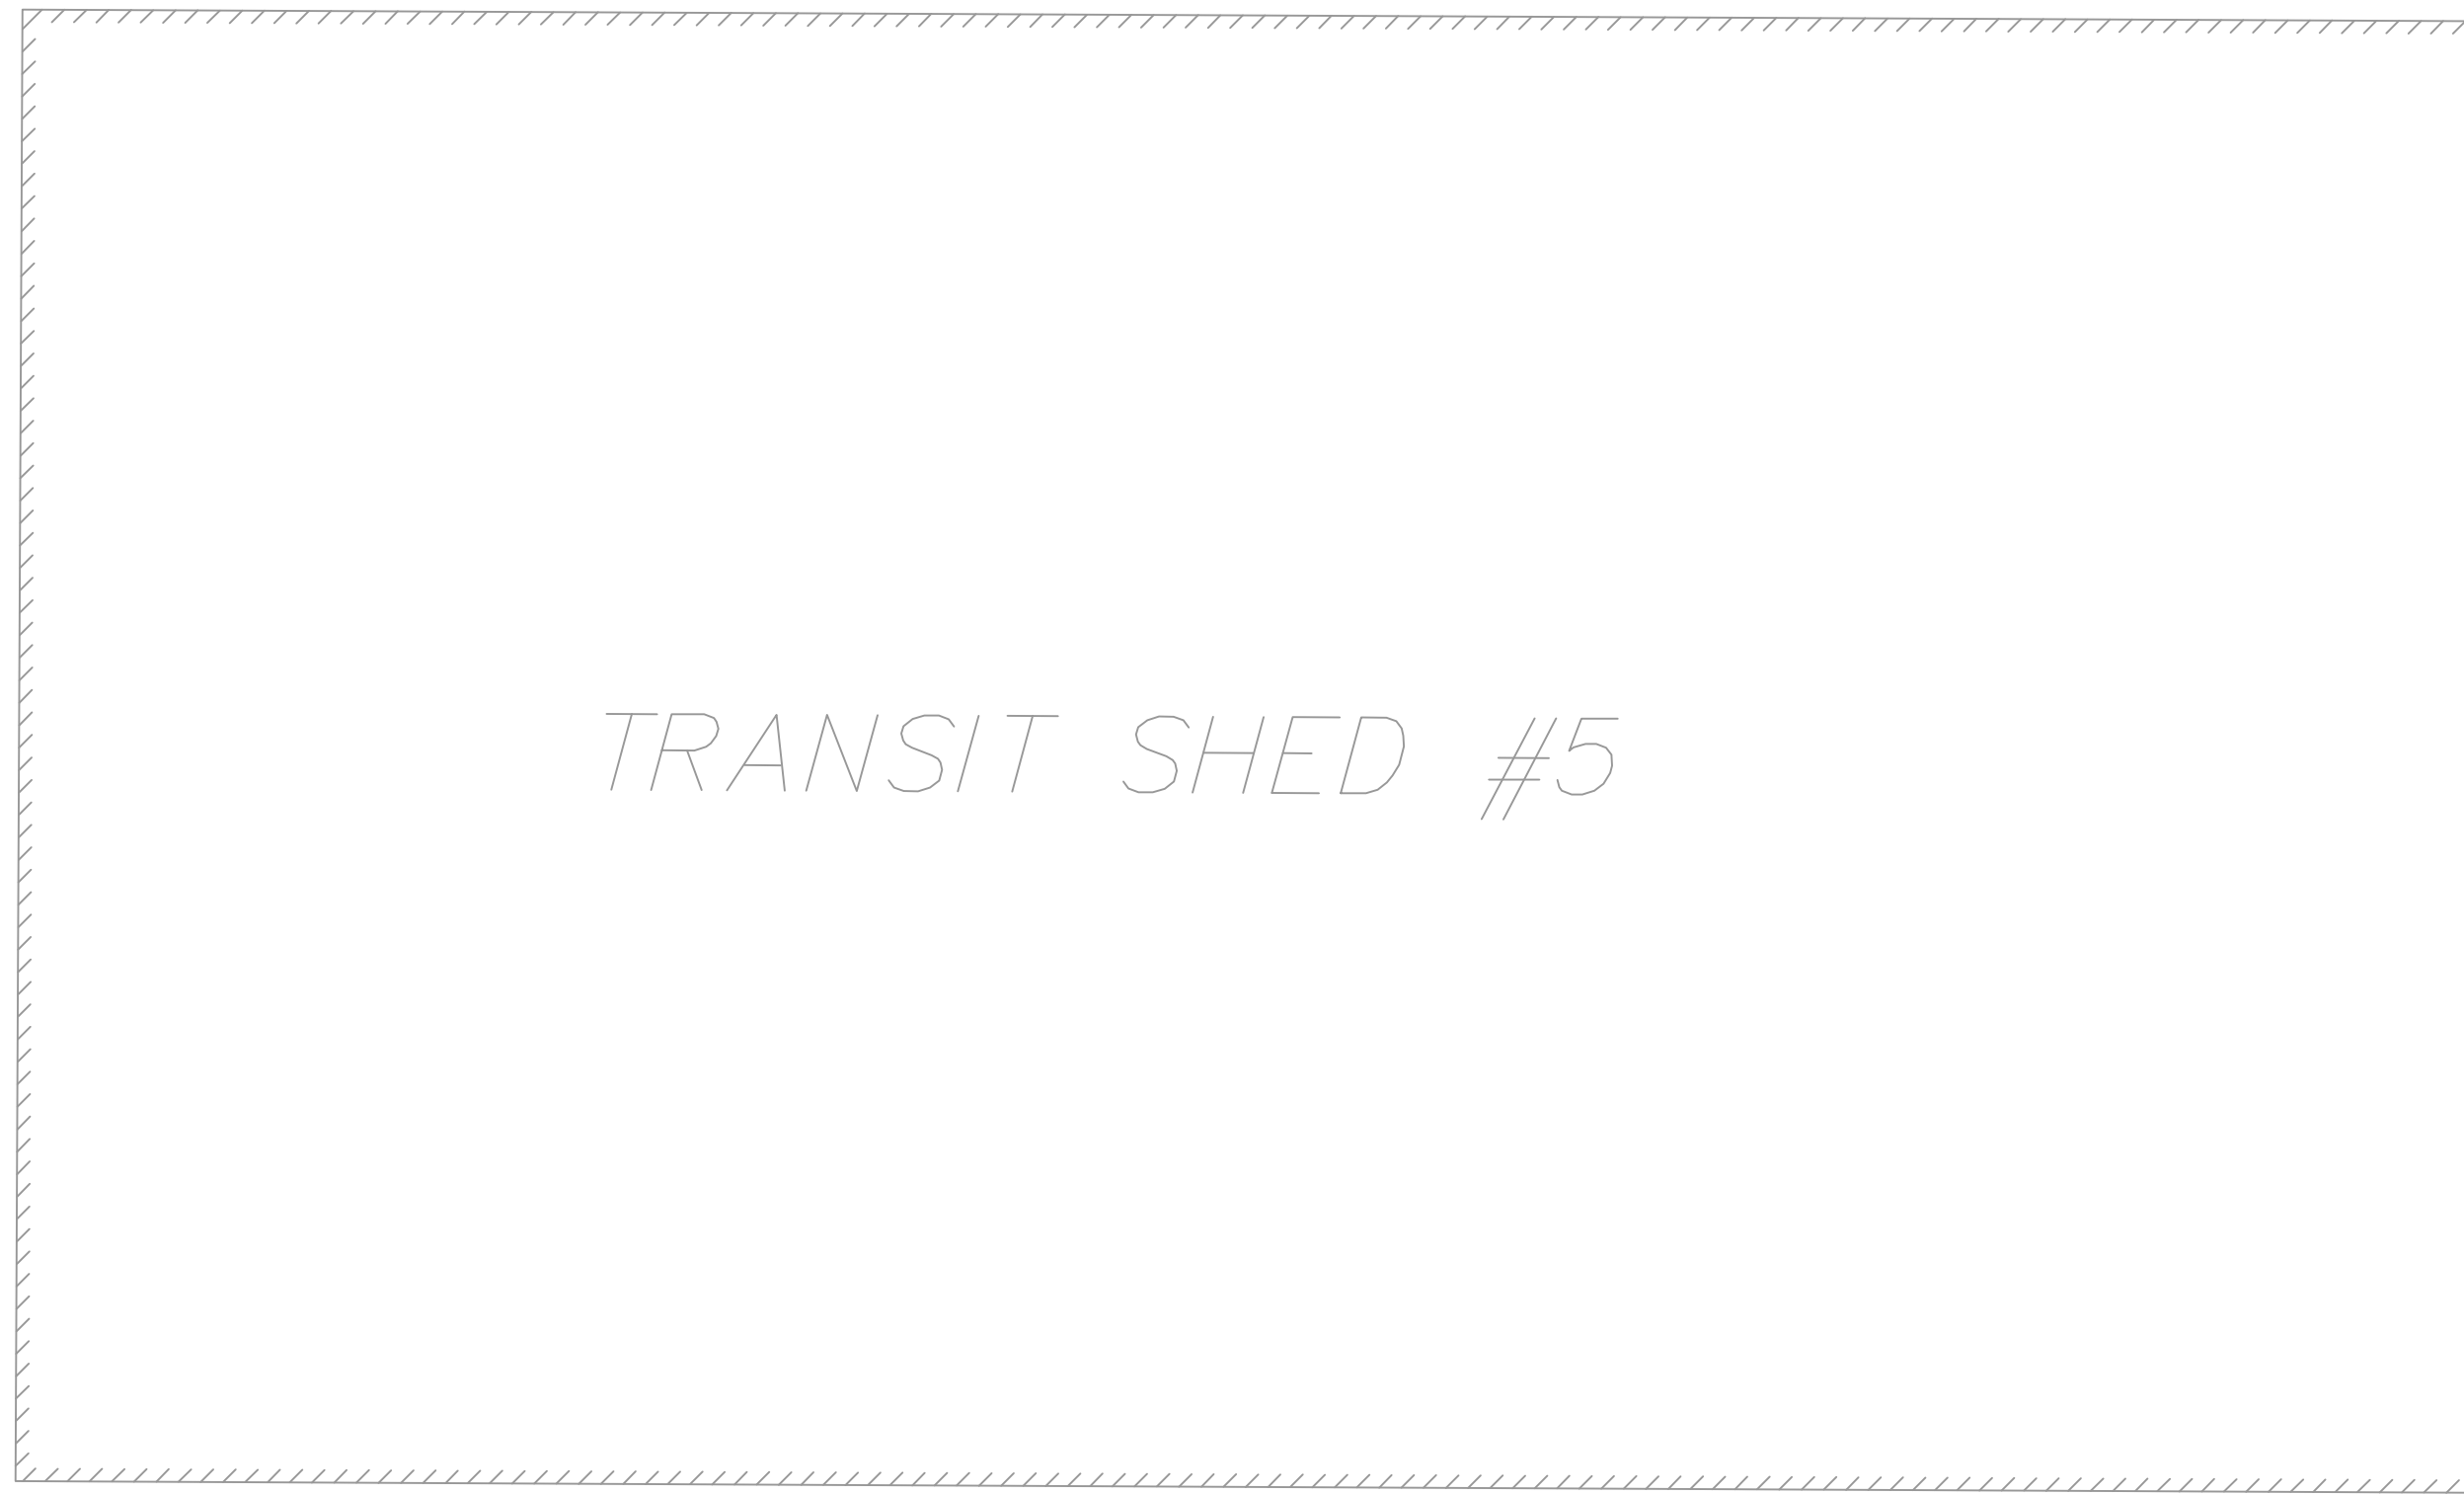


PROPOSED PRECAST CONC. CROSSING REFER TO TRACK DRAWINGS (TYP.)

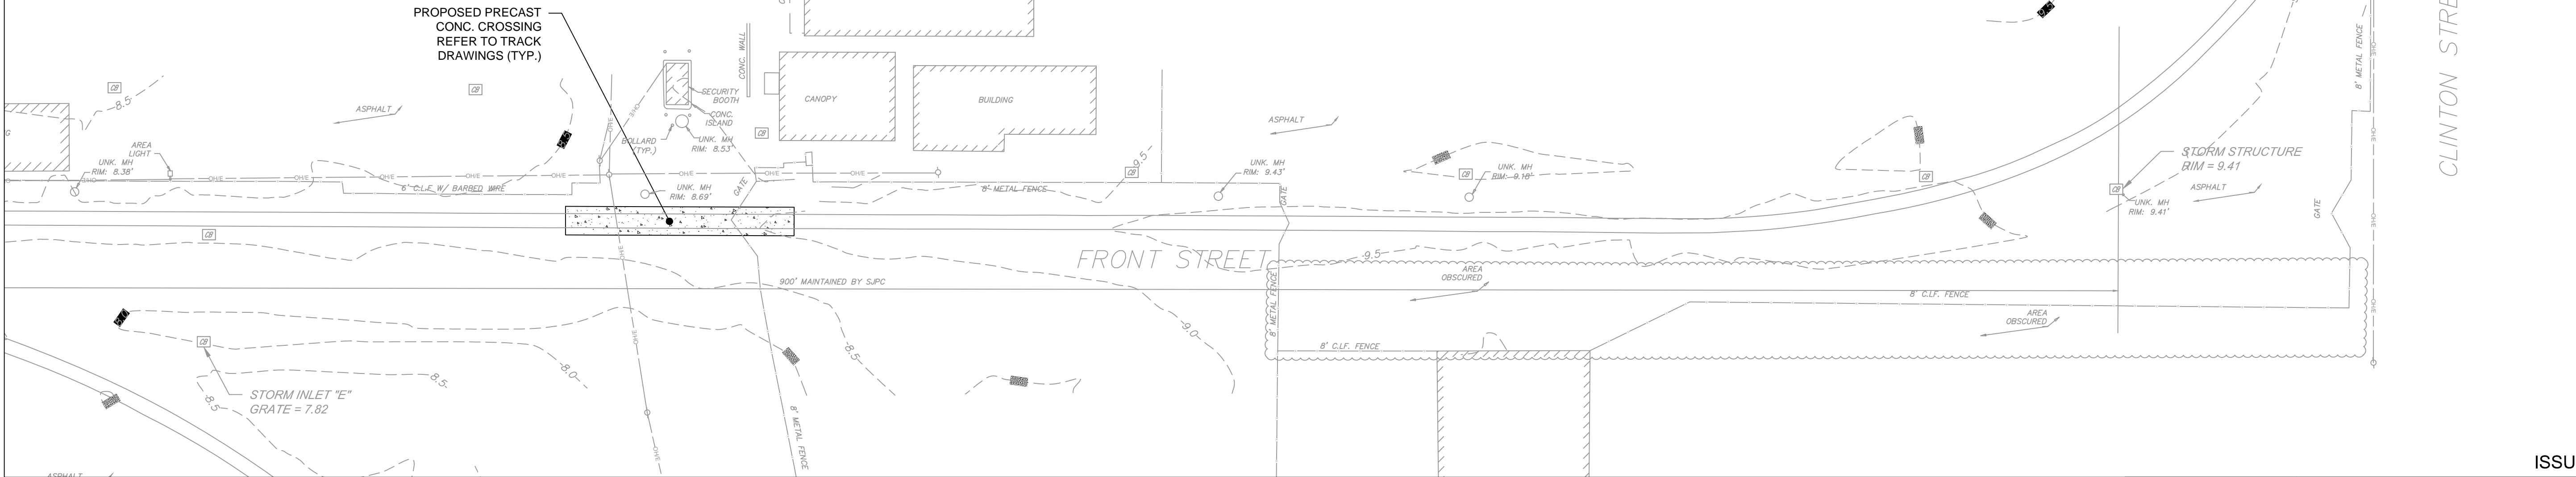

MATCH LINE

SHEET 6

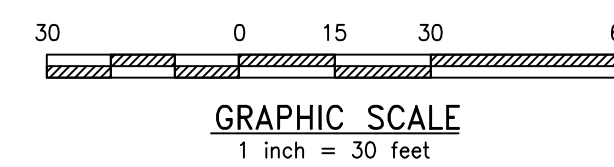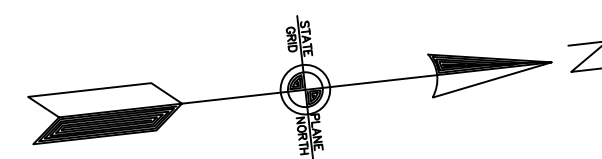

ISSUED FOR BID


URBAN ENGINEERS, INC.
 530 Walnut Street
 Philadelphia, PA 19106
 (215) 922-8080 Fax (215) 922-8082

LOCATION: **CAMDEN, NJ**




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DWN: GJB PROJ # 2021500064.000 DRAWING NUMBER: C-405
 CHK: MJT DATE 06/24/2022


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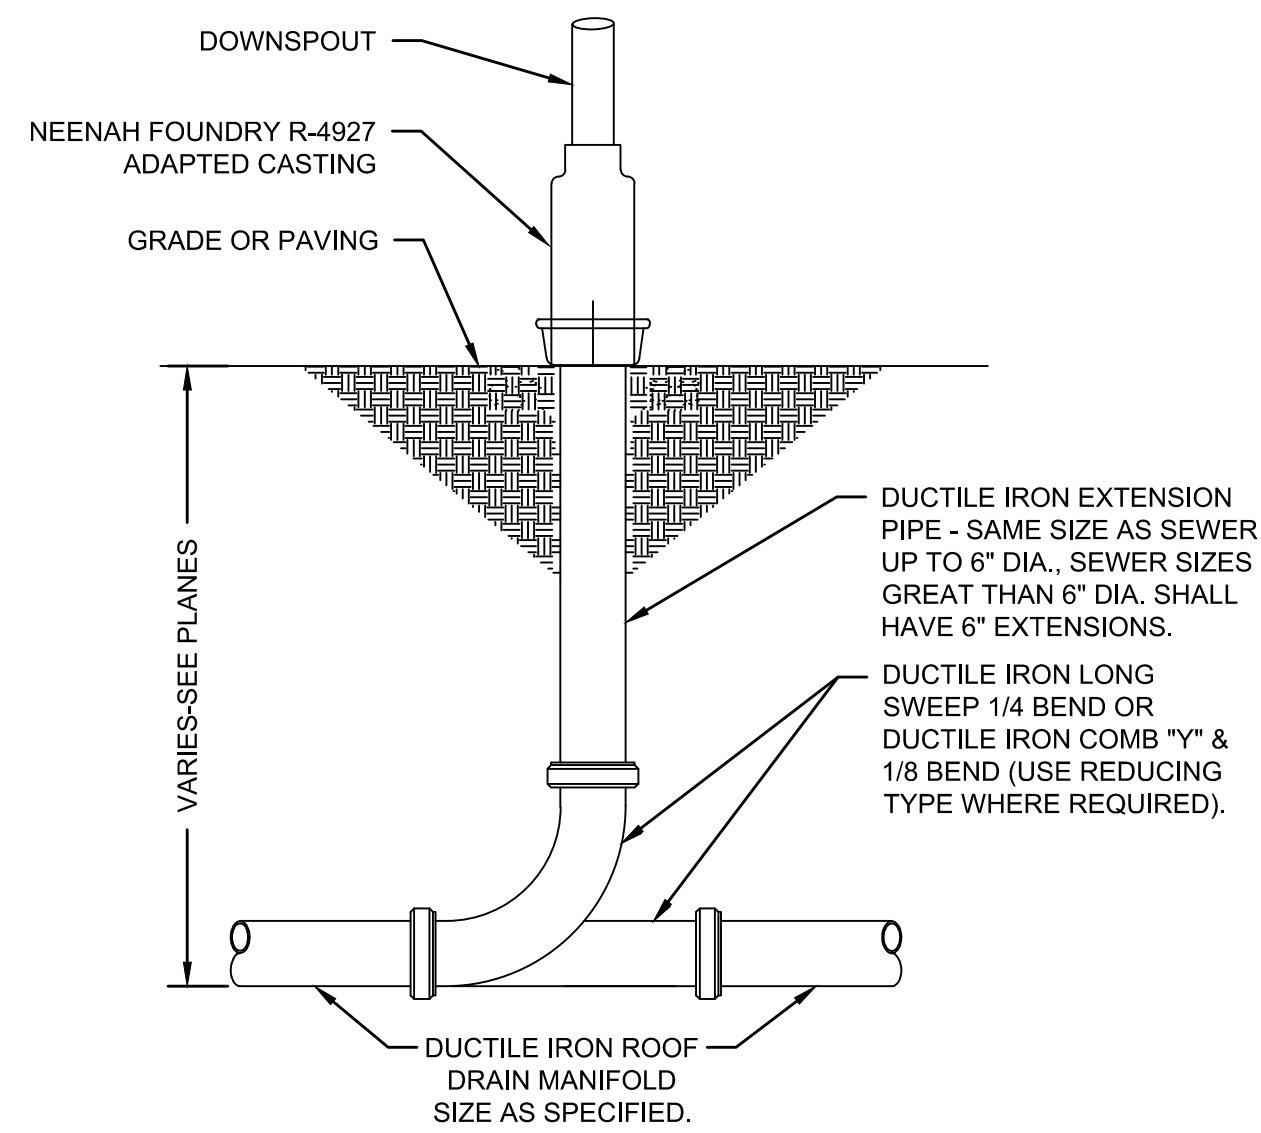


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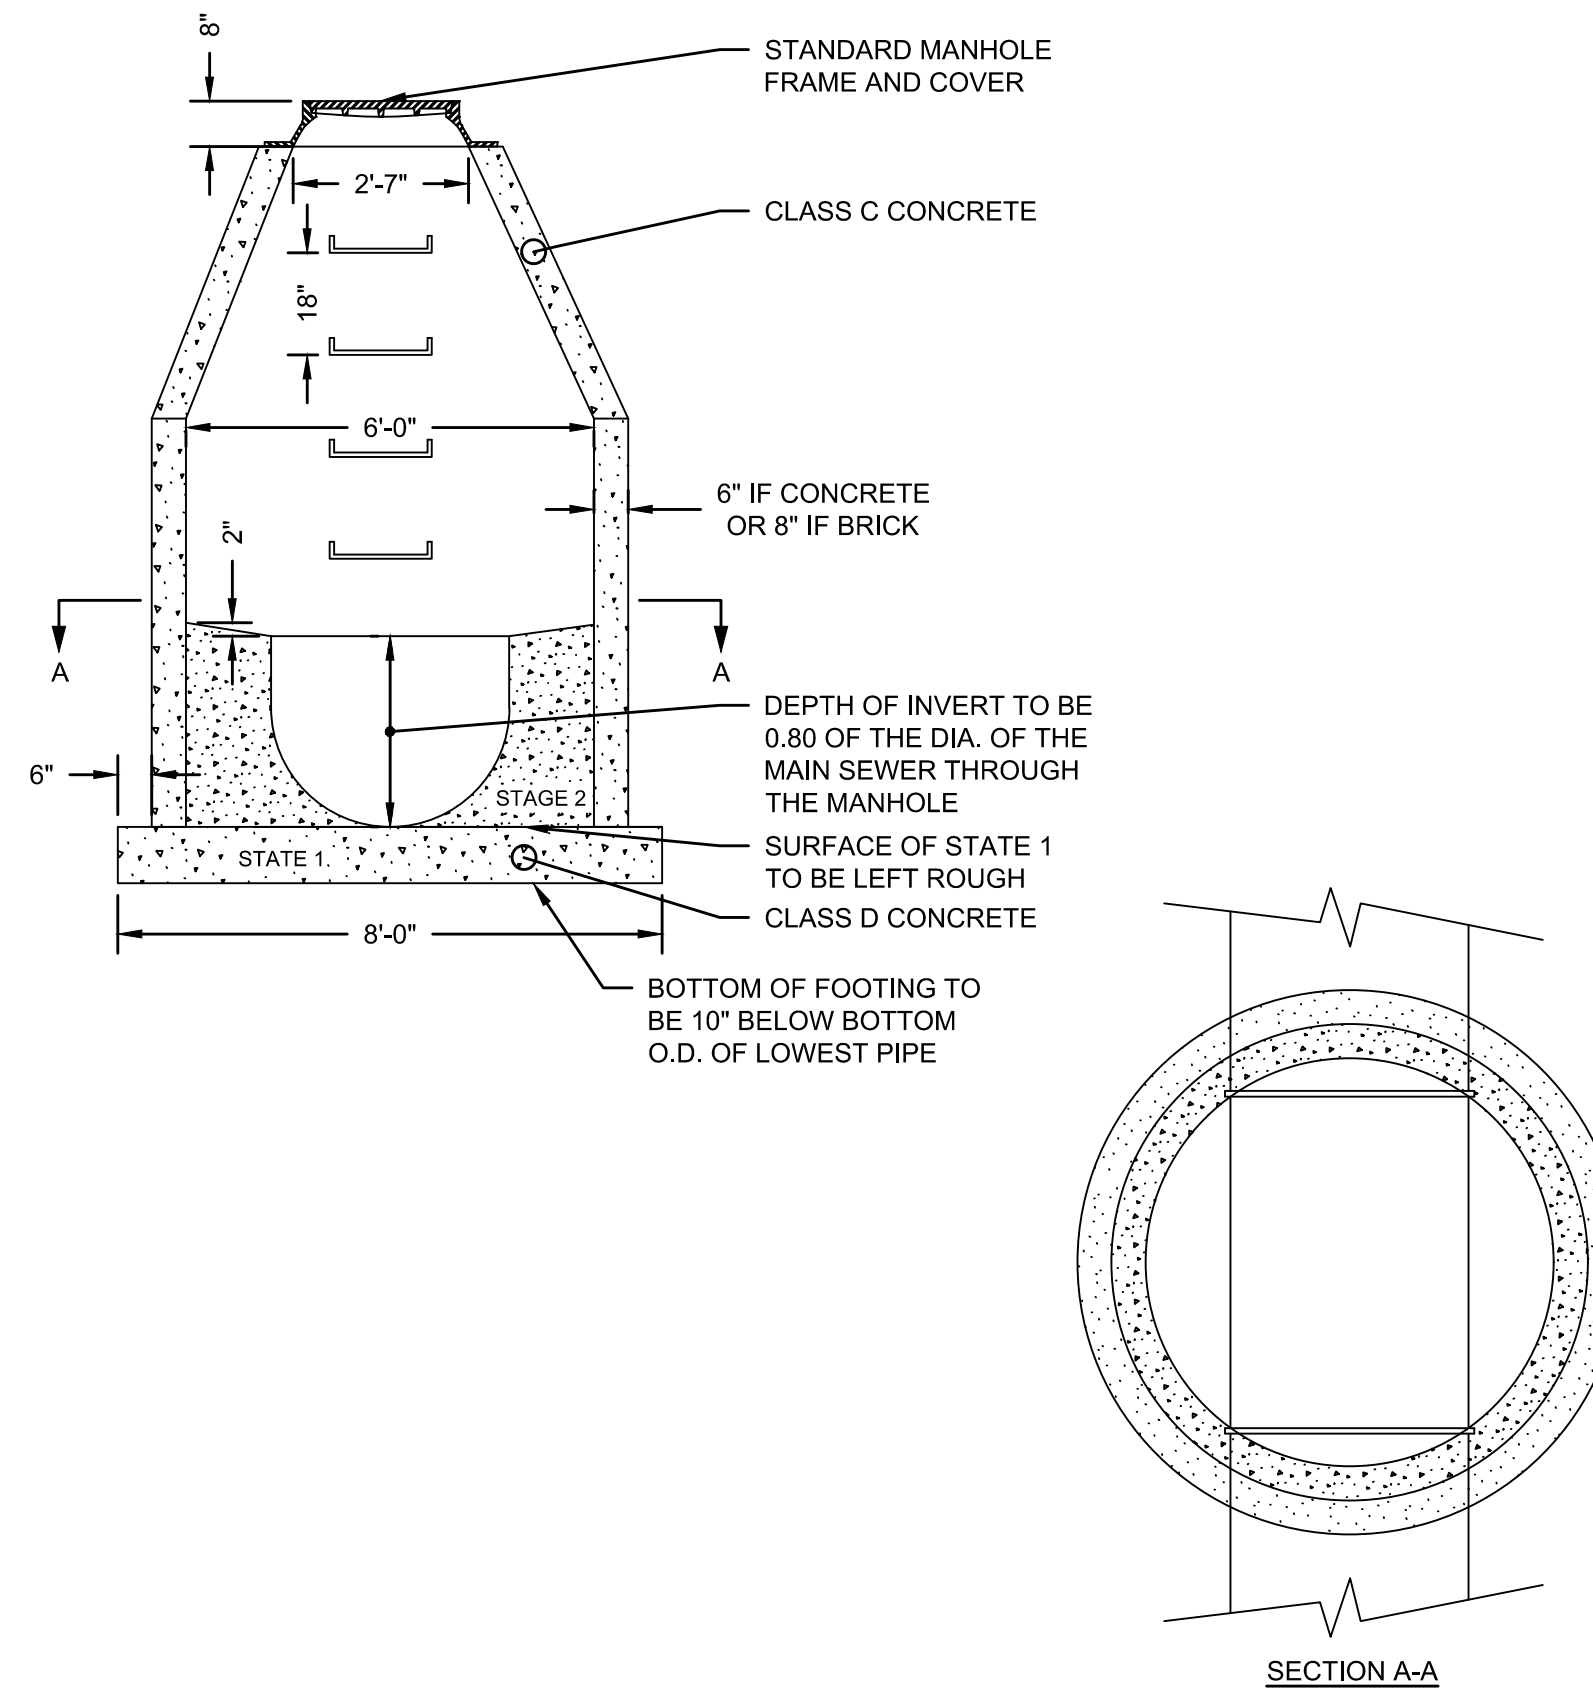
LOCATION: **CAMDEN, NJ**

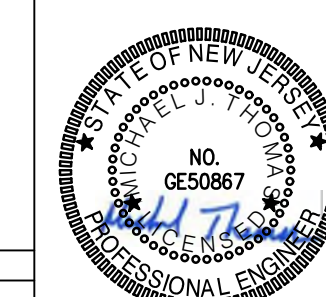TITLE: **SJPC BALZANO MARINE TERMINAL RAIL INFRASTRUCTURE REHABILITATION PROPOSED MATERIALS 6**


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 CHK: MJT DATE 06/24/2022

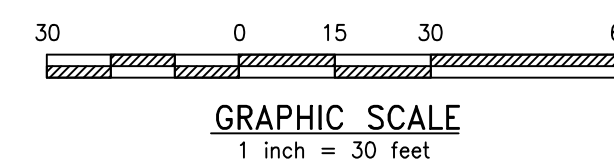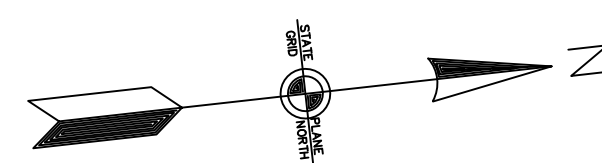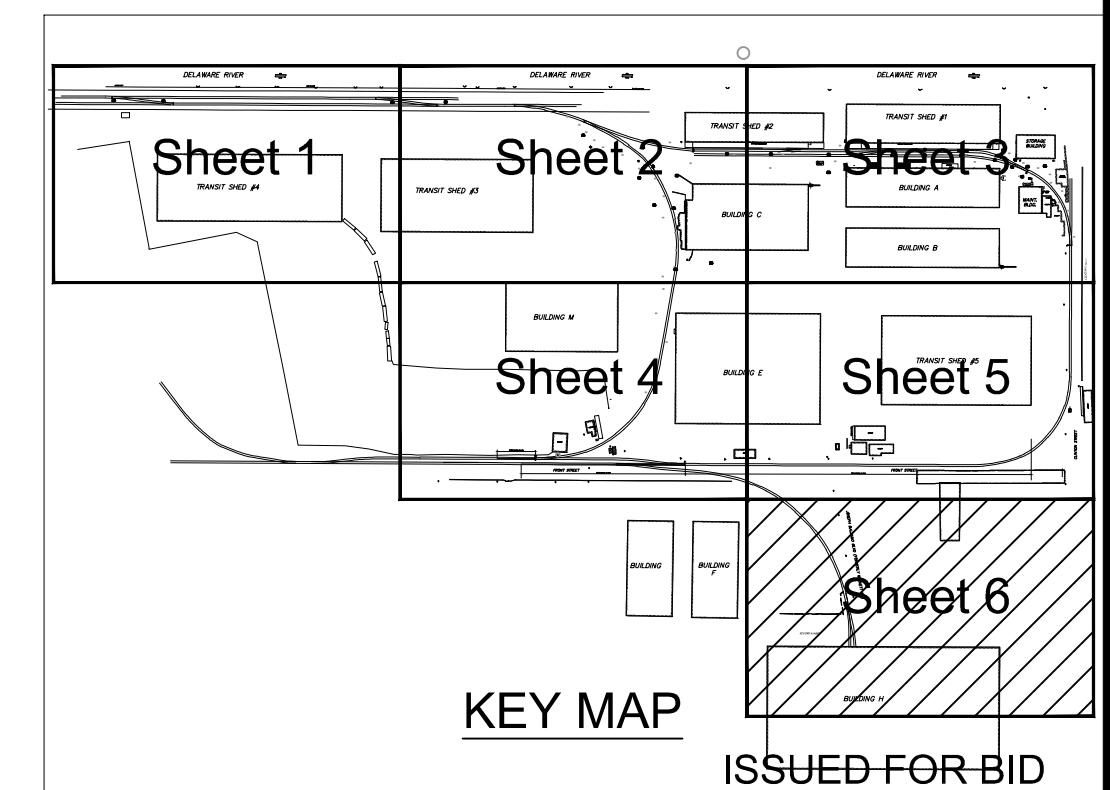

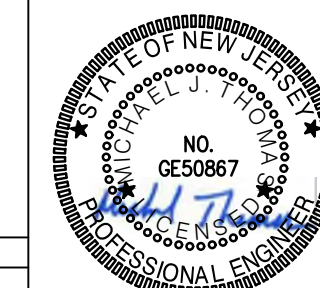
6 DOWNSPOUT MANIFOLD RISER
NOT TO SCALE




4 STANDARD MANHOLE
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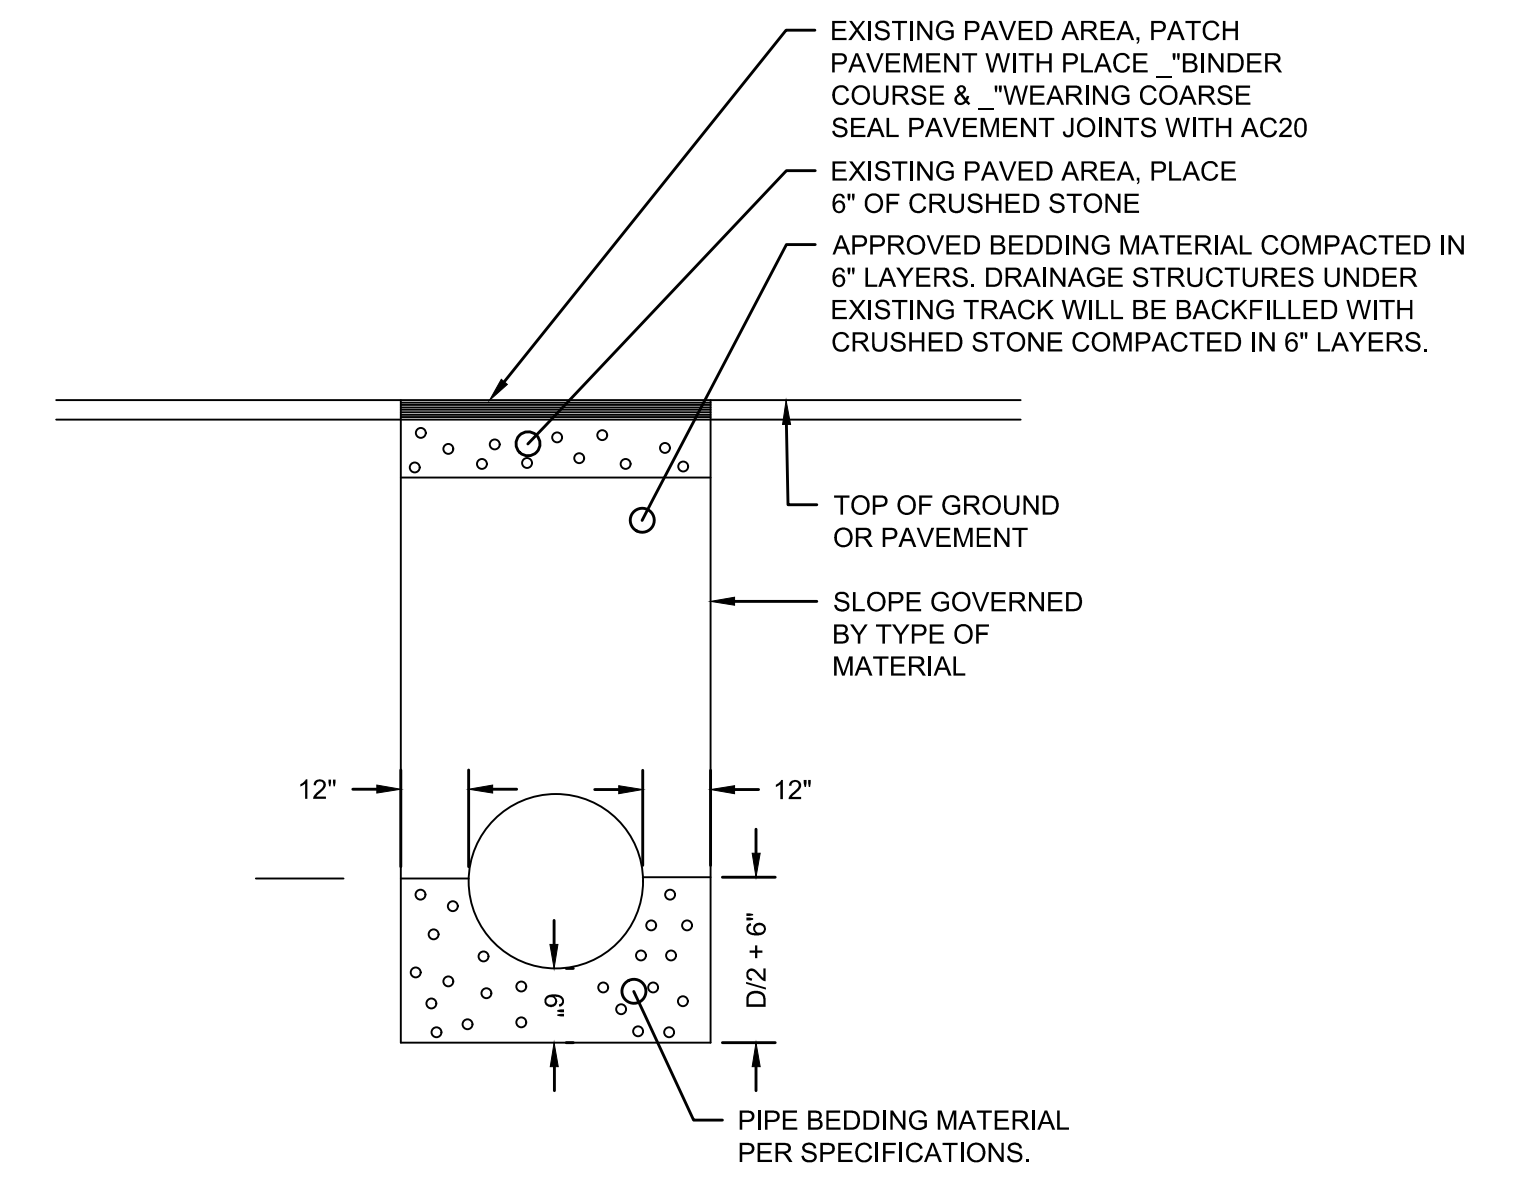
2 NEW INLET DETAIL
NOT TO SCALE

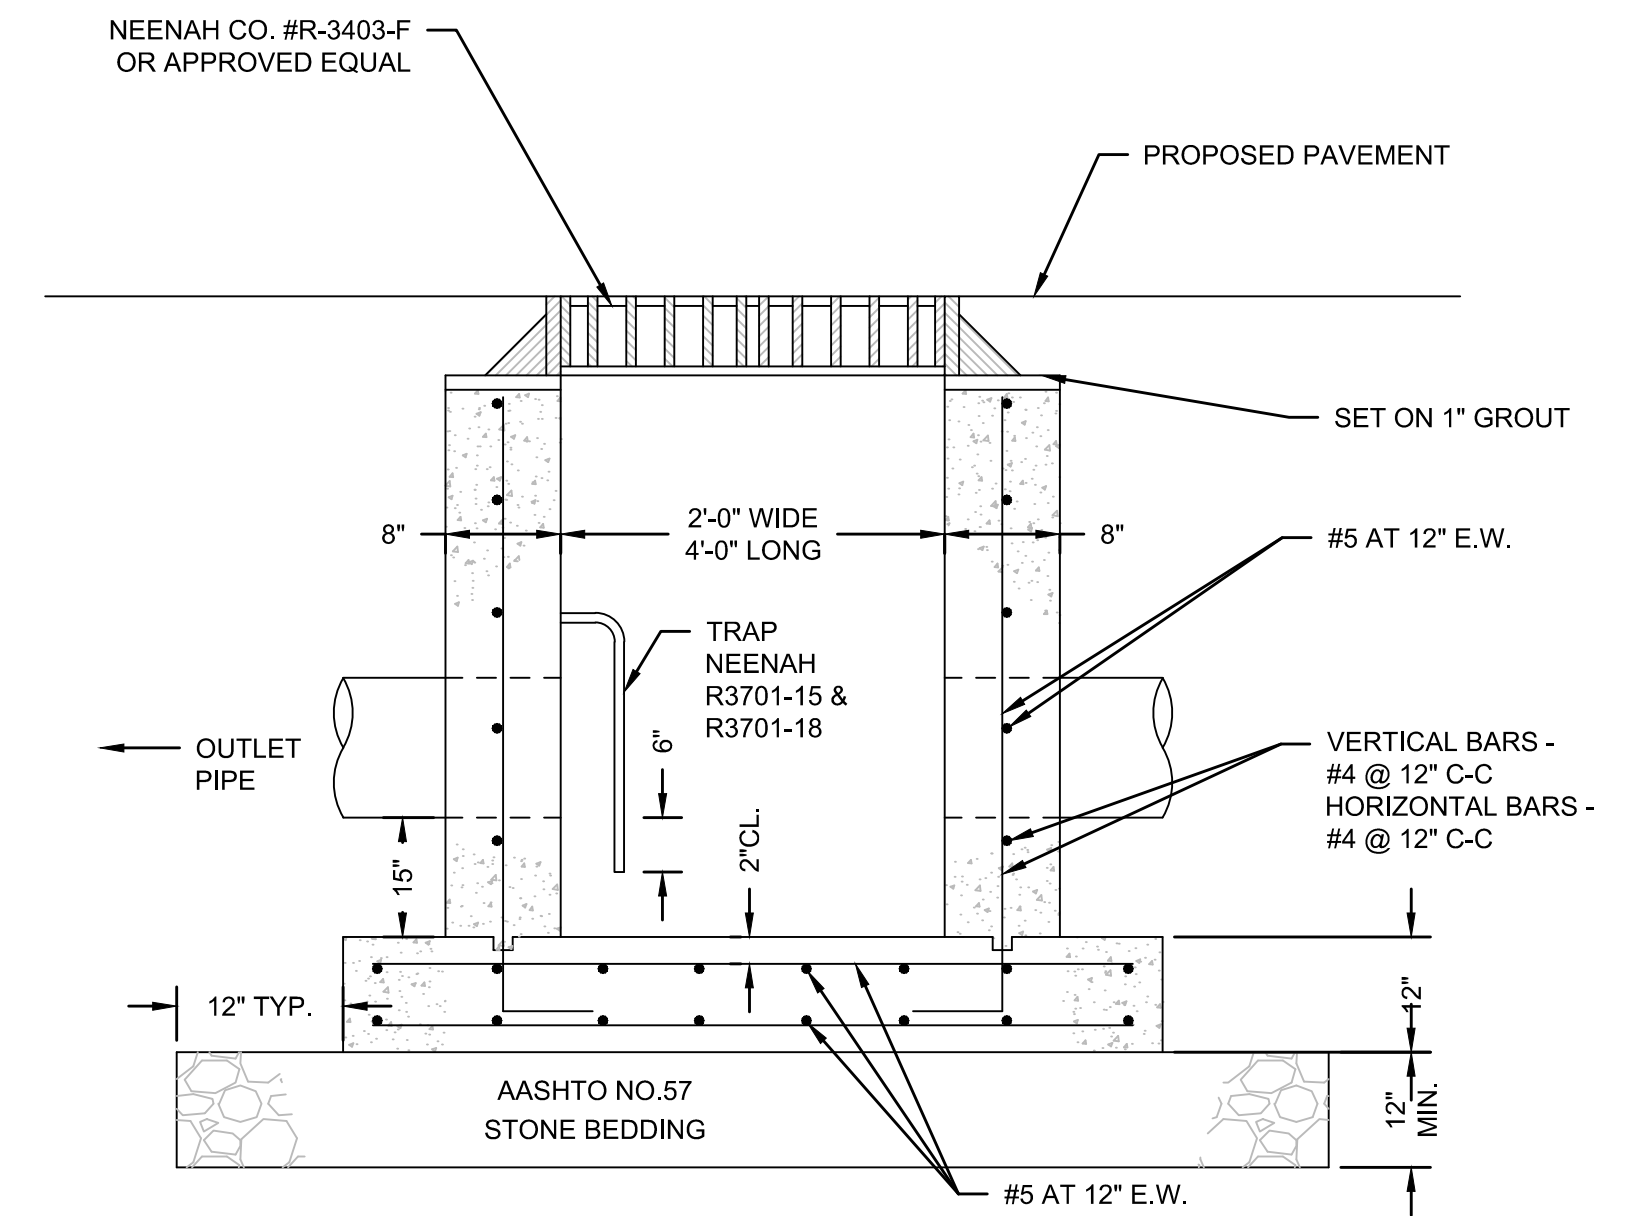

5 PIPE BOLLARD DETAIL
NOT TO SCALE

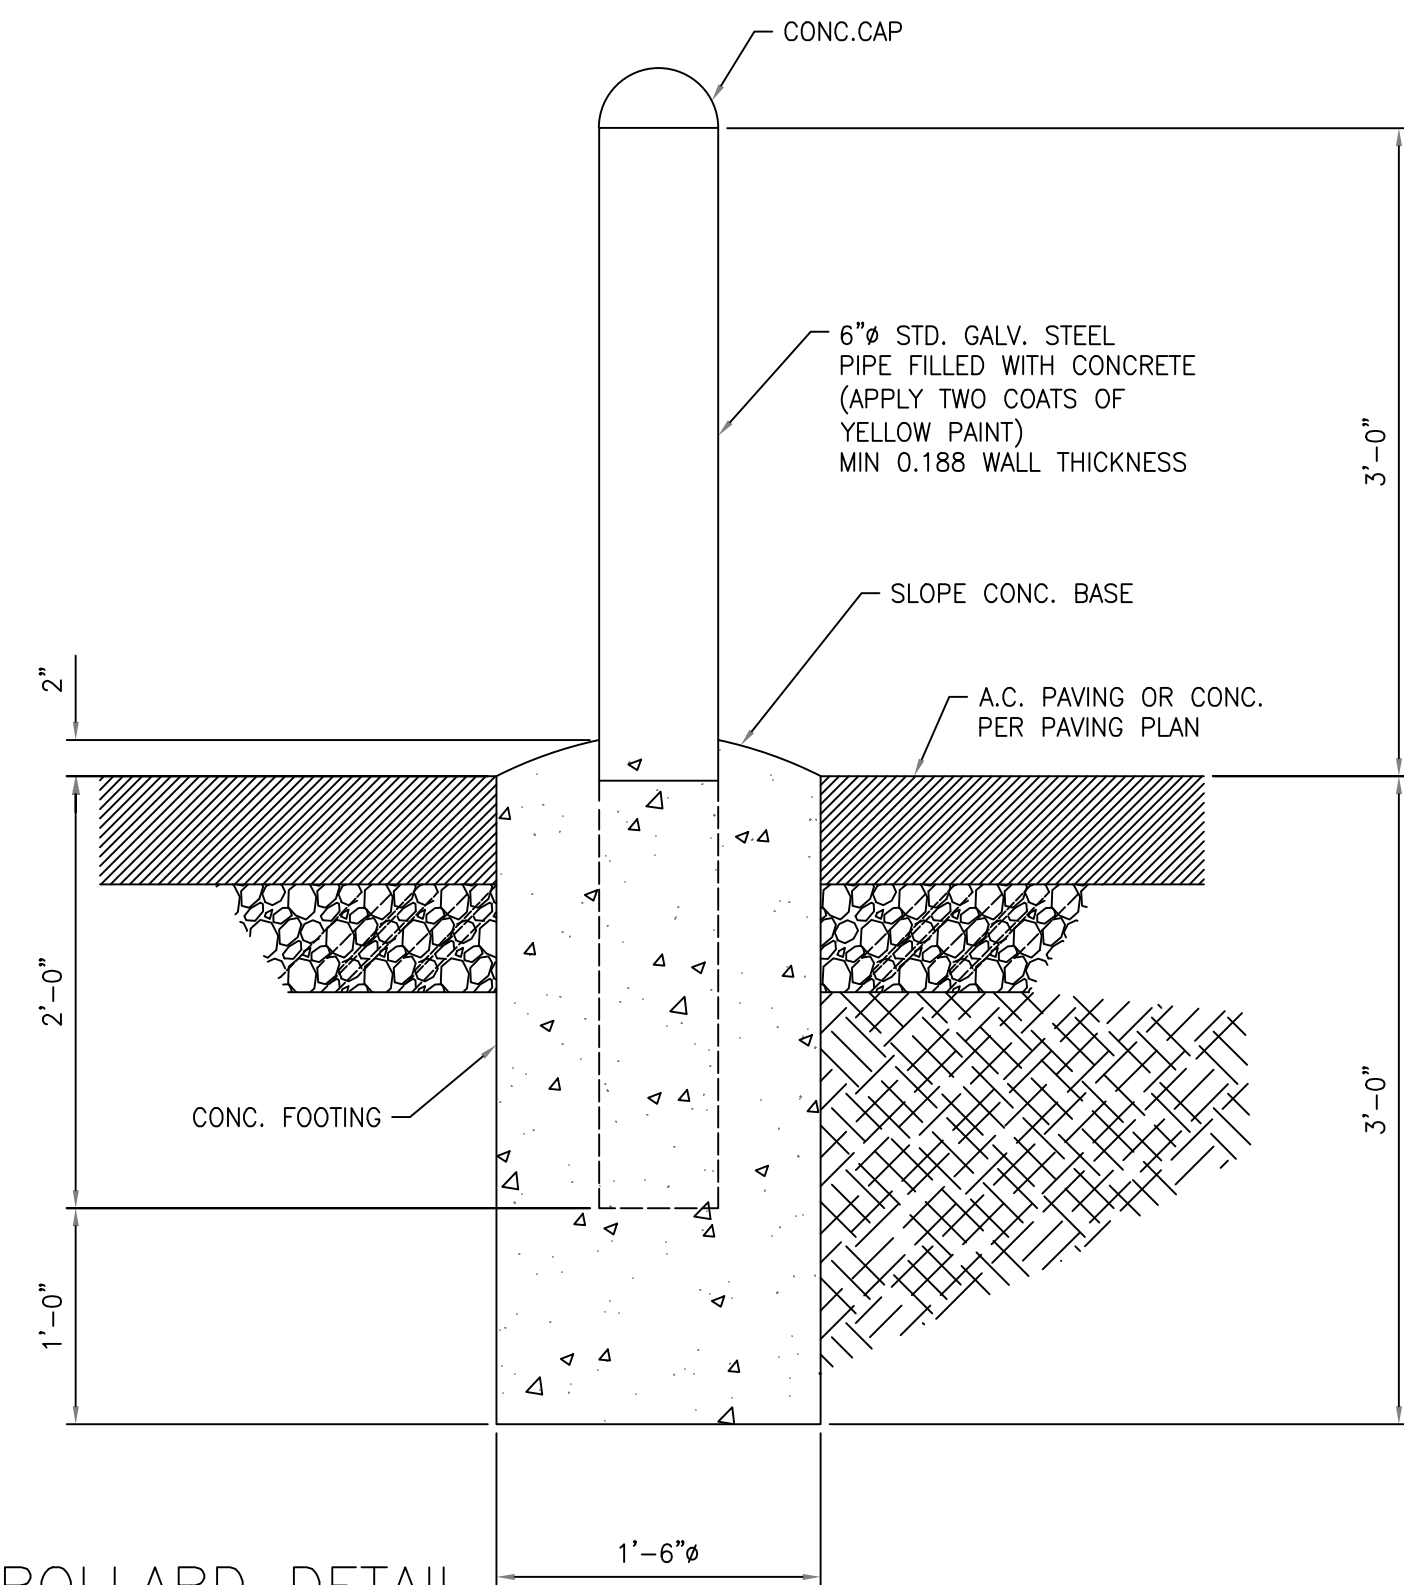


3 CIRCULAR PIPE TRENCH BEDDING
NOT TO SCALE

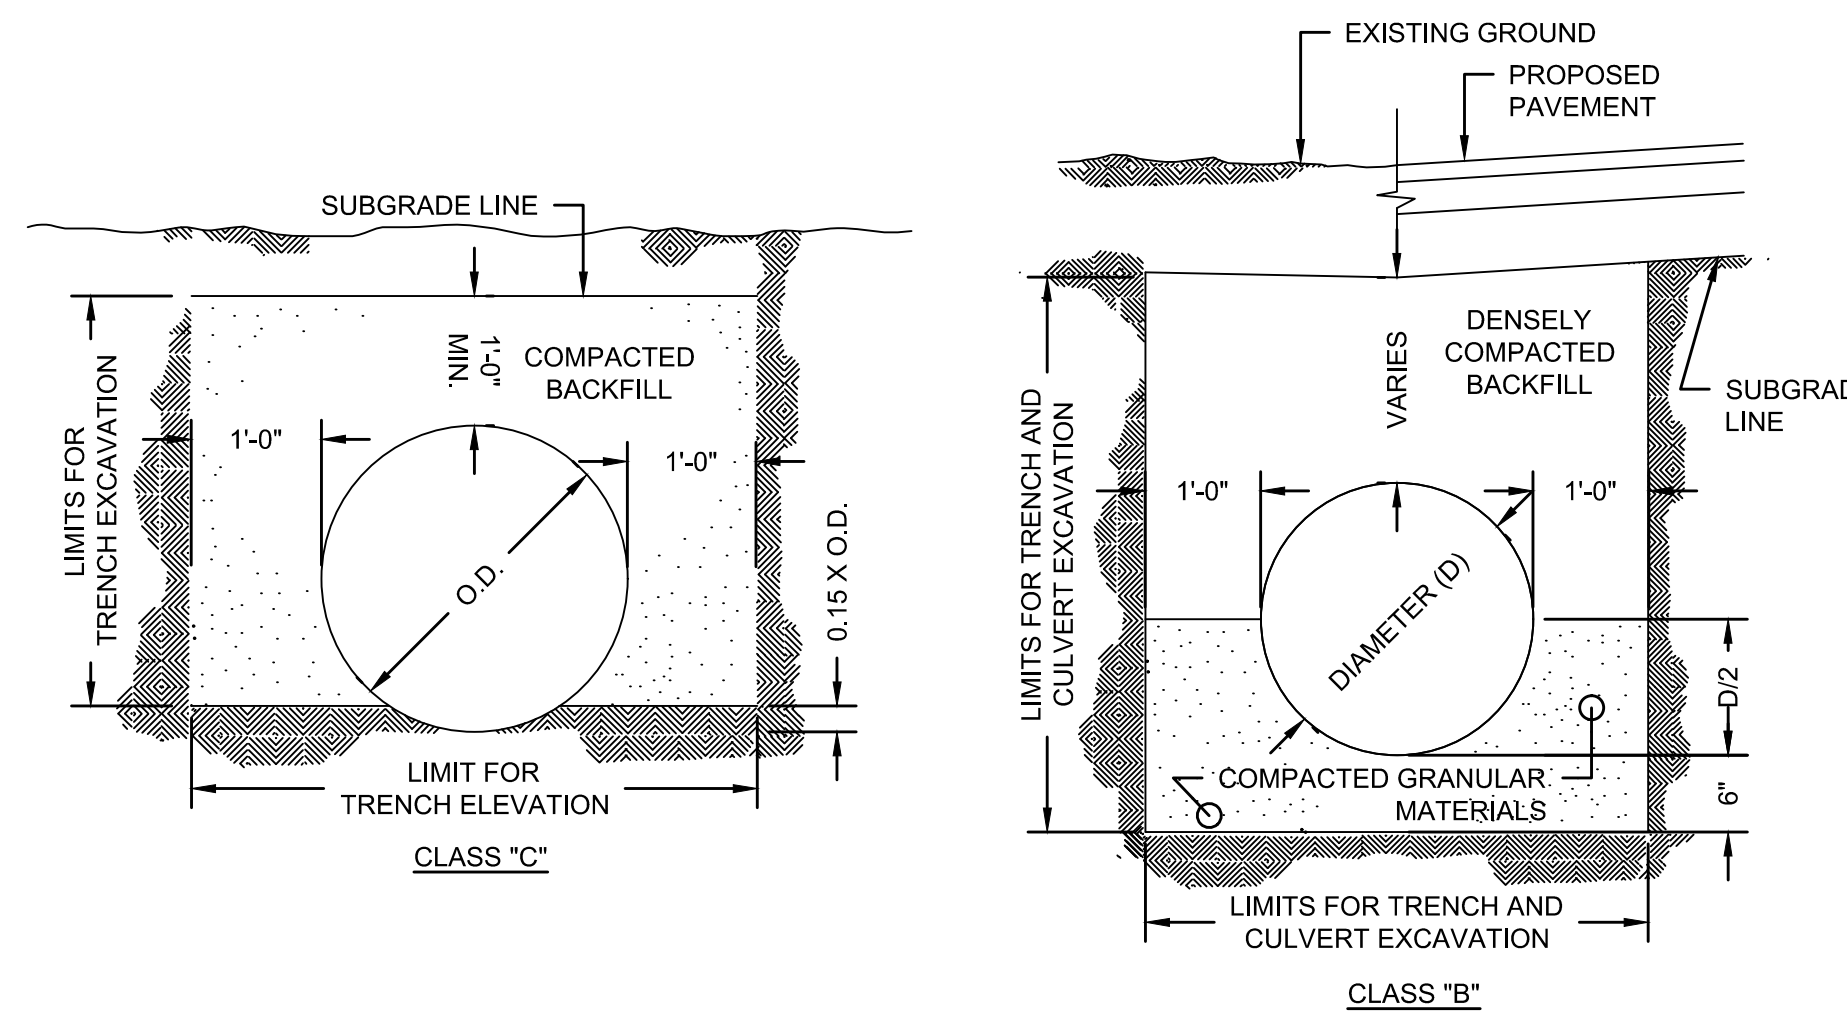

1 UTILITY TRENCHING
NOT TO SCALE



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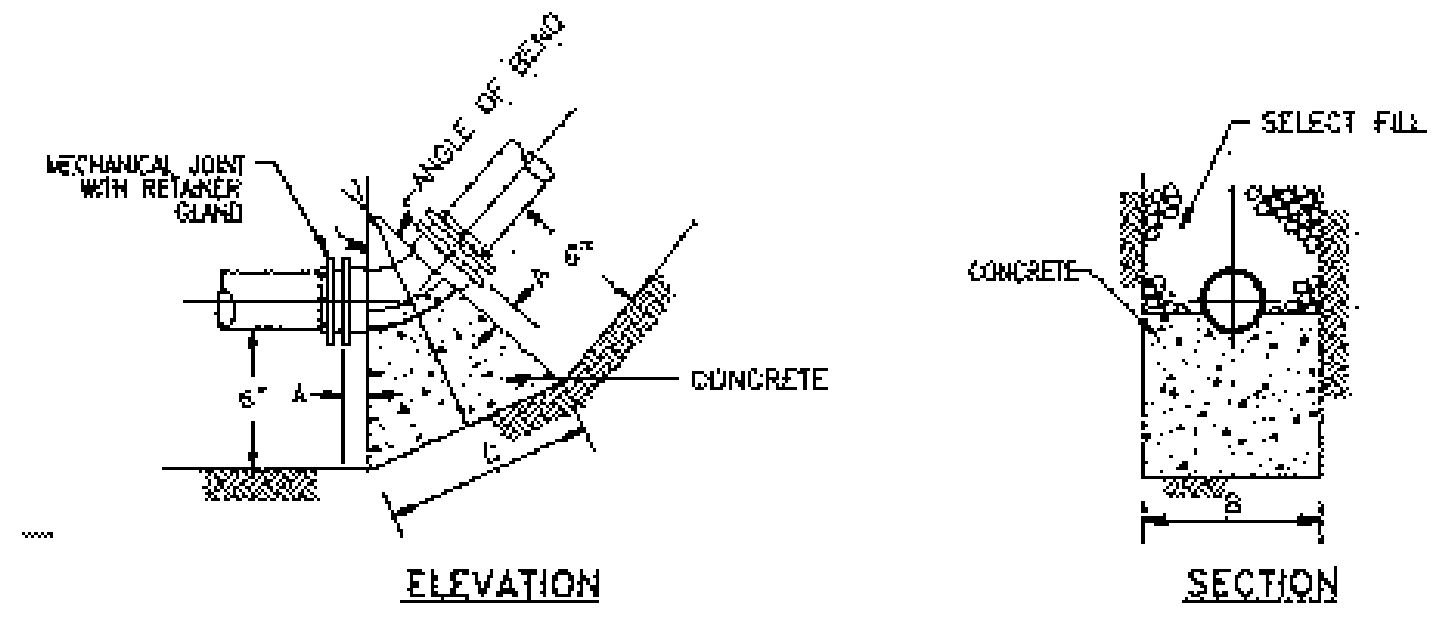
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Philadelphia, PA 19106
(215) 922-8080 Fax (215) 922-8082

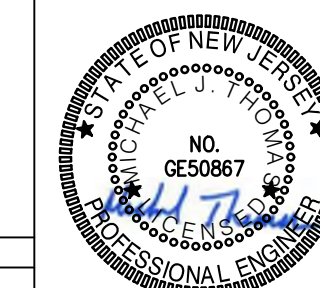LOCATION: **CAMDEN, NJ**
TITLE: **SJPC BALZANO MARINE TERMINAL RAIL INFRASTRUCTURE REHABILITATION PROPOSED SITE DETAILS 1**

DWN: GJB PROJ # 2021500064.000 DRAWING NUMBER: **C-501**
CHK: MJT DATE: 06/24/2022



4 FIRE HYDRANT ASSEMBLY DETAIL
NOT TO SCALE

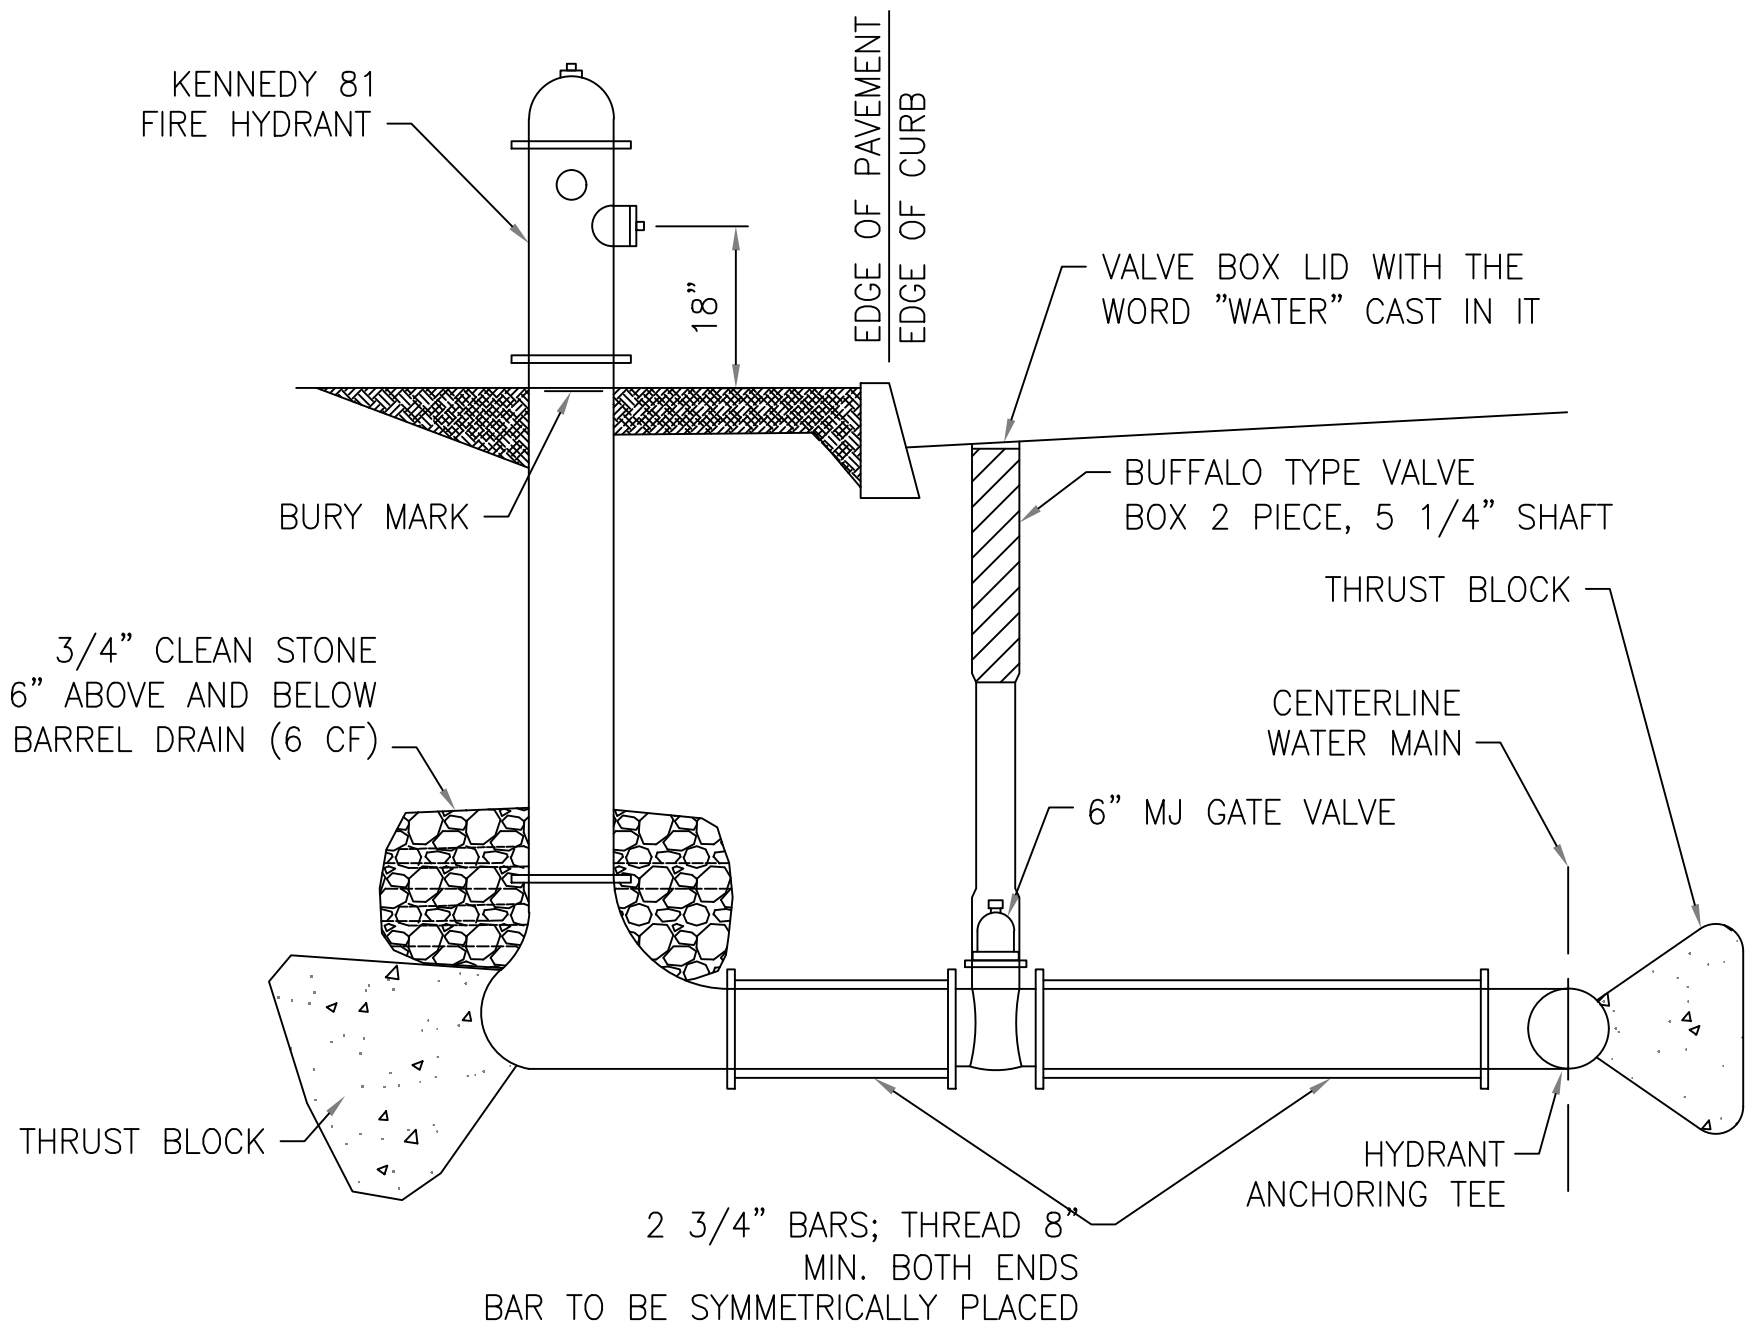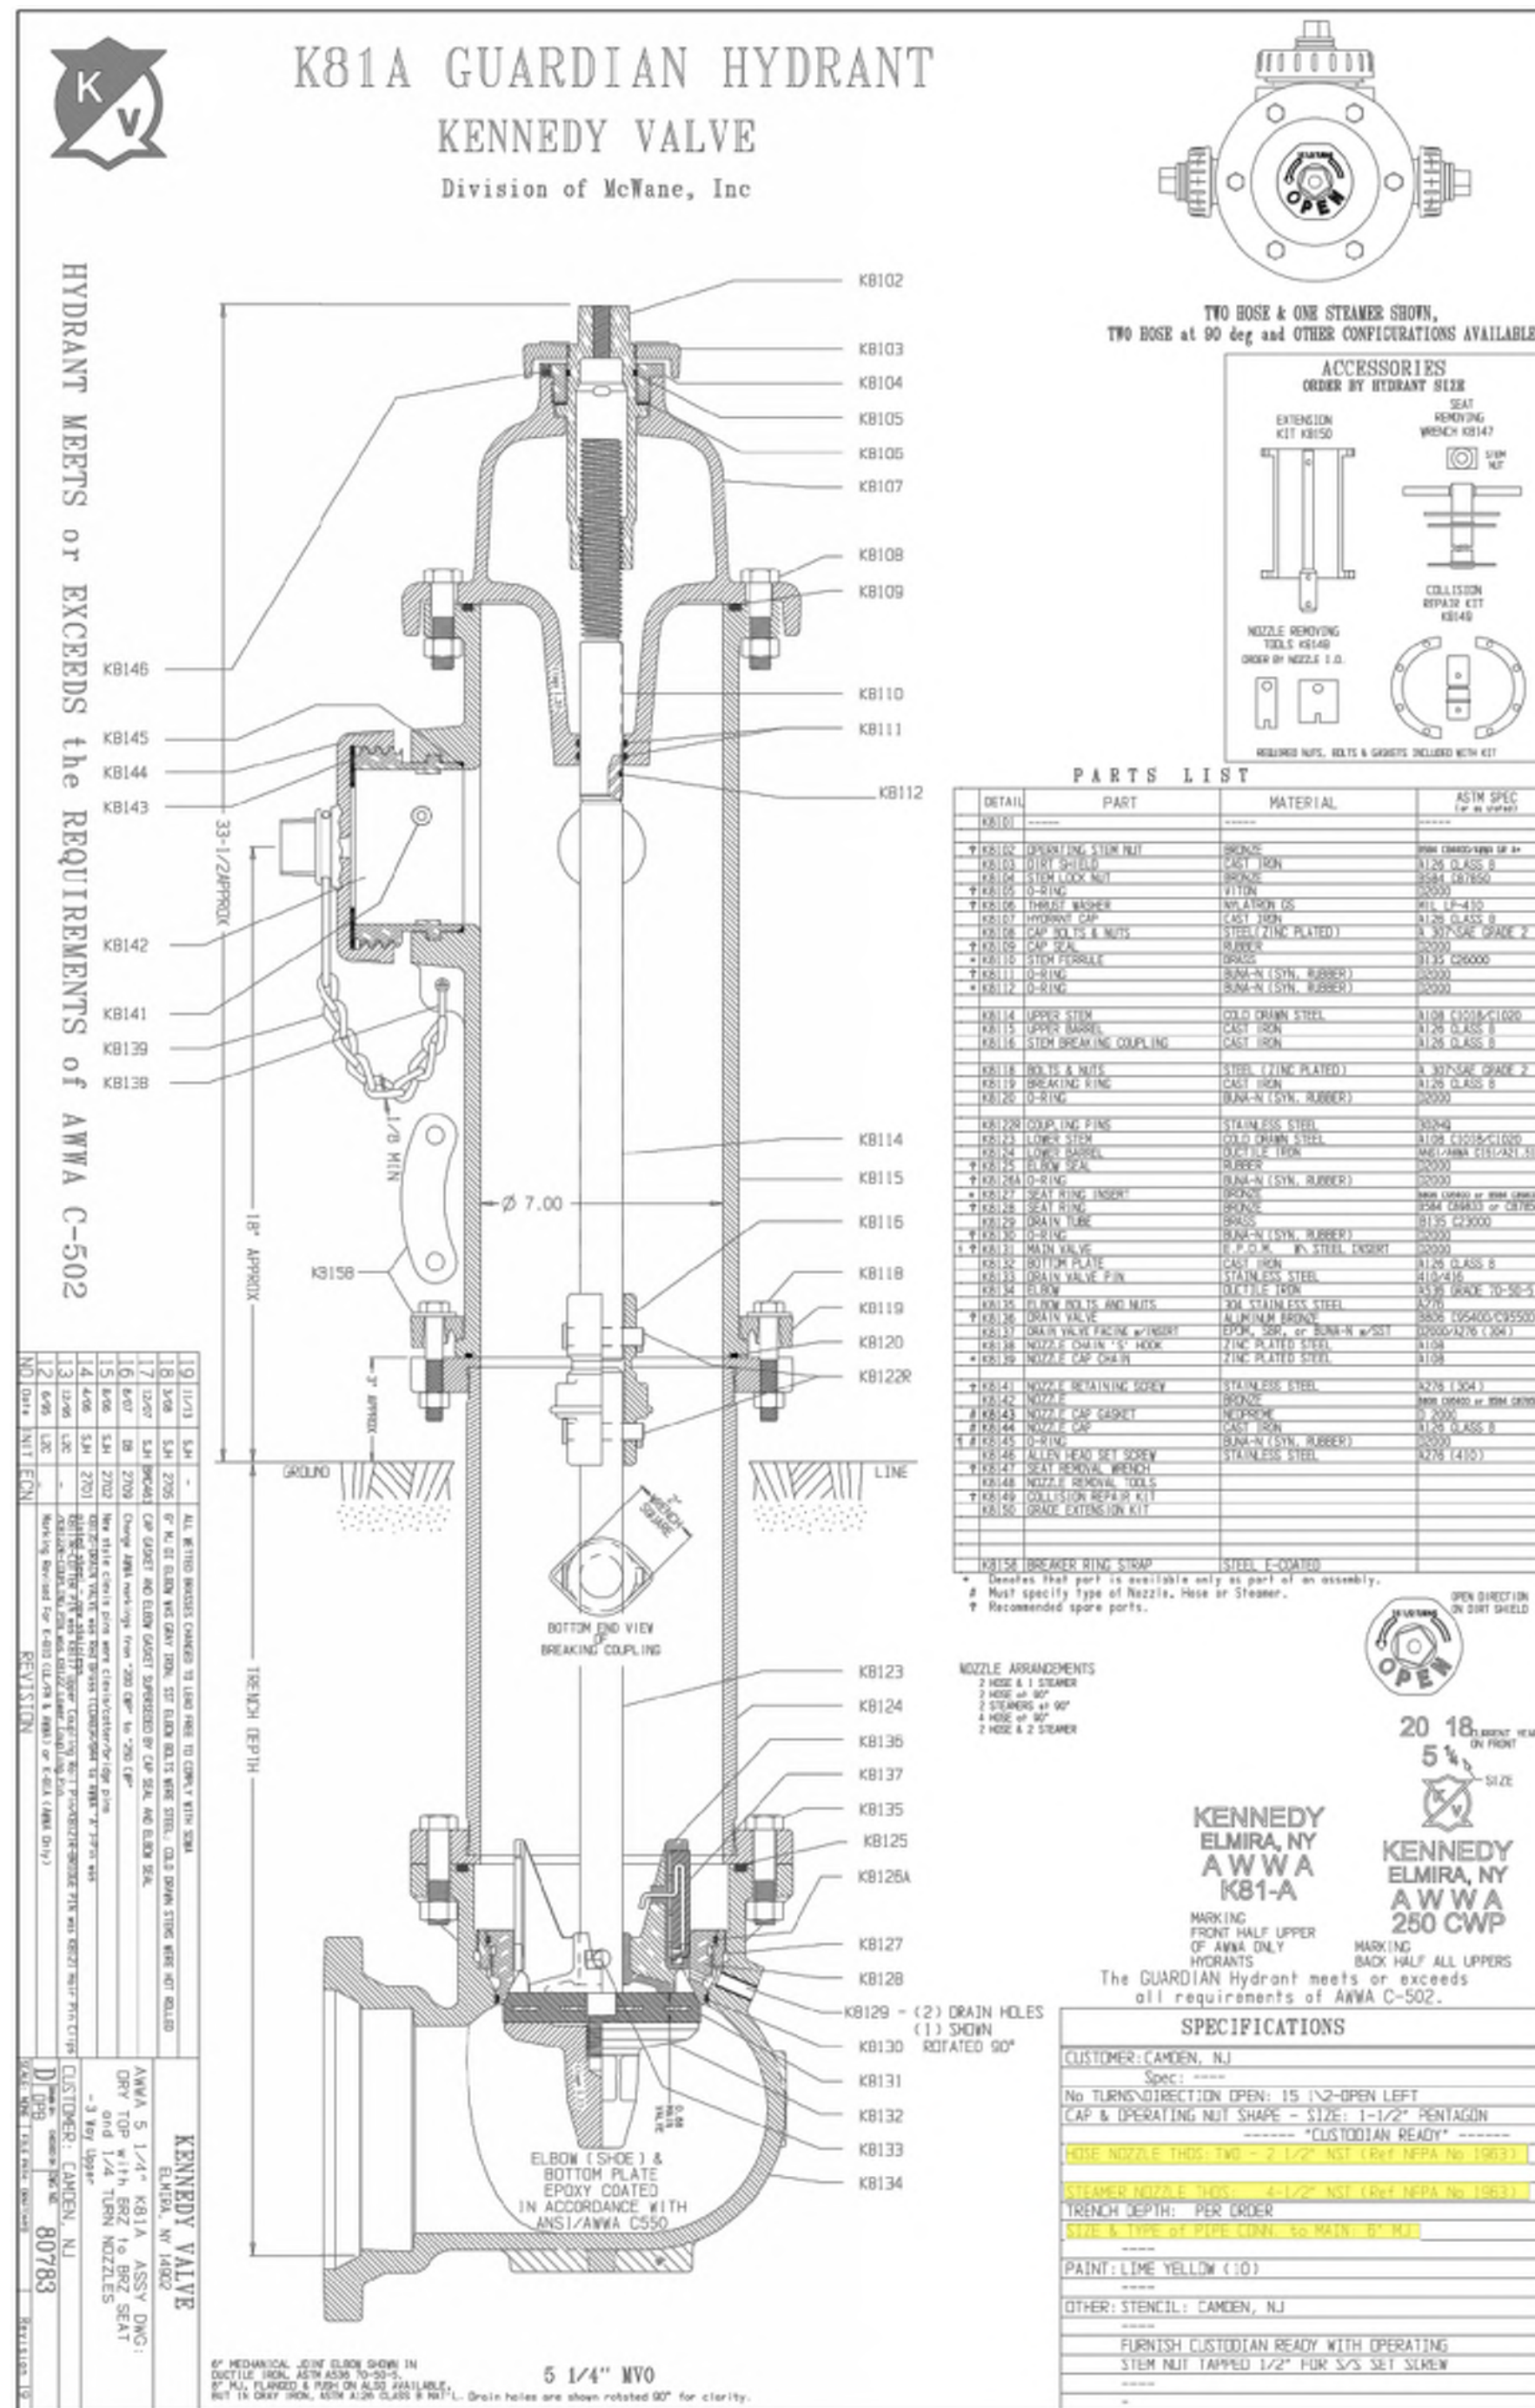


PIPE SIZE	45°(1/8)				22-1/2°(1/16)				11-1/4°(1/32)			
	A	B	C	D	A	B	C	D	A	B	C	D
6"	2.5"	1.5"	1.2"	.02	2.5"	1.8"	1.1"	.04	2.5"	1.8"	1.1"	.03
8"	2.5"	2.4"	1.4"	.04	2.5"	2.4"	1.1"	.04	2.5"	2.4"	1.1"	.03
12"	2.5"	2.8"	1.9"	.07	2.5"	2.8"	1.5"	.07	2.5"	2.8"	1.3"	.06


D=APPROXIMATE VOLUME OF CONCRETE IN CUBIC YARDS

- NOTES:**
1. WRAP FITTING WITH TAR PAPER BEFORE PLACING CONCRETE.
 2. CONCRETE SHALL BE 4,000 PSI.
 3. CONCRETE SHALL HAVE A 2" MINIMUM CLEARANCE UNDER BELLS AND GLANDS.
 4. APPLY COLD BITUMEN COATING AS SPECIFIED.
 5. HARNESSES TO BE MADE OF A-36 STEEL.
 6. RODS TO BE A-193-GRADE B7.
 7. NUTS TO BE A-194-GRADE 4-HEAVY HEXAGON.
 8. CONCRETE MUST BEAR AGAINST UNDISTURBED SOIL.
 9. RETAINER GLANDS ON BRANCH OUTLETS ONLY UNLESS OTHERWISE DIRECTED.
 10. ALL FITTINGS MUST BE MECHANICAL JOINT.
 11. CONTRACTOR SHALL ADHERE TO THE TORQUE REQUIREMENTS PER CAMDEN STANDARDS.

2 CONCRETE ANCHOR FOR VERTICAL BENDS
NOT TO SCALE

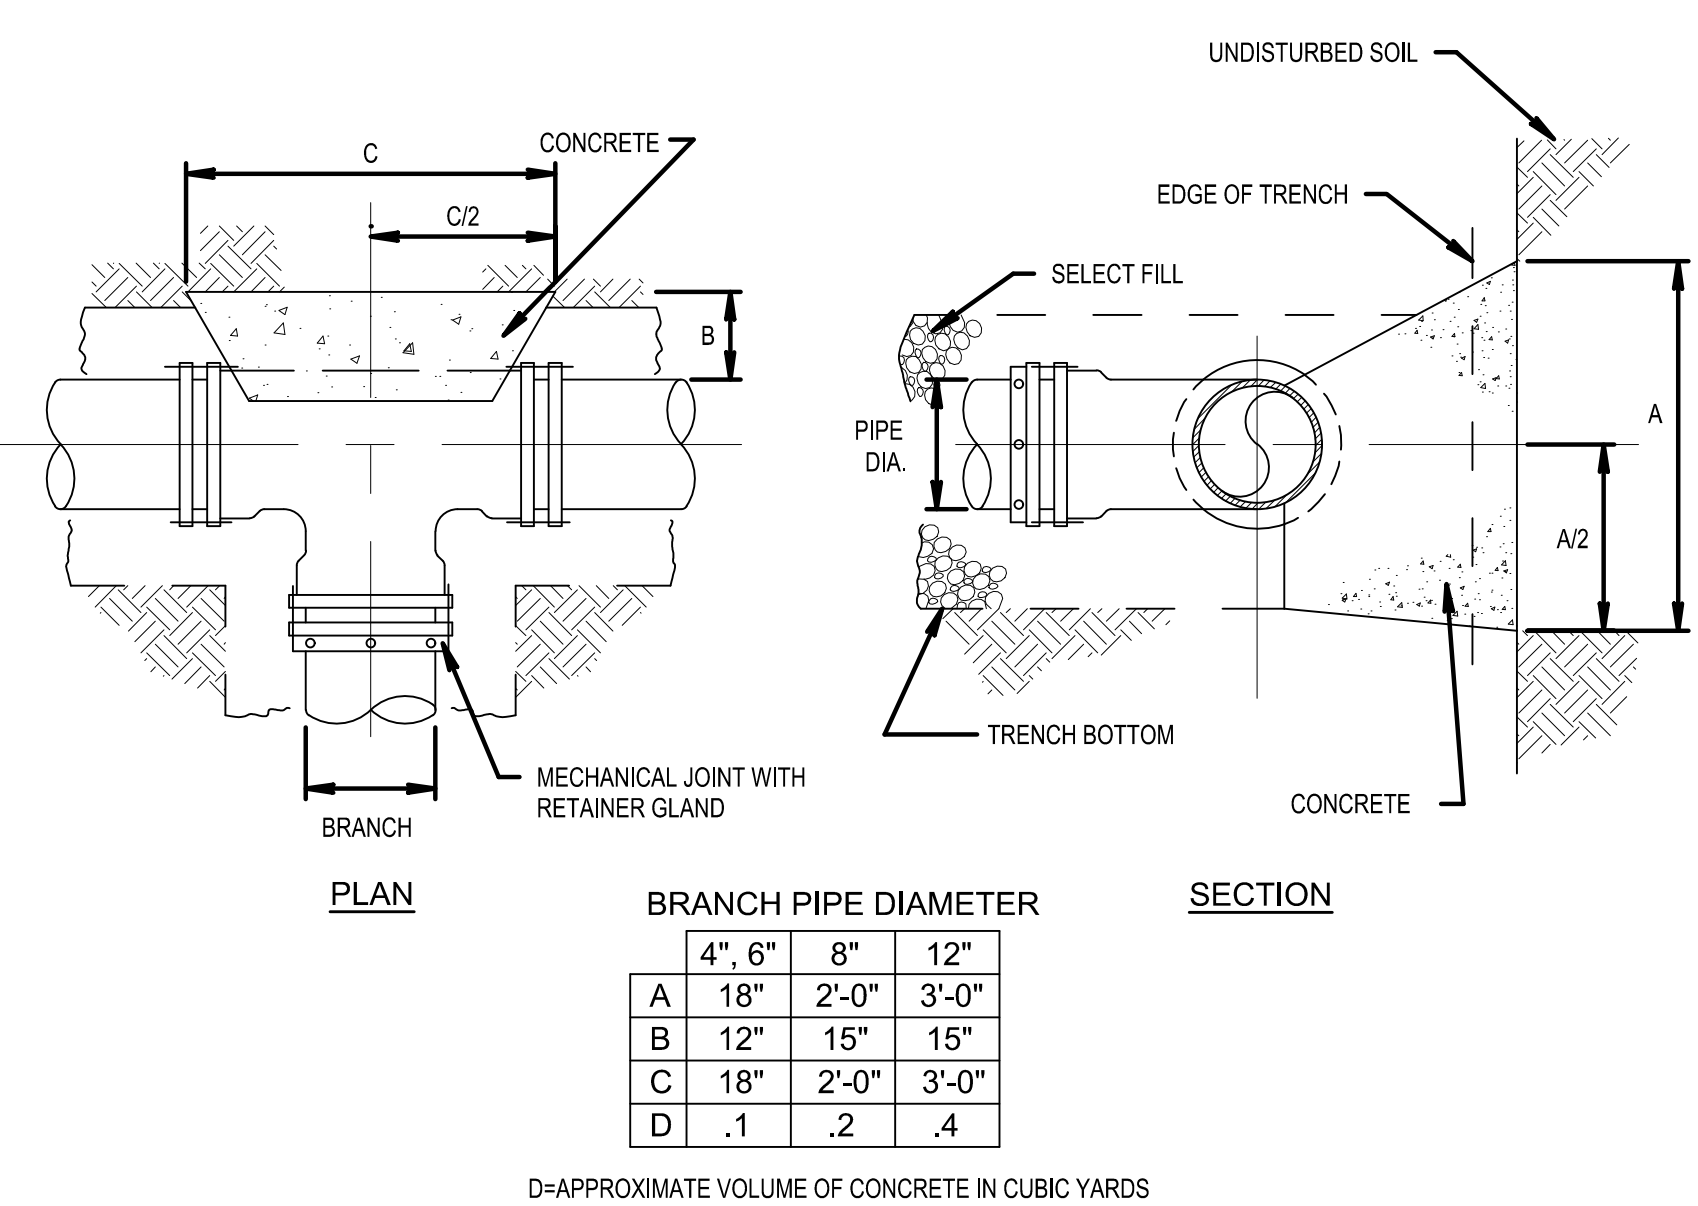

3 CONCRETE ANCHORS FOR TEES
NOT TO SCALE

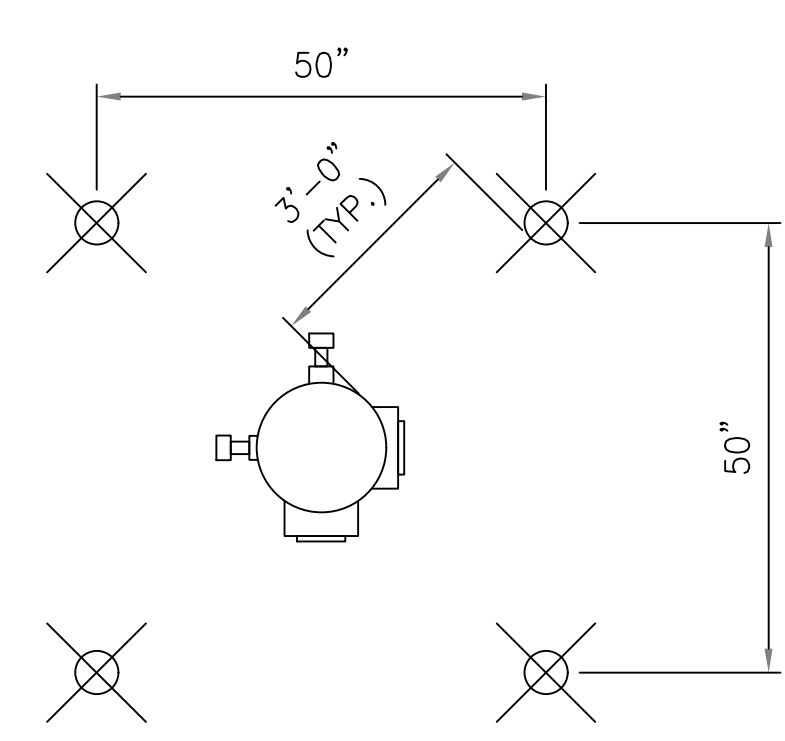

1 PIPE BOLLARD PLAN VIEW
NOT TO SCALE


5 HYDRANT DETAIL
NOT TO SCALE

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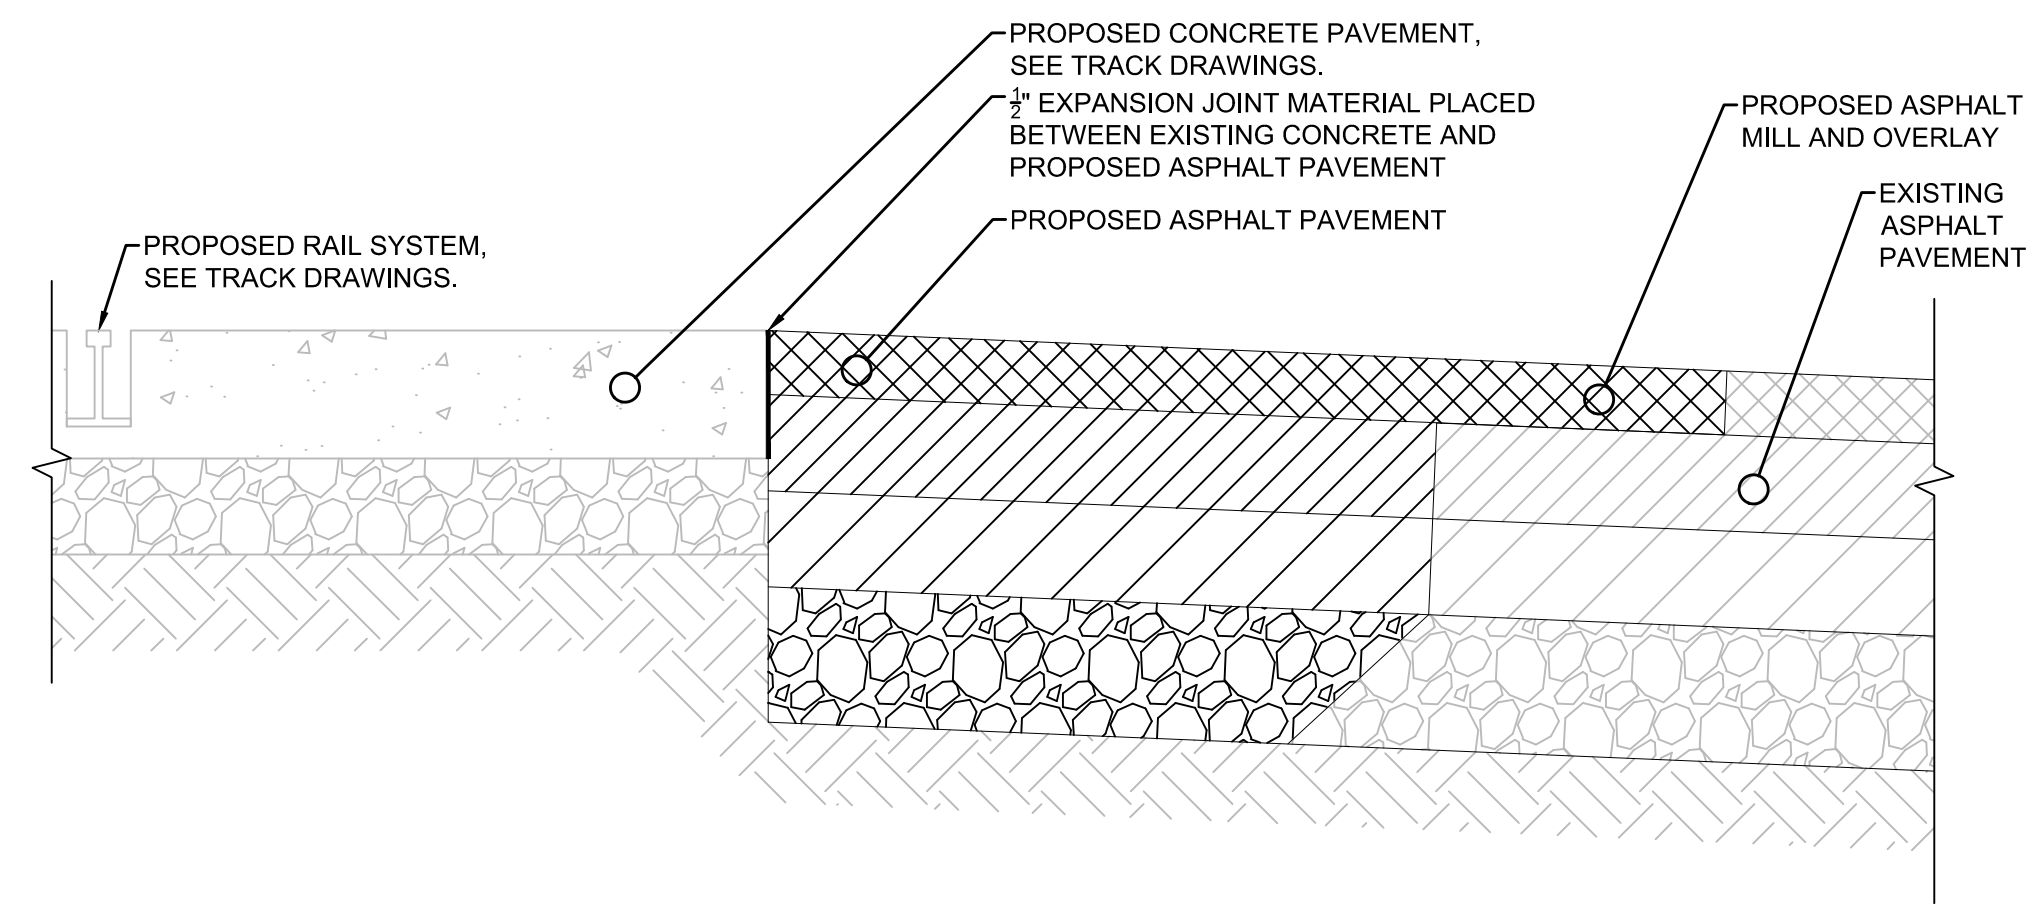
LOCATION: CAMDEN, NJ
TITLE: SJPC BALZANO MARINE TERMINAL RAIL INFRASTRUCTURE REHABILITATION PROPOSED SITE DETAILS 2
NO. GE50867
DATE: 06/24/2022
DRAWING NUMBER: C-502

REV	BY	DATE	DESCRIPTION




NOTES:
 1.) SAW CUT AND MILL 18" MIN. OF EXISTING ASPHALT. TIE INTO EXISTING PATH BY OVERLAY OF WEARING COURSE ONTO EXISTING ASPHALT.

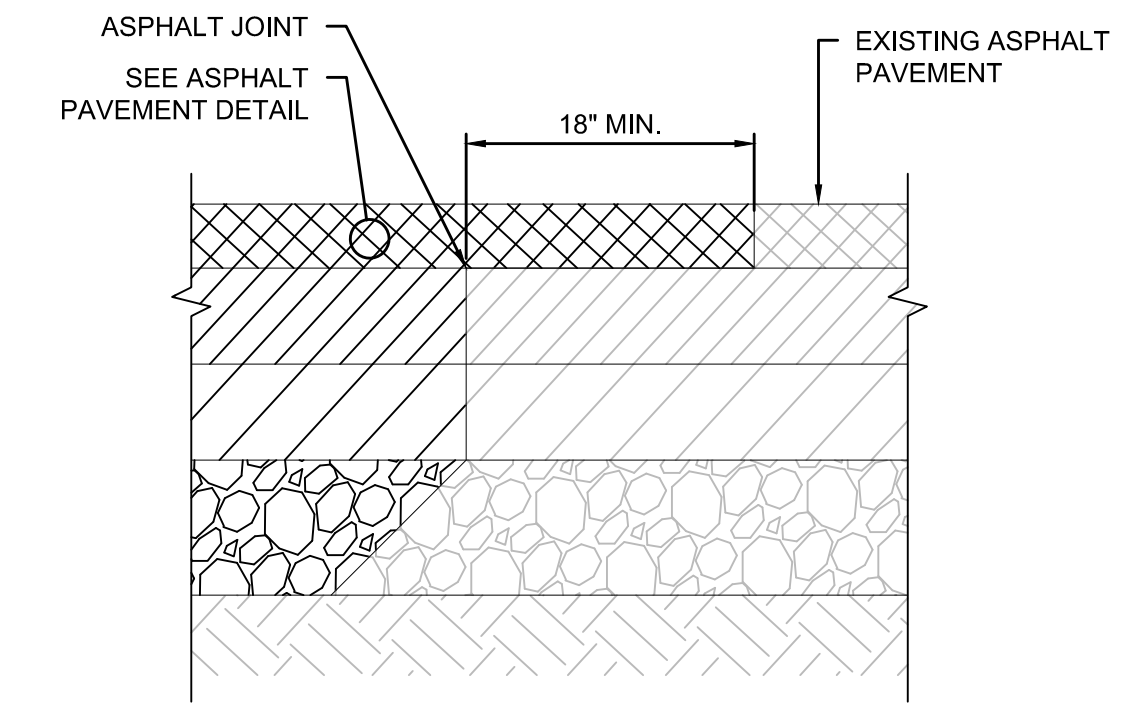2 ASPHALT MILL AND OVERLAY
 NOT TO SCALE




3 TYPICAL PAVEMENT SECTION
 NOT TO SCALE

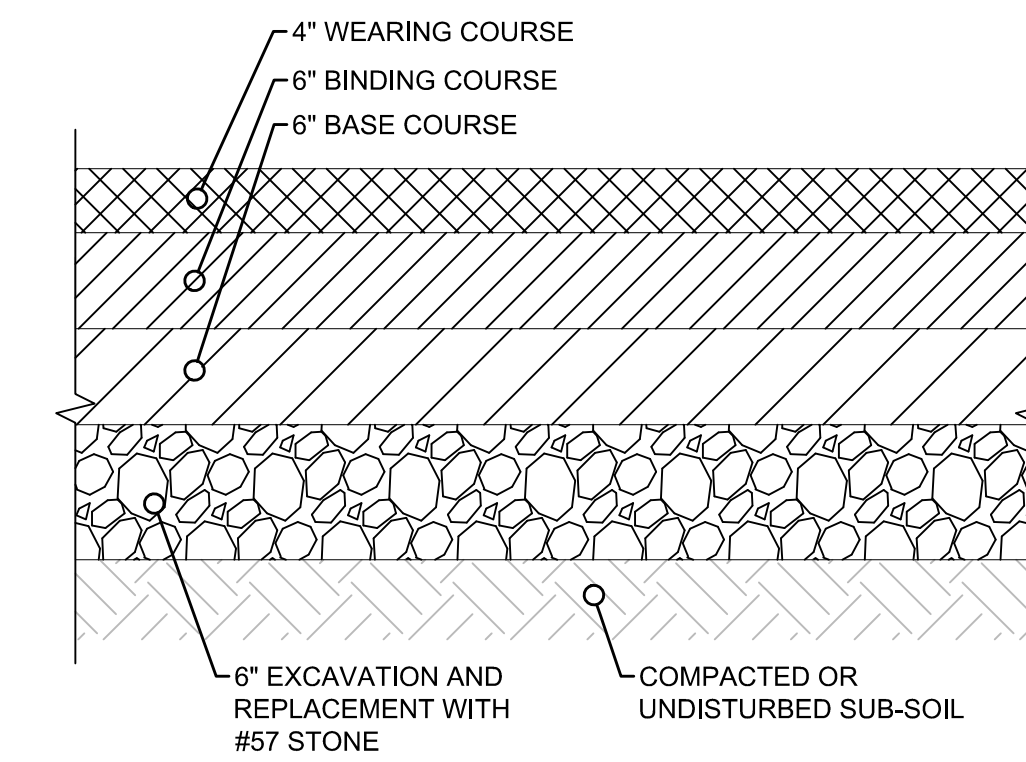

1 ASPHALT PAVEMENT
 NOT TO SCALE

REV	BY	DATE	DESCRIPTION

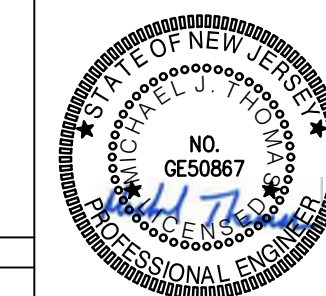

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LOCATION: **CAMDEN, NJ**

TITLE: **SJPC BALZANO MARINE TERMINAL RAIL INFRASTRUCTURE REHABILITATION PROPOSED SITE DETAILS 3**

DWN: GJB PROJ # 2021500064.000 DRAWING NUMBER: **C-503**
 CHR: MJT DATE 06/24/2022

GENERAL NOTES:

1. Building Code, Design Reference Codes & Standards
 - 1.1. International Building Code (IBC) 2018
 - 1.2. AISC Manual of Steel Construction - 15th Edition - ASD
 - 1.3. AWS Structural Welding Code D1.4
 - 1.4. Building Code Requirements for Reinforced Concrete - ACI 318-14
 - 1.5. Building Code Requirements for Masonry Structures - TMS 402-16
 - 1.6. Minimum Design Loads for Buildings and Other Structures - ASCE 7-16
2. Design Loads
 - 2.1. Design Live Loads

2.1.1. Floor Live Loads	150 psf
2.1.2. Roof Live Load (min)	20 psf
 - 2.2. Design Roof Snow Load (ASCE 7-16)

2.2.1. Ground Snow Load	Pg=25 psf
2.2.2. Flat-Roof Snow Load	Pt=21 psf
2.2.3. Snow exposure factor	Ce=1.0
2.2.4. Importance factor	I=1.0
2.2.5. Thermal factor	Ct=1.2 (Canopy)
 - 2.3. Design Wind Loads (ASCE 7-16)
 - 2.3.1. General

2.3.1.1. Basic Wind Speed	V=112 mph (Ultimate)
2.3.1.2. Risk Category	II
2.3.1.3. Exposure Category	C
 - 2.4. Design Seismic Loads (ASCE 7-10)
 - 2.4.1. Importance Factor
 Ie=1.0 |
 - 2.4.2. Risk Category
 II |
 - 2.4.3. Mapped Spectral Response Acceleration
 Ss=0.179g |
 - 2.4.4. Mapped Spectral Response Acceleration
 SI=0.047g |
 - 2.4.5. Site Class (assumed soil characteristics)
 D |
 - 2.4.6. Spectral Response Coefficient
 SDs=0.191g |
 - 2.4.7. Spectral Response Coefficient
 SD1=0.075g |
 - 2.4.8. Seismic Design Category
 B |
3. Material Properties
 - 3.1. Concrete minimum compressive strength (28 days)

3.1.1. Maximum water/cement ratio	w/c=0.40 max.
3.1.2. Slump	3" +/- 1"
 - 3.2. Reinforcing bars (ASTM A615 Gr 60)

3.3. Welded wire reinforcement (ASTM A1064)	fy=60 ksi
3.4. Non-composite deck (ASTM A653)	fy=33 ksi
3.5. Composite deck (ASTM A653)	fy=33 ksi
3.6. Structural steel W/S Shapes (ASTM A992)	fy=50 ksi
3.7. Structural steel other shapes (ASTM A36)	fy=36 ksi
3.8. Structural steel tubes (ASTM A500 Gr C)	fy=50 ksi
3.9. Structural steel pipe (ASTM A53 Gr B or A501)	fy=35 ksi
3.10. Masonry (ASTM C90)	fm=1,500 psi
3.11. Masonry units, Type S (N) mortar	1,900 psi (2,150 psi)
3.12. Masonry grout (ASTM C1019)	2,000 psi
4. Soil Properties
 - 4.1. Net Allowable Bearing Pressure - Shallow (virgin soil)


4.2. Net Allowable Bearing Pressure - Shallow (engineered fill)	1500 psf
4.3. Unit weight of fill	120 pcf
4.4. Active pressure Coefficient	Ka=0.33
4.5. Pressure at Rest Coefficient	Ko=0.5
4.6. Friction	f=0.3
5. General
 - 5.1. The Contractor shall verify all dimensions in the field prior to commencing any work. The Engineer shall be notified of any discrepancies.
 - 5.2. Any discrepancies between the architectural and structural drawings shall be brought to the attention of the Architect and Structural Engineer for resolution prior to commencing work.
 - 5.3. Shop drawings must be checked and stamped by the Contractor prior to submission. Drawings not first reviewed and approved by the Contractor will be returned with no action taken.
6. Foundations
 - 6.1. Existing foundations
 - 6.1.1. Existing foundations shown on drawings are approximate - exact size and location must be verified during construction.
 - 6.1.2. Unless otherwise noted, the bottom of new footings shall match the bottom of existing footing elevation.
 - 6.2. Locate existing underground utilities in areas of construction before you dig. Coordinate with utility companies for shut off requirements of active lines.
 - 6.3. Contractor shall protect all excavations, including structures which may be involved, with proper safeguards including bracing and shoring as necessary.
7. Concrete
 - 7.1. All concrete construction shall be in accordance with ACI 318 - *Building Code Requirement for Reinforced Concrete*, the *ACI Detailing Manual* and *Project Specifications Section 033000 Cast-In-Place Concrete*. See Section 1 for governing editions.
 - 7.2. Provide sloped concrete floor surfaces in accordance with ADA code requirements.
 - 7.3. Provide shop drawings which indicate size, spacing, and bend details of all reinforcing.
 - 7.4. Furnish bar and wire mesh supports and chairs where necessary to hold reinforcing in place.
 - 7.5. Welding of reinforcing bars or mesh is not permitted without approval from Structural Engineer.
 - 7.6. Reinforcing for slabs on grade shall be as shown on plans. All reinforcing shall be supported on chairs to maintain position during concrete placement, unless noted otherwise.
 - 7.7. Length of reinforcing splices shall conform to ACI Building code requirements. All reinforcing steel lap splices not detailed on drawings shall be Class B tension splices unless noted otherwise. Where embedment length is not shown use ACI tension development length. All bends or hooks shown shall be ACI standard, unless noted otherwise.
 - 7.8. Contractor has the option to use mechanical splices in place of lap splices. Mechanical splices type and location shall be submitted to engineer for approval.
8. Structural Steel
 - 8.1. All structural steel shall be fabricated and installed in accordance with Project Specifications Section 05 12 00 Structural Steel Framing. All steel detailing, fabrication and erection in accordance with *AISC Specifications and Code of Standard Practice* and the *AWS Structural Welding Code*. See Section 1 for governing edition.
 - 8.2. Fabricator shall be AISC quality certified.
 - 8.3. Shop drawings are required and shall note type of electrodes, size of all welds, and type/size of all bolts. Shop drawings shall be prepared under the supervision of a registered professional engineer.
 - 8.4. Calculations for all moment connections and any non-standard shear connections (i.e., skewed, extended or any other connection when designated by the engineer of record) shall be submitted with their corresponding fabrication drawing. Calculations to be sealed by a professional engineer registered in the New Jersey.
 - 8.5. Connections - high strength bolted:
 - 8.5.1. A325-SC with hardened washers for all moment connections, hangers and other connections as noted on the drawings. All slip critical bolting (shop & field) to be inspected by a qualified testing laboratory approved by the Architect/Structural Engineer.
 - 8.5.2. A325-N with hardened washers for all other connections.
 - 8.5.3. Use standard holes unless noted otherwise.
 - 8.5.4. Where reaction is noted, develop same. Where not noted, provide minimum number of bolts per schedule.
 - 8.6. Connections - welded:
 - 8.6.1. Welding electrodes shall be E70xx unless other is required for compatibility with base metal.
 - 8.6.2. A currently certified welder shall perform all welding.
 - 8.6.3. Do not weld to existing steel without approval from Structural Engineer.
 - 8.6.4. All welding (shop & field) to be inspected by a qualified testing laboratory approved by the Architect/Structural Engineer.

- 8.7. Painting - see specifications.
- 8.8. Beams bearing on masonry shall have angle wall anchors and bear a minimum of 6" into the wall. Masonry shall be built tightly around the beam.
- 8.9. Miscellaneous hanging loads shall be applied so that no torsional loading is induced.
- 8.10. Steel supplier to provide all deck support angles (as required for steel deck) for such cases as changes in joist direction, roof elevation changes, at the ends of each joist, etc.
- 8.11. The steel supplier shall include an additional 5% of the total contract (deck & red iron) in the bid for miscellaneous use in site conditions.
- 8.12. Weld masonry anchors (provided by mason) to structural members where masonry abuts or faces structural members on 16" c/c both horizontally and vertically.
9. Steel Deck
 - 9.1. Deck detailing, fabrication and erection in accordance with *SDI Manual of Construction with Steel Deck*. See Section 1 for governing edition.
 - 9.2. Shop drawings are required and shall note type of electrodes, size of all welds and type/size of all fasteners. Shop drawings shall be prepared under the supervision of a registered professional engineer.
 - 9.3. All metal decks shall be securely fastened (welded, screwed or powder-actuated pinned) to steel supports per SDI specifications.
 - 9.4. Provide deck continuous over at least 3 supports and weld to supports as indicated on plans. Limit deflection to L/240 when loaded with wet concrete and provide shoring as required by the Steel Deck Institute.
10. Special Inspection - Structural
 - 10.1. The owner will retain an approved independent testing laboratory that shall provide inspections and testing per ASTM E329. Reports of inspection and testing shall be sent to Architect and Engineer within 48 hours of testing.
 - 10.2. Continuous Inspection -- Contractor shall notify inspection agency and architect prior to work requiring continuous inspection -- any work completed without inspector present shall be removed and replaced at the contractors expense.
 - 10.3. Periodic Inspection -- Contractor shall notify inspection agency and architect when work is ready for inspection. Any work that subsequently hides work to be inspected shall be removed and replaced at the contractors expense.
 - 10.4. Materials Testing -- Contractor shall employ a testing and inspection agency to perform materials testing as required by the Special Inspector.
 - 10.5. Special Inspection Testing shall include:
 - 10.5.1. Concrete: mix data, daily pour reports, cylinder tests, slump, entrained air tests, temperature, etc. per IBC 2018 Section 1705.3 and Table 1705.3.
 - 10.5.2. Structural Steel: Per IBC 2018 Section 1705.2 and AISC 360-16 Section N5.
 - 10.5.3. Cold Formed Steel Deck: Per IBC 2018 Section 1705.2.2.
 - 10.5.4. Masonry: Per IBC 2018 Section 1705.4 and the quality assurance program requirements of TMS 402.
 - 10.5.5. Soils: Per IBC 2018 Section 1705.6 and Table 1705.6.
 - 10.5.6. Foundations: Per IBC 2018 Sections 1705.7-1705.9 and Tables 1705.7 & 1705.8.
 - 10.5.7. Special Inspections for Wind Resistance: Per IBC 2018, Section 1705.11.
 - 10.5.8. Special Inspections for Seismic Resistance: Per IBC 2018, Section 1705.12.


STRUCTURAL ABBREVIATIONS & SYMBOLS

ATOR	ABOVE TOP OF RAIL	OC	ON CENTER
BLDG.	BUILDING	OF	OUTSIDE FACE
BM.	BEAM	PEB	PRE-ENGINEERED BUILDING
BOT.	BOTTOM	PG	PLATE GIRDER
B/S	BOTTOM OF STEEL	PJF	PERFORMED JOINT FILLER
BRGG.	BRACING	PROV.	PROVIDE
CCJ	CRACK CONTROL JOINT	REINF.	REINFORCEMENT/REINFORCING
CJ	CONSTRUCTION JOINT	SC	SLIP CRITICAL CONNECTION
CTJ	CONTRACTION JOINT	SLV	SHORT LEG VERTICAL
COL.	COLUMN	STIFF.	STIFFENER
CONC.	CONCRETE	STL	STEEL
CONN.	CONNECTION	T&S	TEMPERATURE AND SHRINKAGE
CONT.	CONTINUOUS	THK	THICK
CONTR.	CONTRACTOR	T/S	TOP OF STEEL
CWR	CONTINUOUS WELDED RAIL	T/C	TOP OF CONCRETE
DET.	DETAIL	T/	TOP OF
DIA.	DIAMETER	T	TOP
DWL.	DOWEL	TYP	TYPICAL
DN.	DOWN	UNO	UNLESS NOTED OTHERWISE
DWG.	DRAWING	WHWR	WELDED WIRE REINFORCING
EA	EACH	W/	WITH
EF	EACH FACE	W/O	WITHOUT
EW	EACH WAY	↙	SLOPE DOWN
EL.	ELEVATION	↔	SPAN OR REINFORCING STEEL DIRECTION
EJ	EXPANSION JOINT	⊕	CENTER LINE
FF	FINISHED FLOOR	⊙	AT
FDN.	FOUNDATION	⊗	PLATE
FRP	FIBERGLASS REINFORCED PLASTIC	⊙	COLUMN LINE
FS	FAR SIDE	⊗	OPENING
GALV.	GALVANIZED	⊙	SECTION OR DETAIL NUMBER
GB	GRADE BEAM	⊗	DRAWING ON WHICH DETAIL IS LOCATED
HGR.	HANGER	⊕	TOP OF CONCRETE SPOT ELEVATION
HORIZ.	HORIZONTAL		
HP	HIGH POINT		
K	KIPS		
LB.	POUND		
LDCC	LOW DENSITY CONCRETE MATERIAL		
LLV	LONG LEG VERTICAL		
LP	LOW POINT		
MAX.	MAXIMUM		
M.B.M.	METAL BUILDING MANUFACTURER		
MIN.	MINIMUM		
N.A.	NEUTRAL AXIS		
NS	NEAR SIDE		
N.T.S.	NOT TO SCALE		


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	LOCATION: CAMDEN, NJ TITLE: SJPC BALZANO MARINE TERMINAL RAIL INFRASTRUCTURE REHABILITATION GENERAL STRUCTURAL NOTES
DWN: FYC PROJ #: 2021500064.000 DRAWING NUMBER: S-001 CHK: MGW DATE: 06/24/2022	

REV	BY	DATE	DESCRIPTION

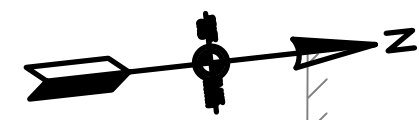

TRANSIT SHED #1

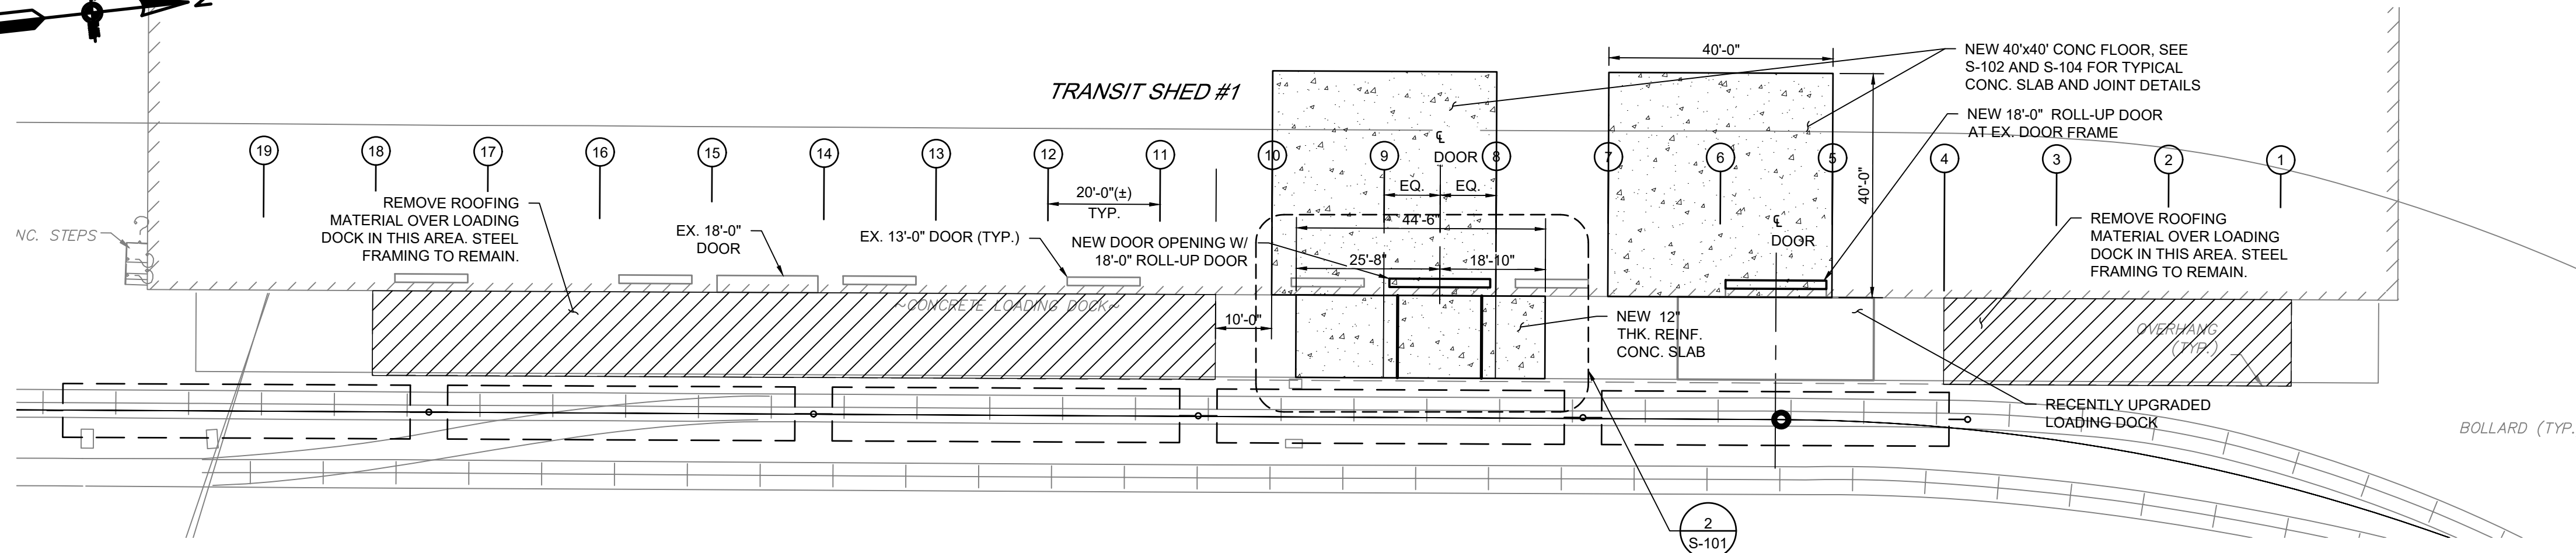


1 LOADING DOCK PLAN AT SHED #1
Scale: 1" = 20'-0"
GRAPHIC SCALE

NOTES


- SEE STRUCTURAL GENERAL NOTES SHEET S-000.

LEGEND

- NEW 18'-0" ROLL-UP DOOR
- EX DOOR (ACCESSIBLE OR NON-ACCESSIBLE)
- 60' BOX CAR
- NEW LOADING DOCK
- DEMOLITION

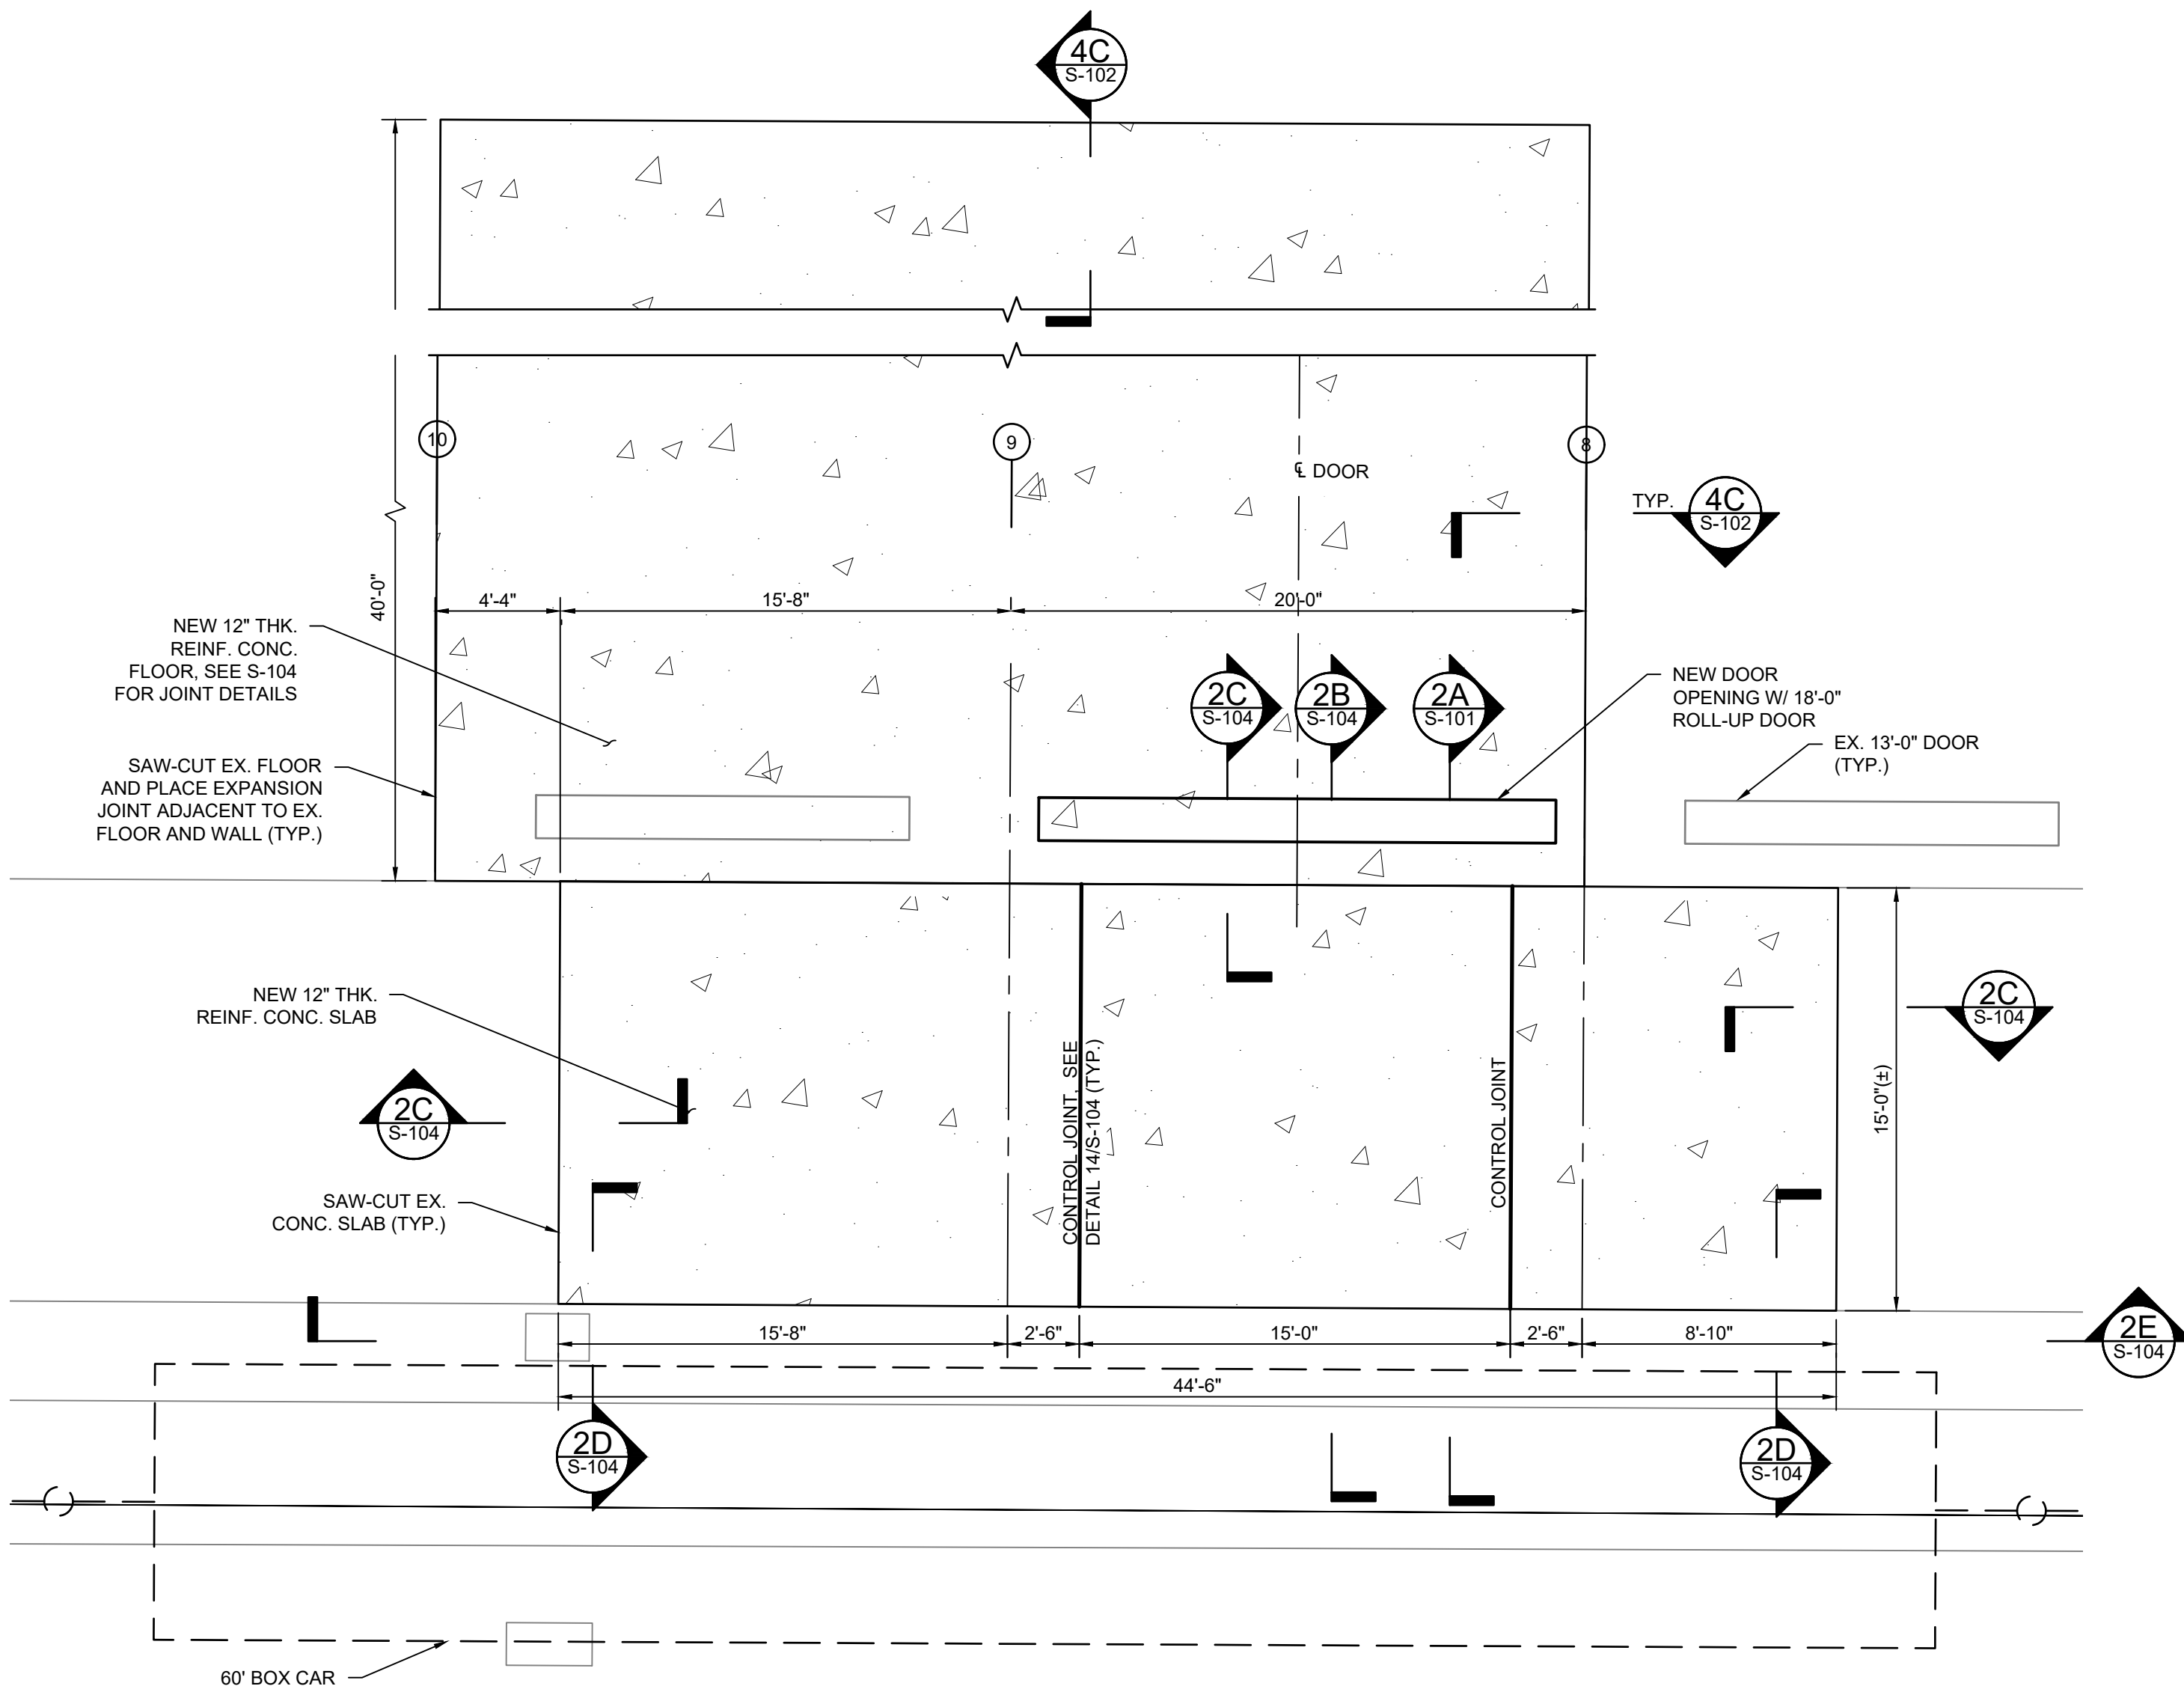


2 LOADING DOCK PLAN
Scale: 1" = 5'-0"
GRAPHIC SCALE

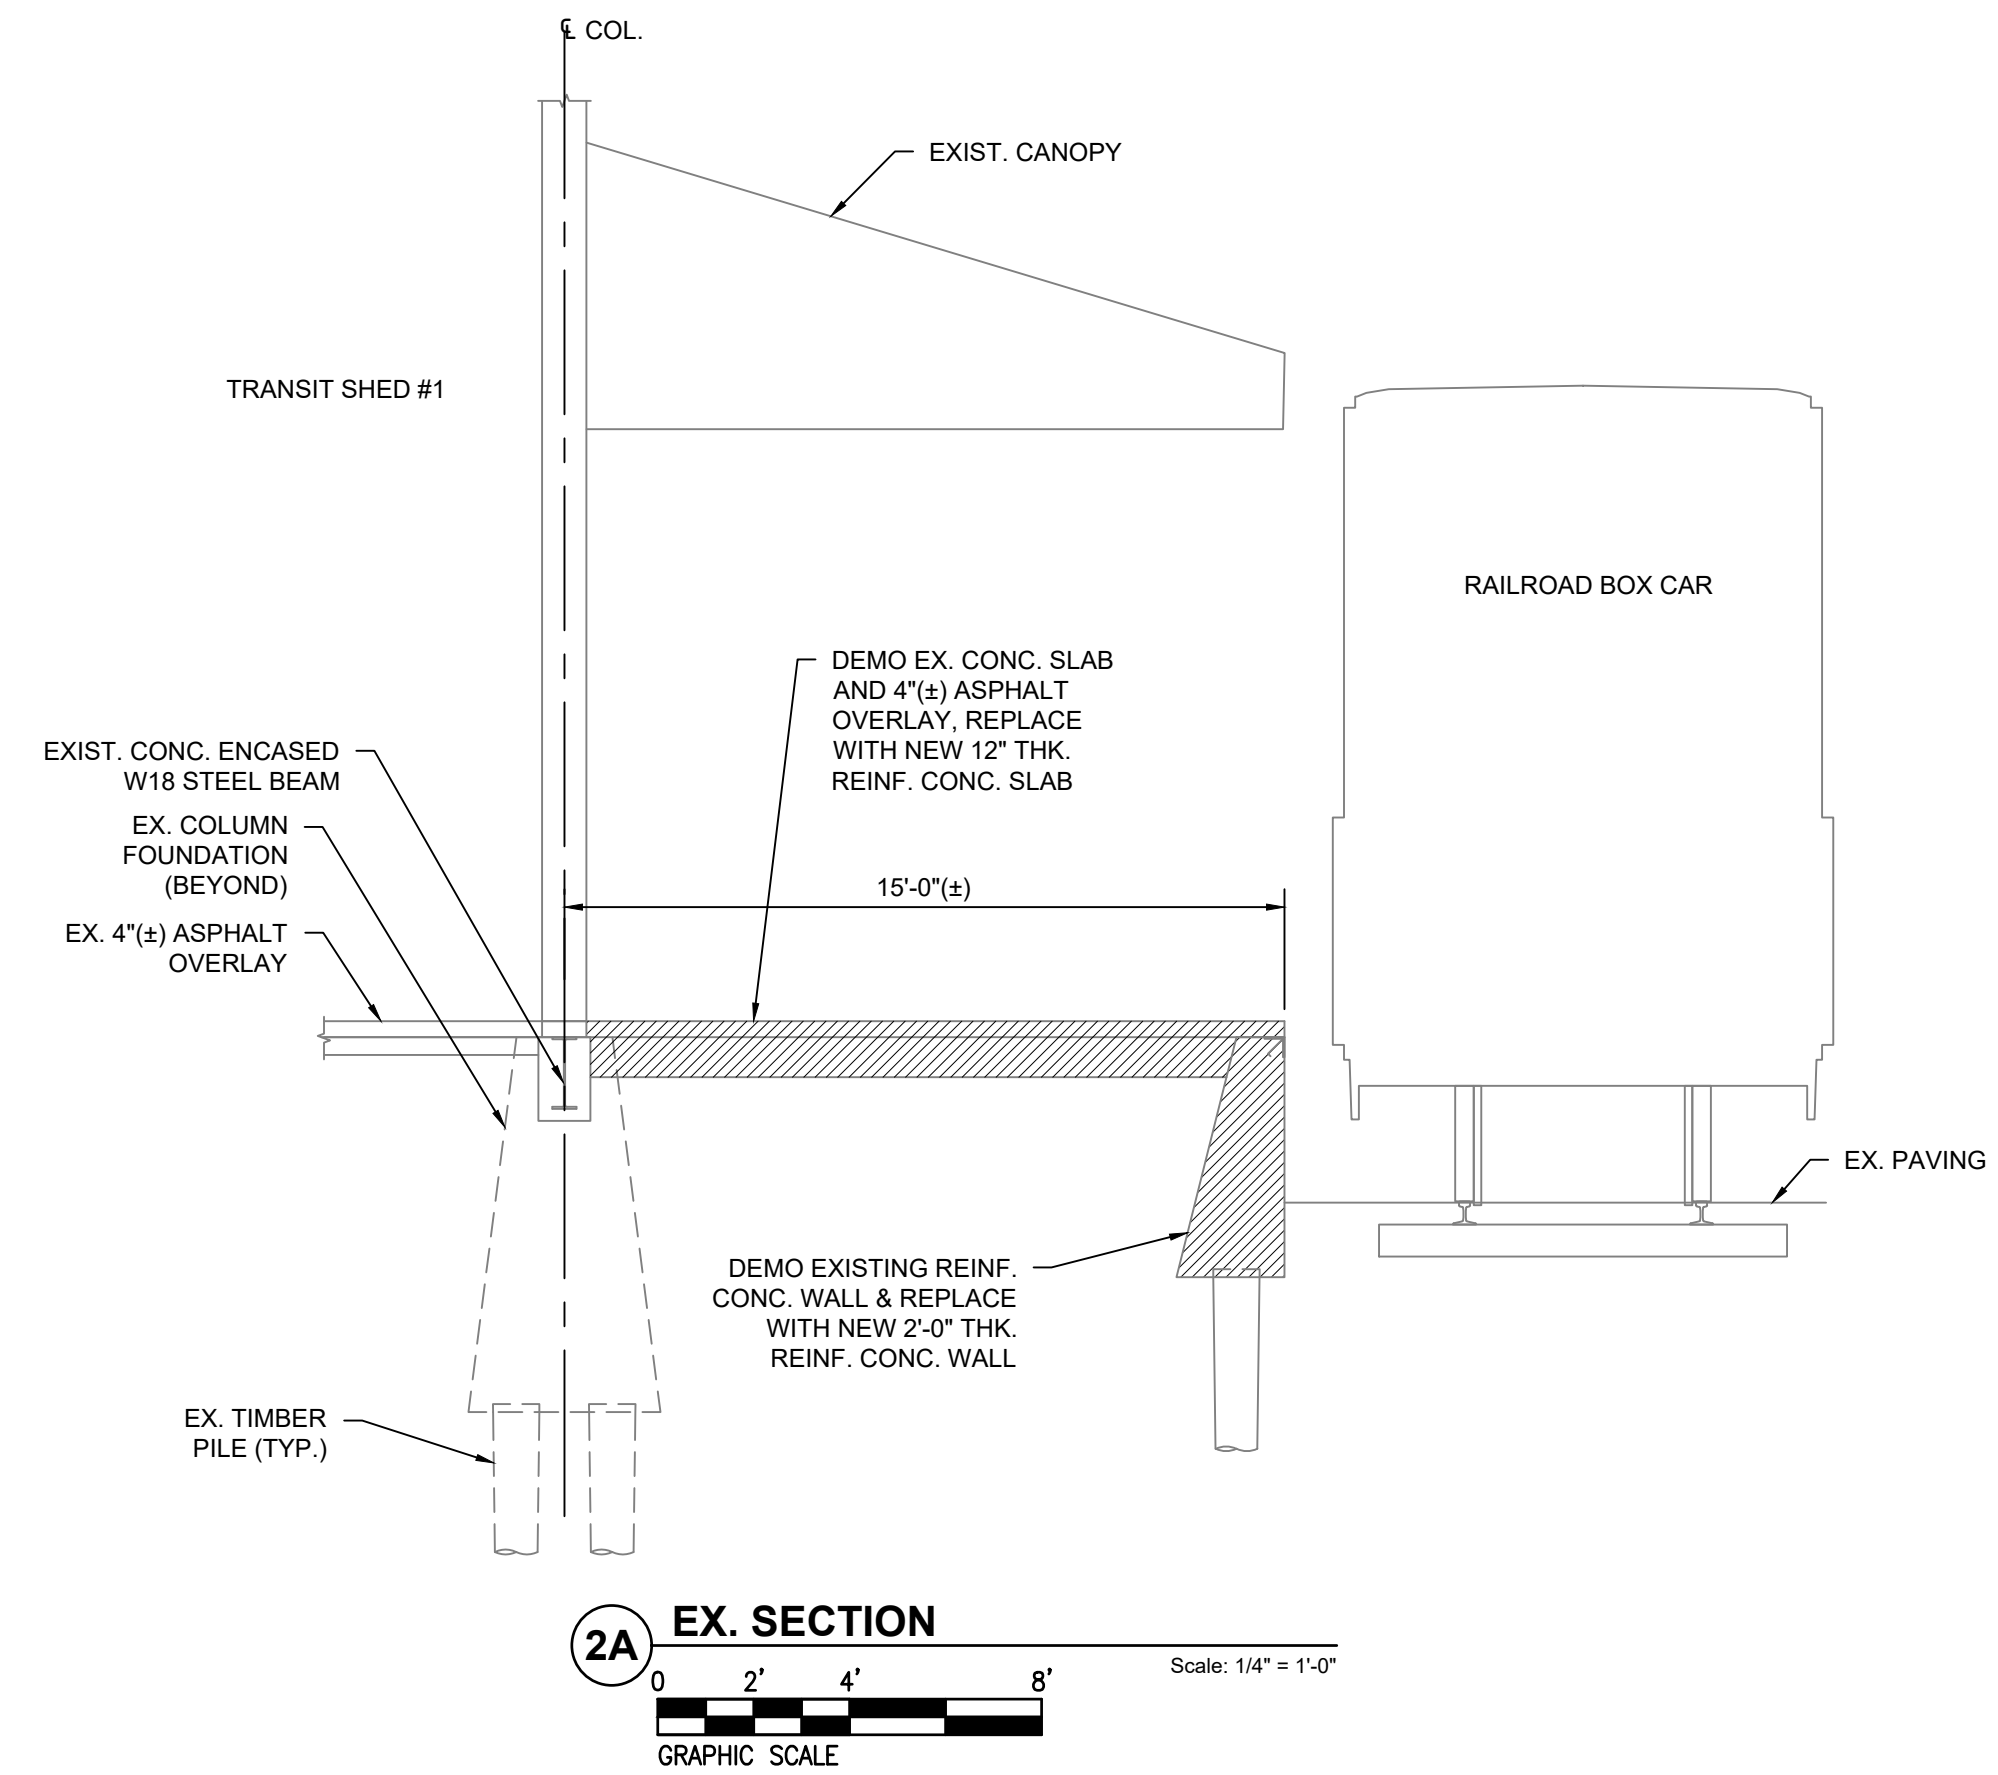

2A EX. SECTION
Scale: 1/4" = 1'-0"
GRAPHIC SCALE

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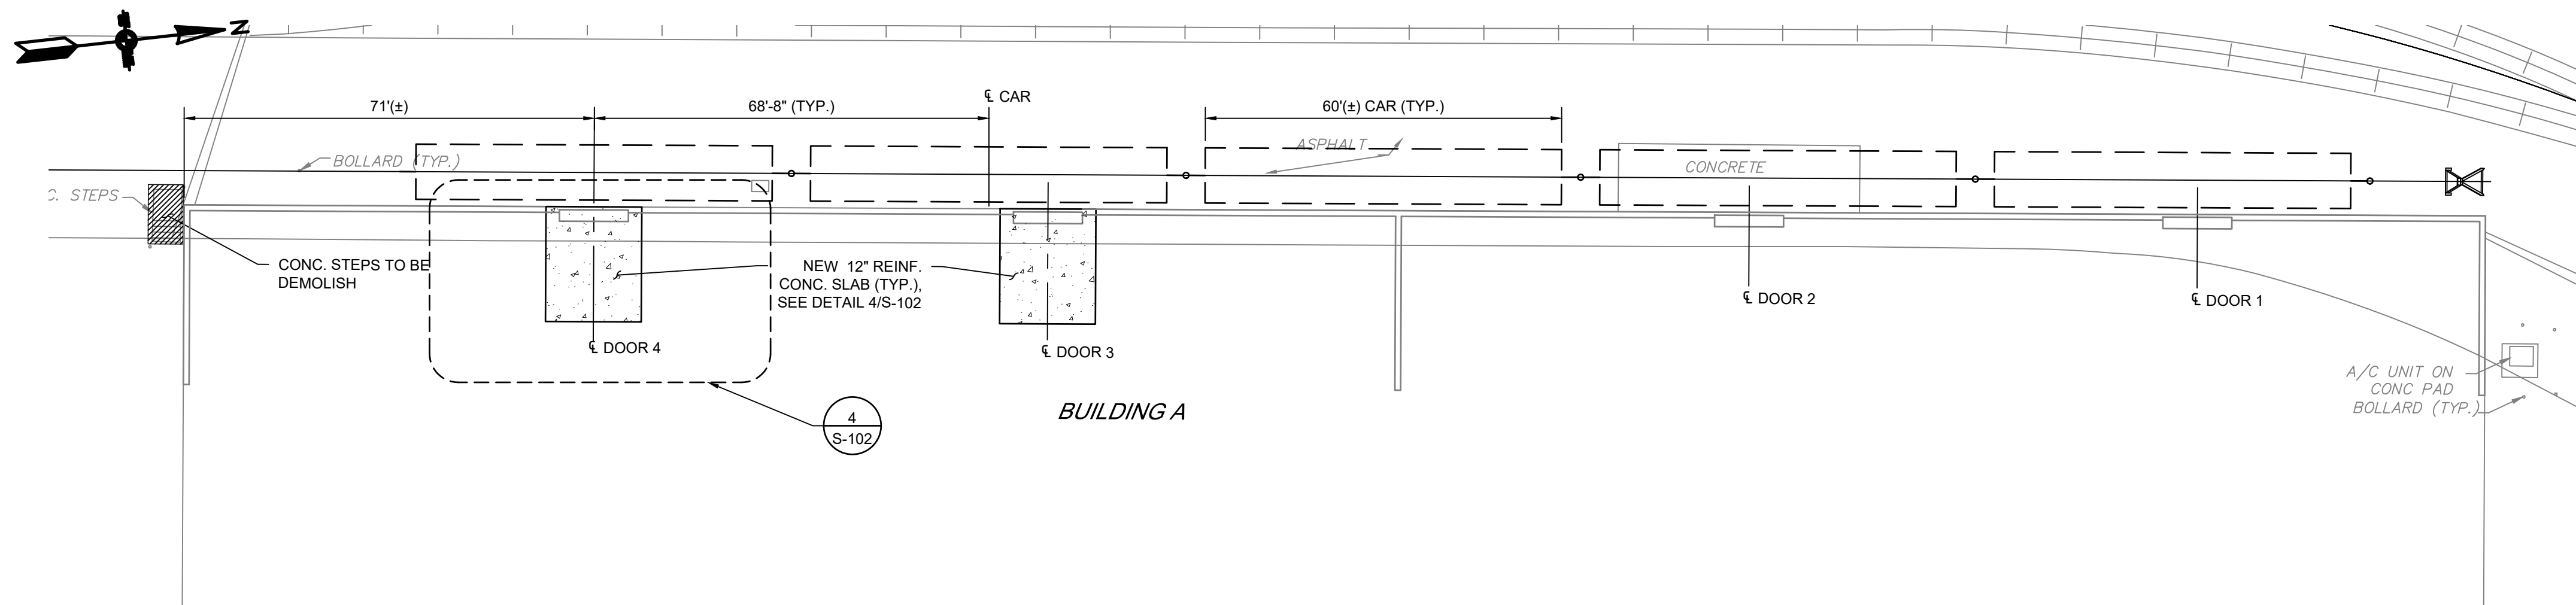


LOCATION: **CAMDEN, NJ**

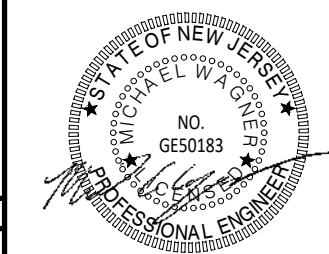TITLE: **SJPC BALZANO MARINE TERMINAL RAIL INFRASTRUCTURE REHABILITATION LOADING DOCK PLAN AT SHED 1 - PLAN AND SECTION**

OWN: **FYC** PROJ #: **2021500064.000** DRAWING NUMBER: **S-101**
CHK: **MGW** DATE: **06/24/2022**

REV	BY	DATE	DESCRIPTION




NOTES

- SEE STRUCTURAL GENERAL NOTES SHEET S-000.
- ALL WORK ON THIS SHEET ASSOCIATED WITH ADD ALTERNATE #1.



LEGEND

- NEW 18'-0" ROLL-UP DOOR
- EX DOOR (ACCESSIBLE OR NON-ACCESSIBLE)
- 60' BOX CAR
- NEW LOADING DOCK
- DEMOLITION



3 CONC. SLAB PLAN AT BUILDING A

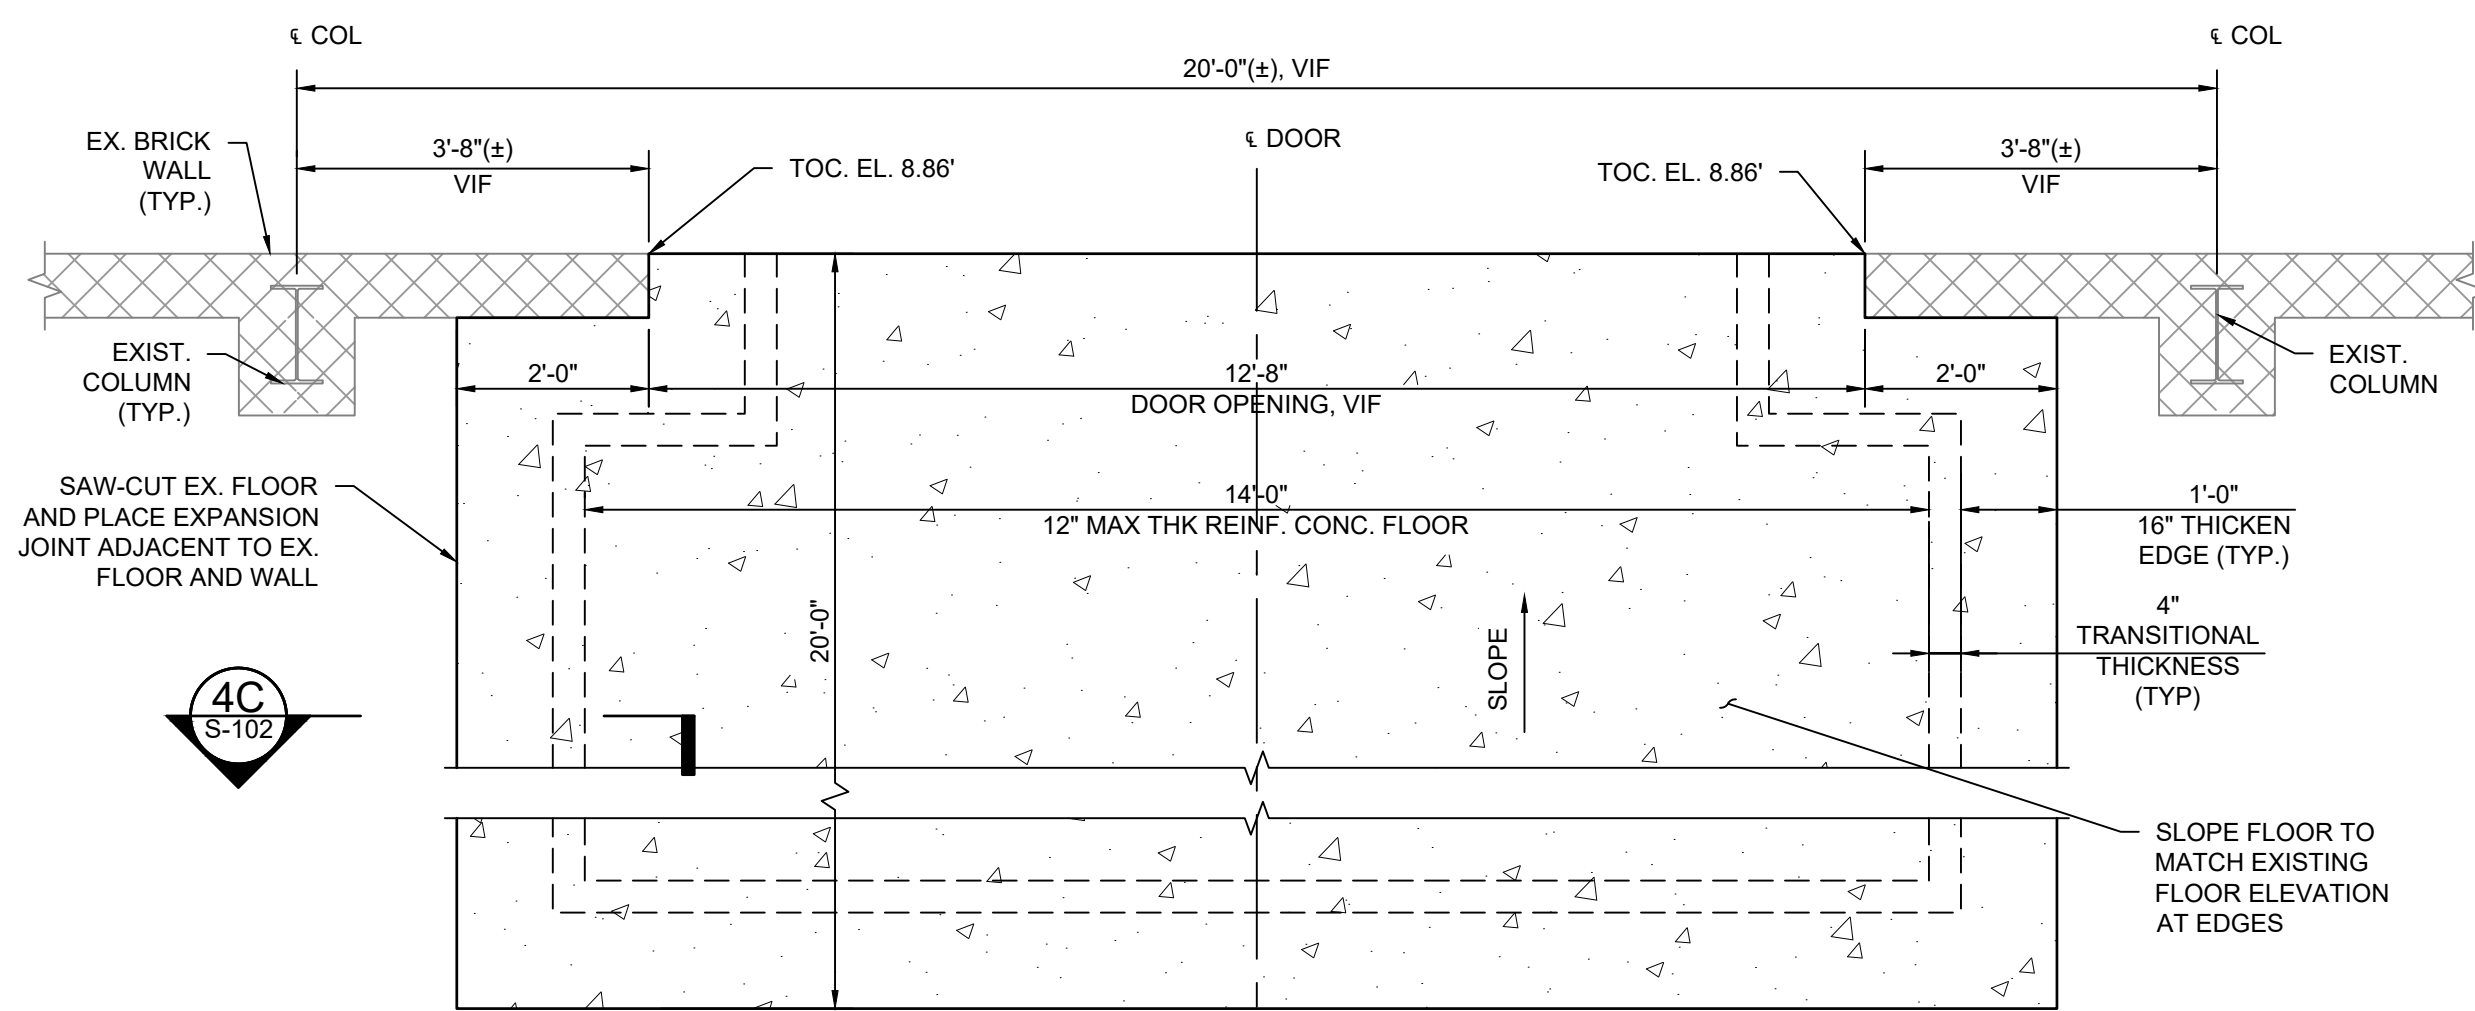



4 TYP. CONC. SLAB PLAN

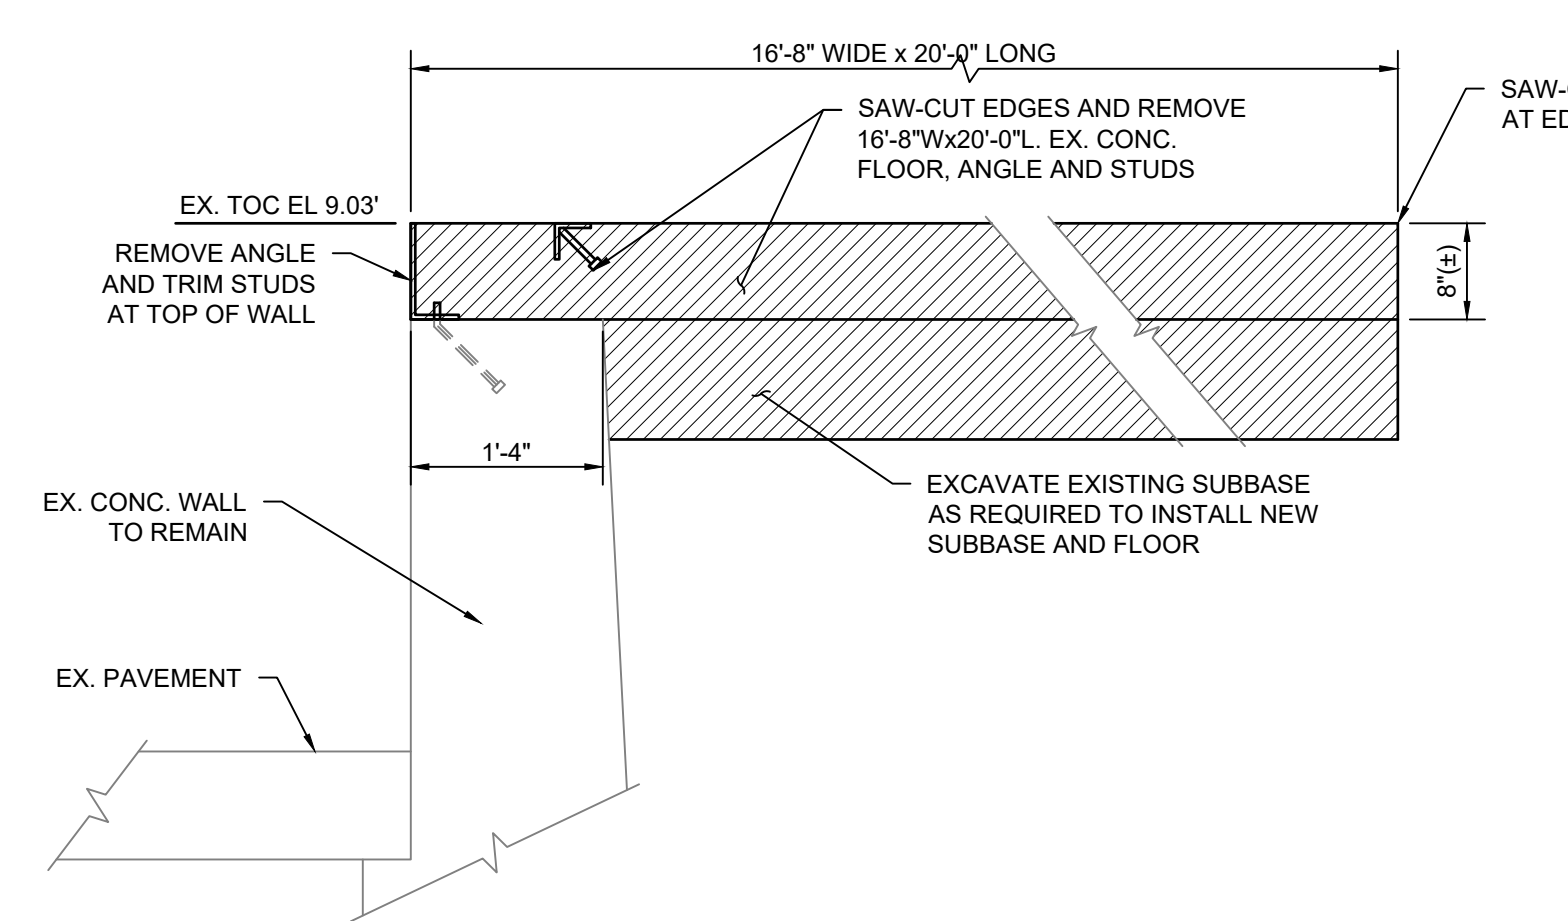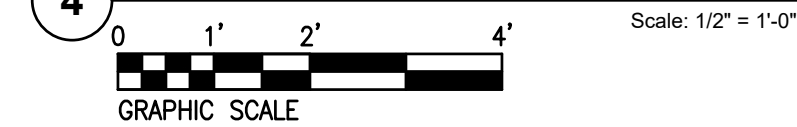


4A EX. SECTION & DEMOLITION

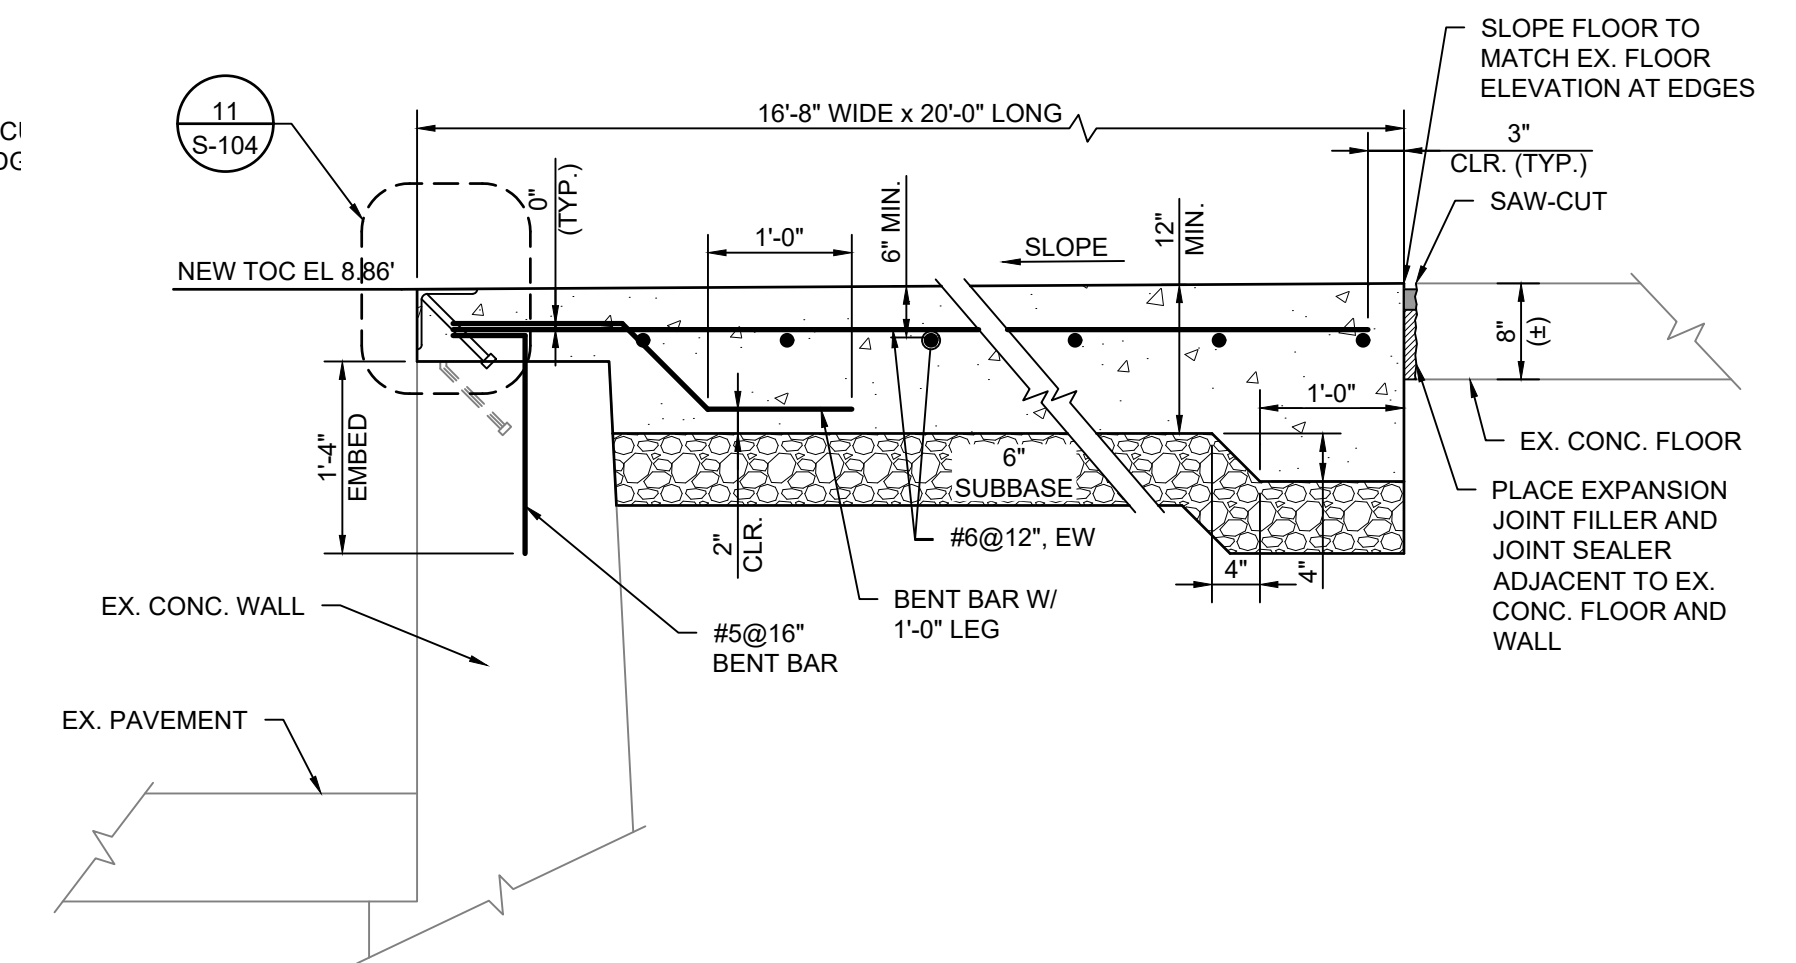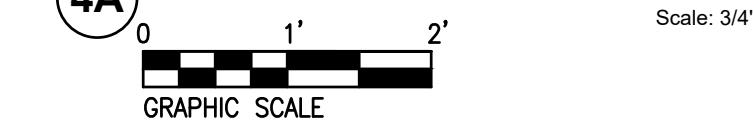

4B NEW REINF. CONC SLAB SECTION

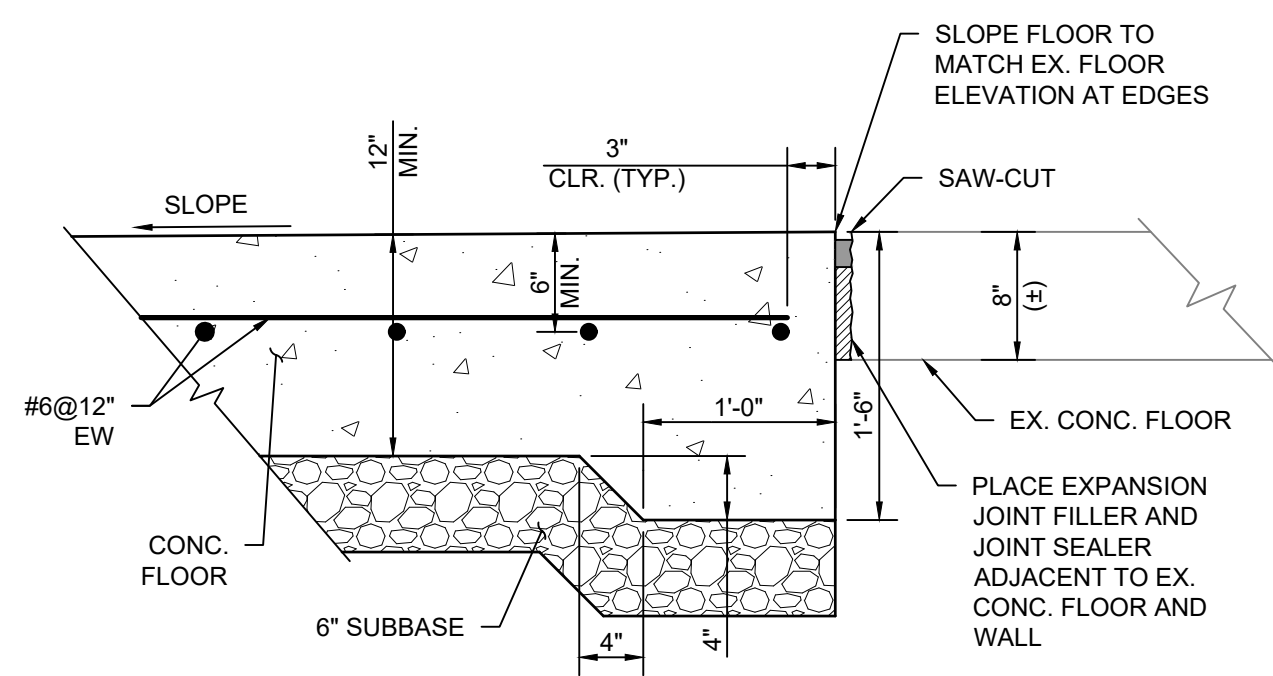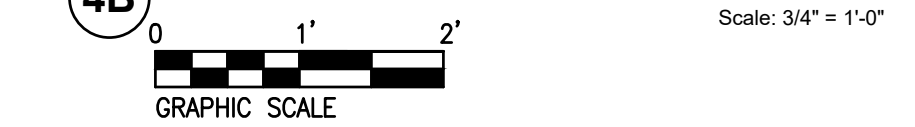

4C TYP. THICKEN EDGE DETAIL

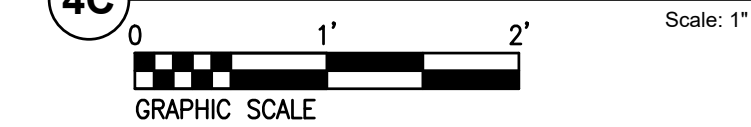


REV	BY	DATE	DESCRIPTION

ISSUED FOR BID

URBAN ENGINEERS, INC.
 530 Walnut Street
 Philadelphia, PA 19106
 (215) 922-8080 Fax (215) 922-8082

LOCATION	CAMDEN, NJ		
TITLE	SJPC BALZANO MARINE TERMINAL RAIL INFRASTRUCTURE REHABILITATION CONC FLOOR AT BUILDING A - PLAN, SECTION AND DETAIL		
DRAWN	FJC	PROJ # 2021500064.000	DRAWING NUMBER
CHK	MGW	DATE 06/24/2022	S-102

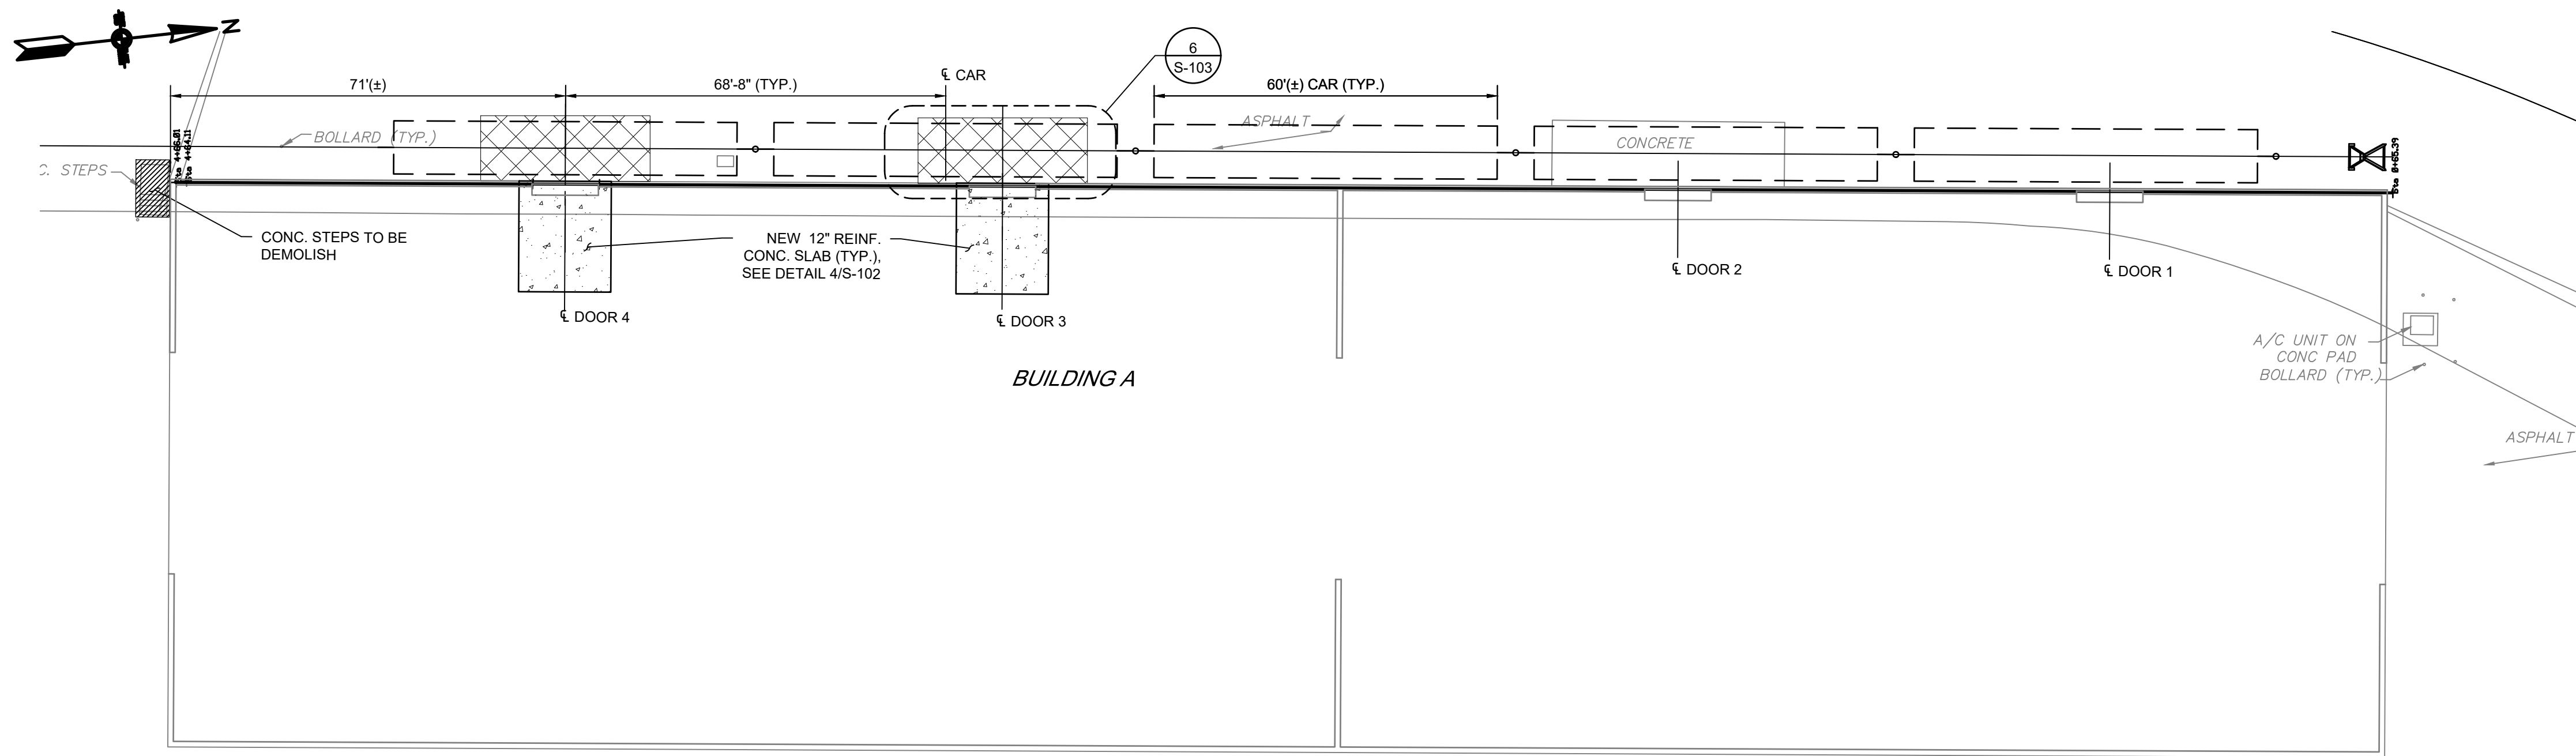


5 CANOPY PLAN AT BUILDING A
 Scale: 1" = 20'-0"
 GRAPHIC SCALE

NOTES

- SEE STRUCTURAL GENERAL NOTES SHEET S-000.
- ALL WORK ON THIS SHEET ASSOCIATED WITH ADD ALTERNATE #1.


LEGEND

- NEW ROLL-UP DOOR AND CANOPY
- 60' BOX CAR

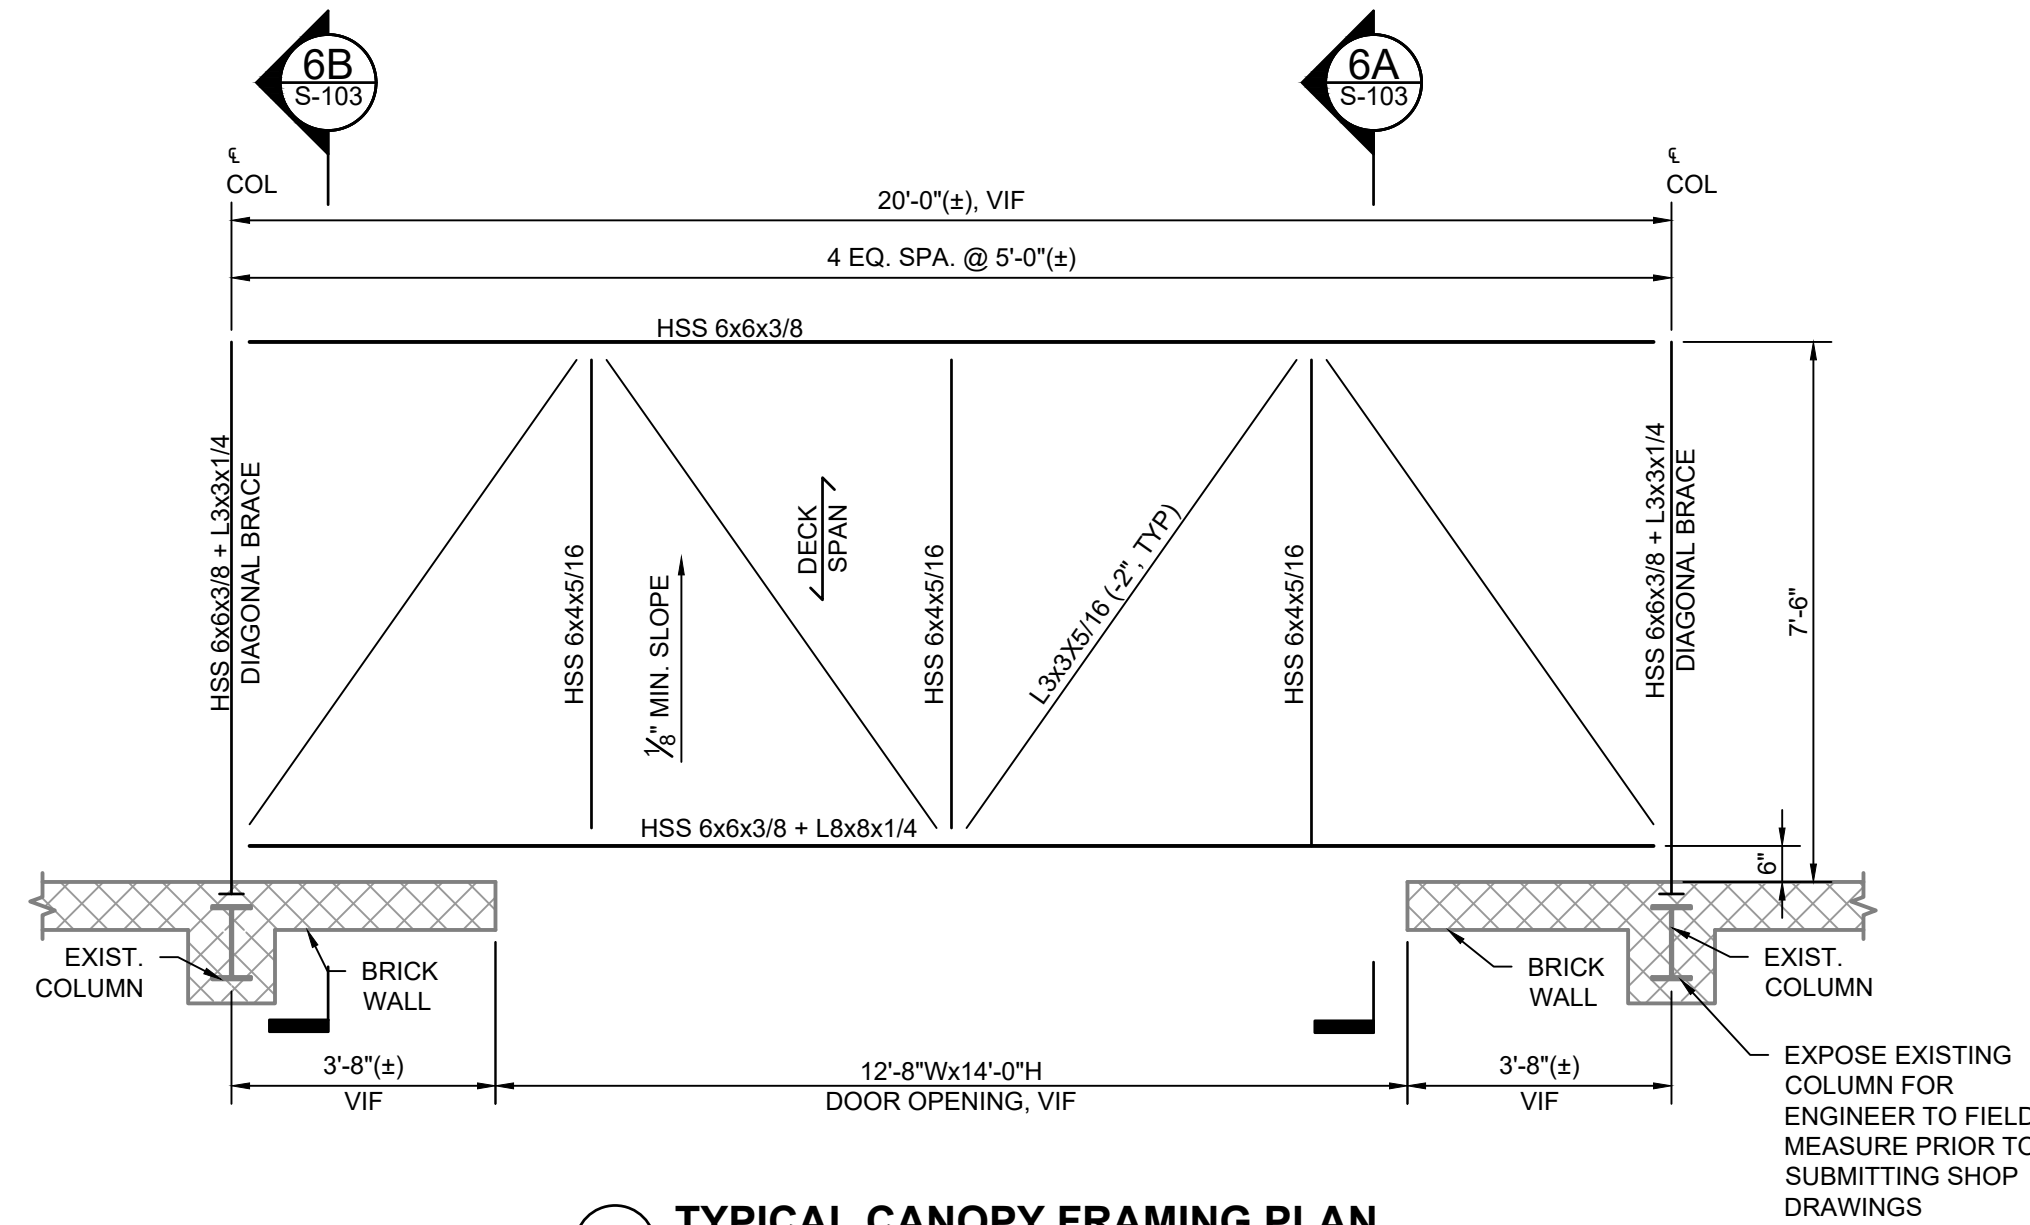


6 TYPICAL CANOPY FRAMING PLAN
 Scale: 3/8" = 1'-0"
 GRAPHIC SCALE

ALL NEW CANOPY STEEL SHALL BE SHOP PRIMED AND PAINTED, UNO

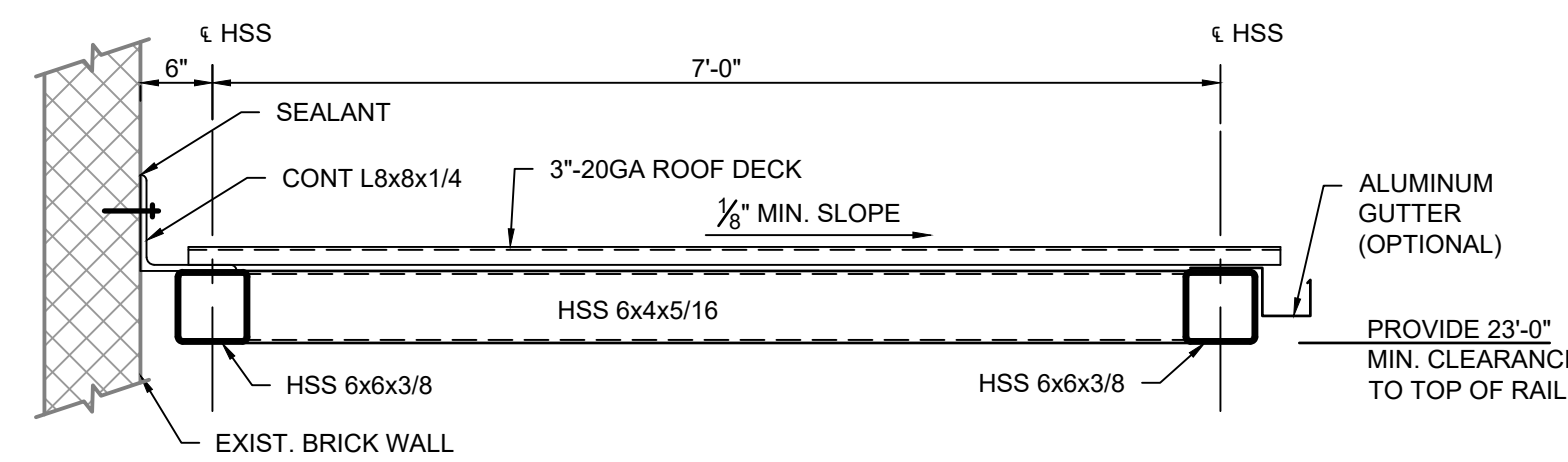

6A SECTION
 Scale: 3/4" = 1'-0"
 GRAPHIC SCALE

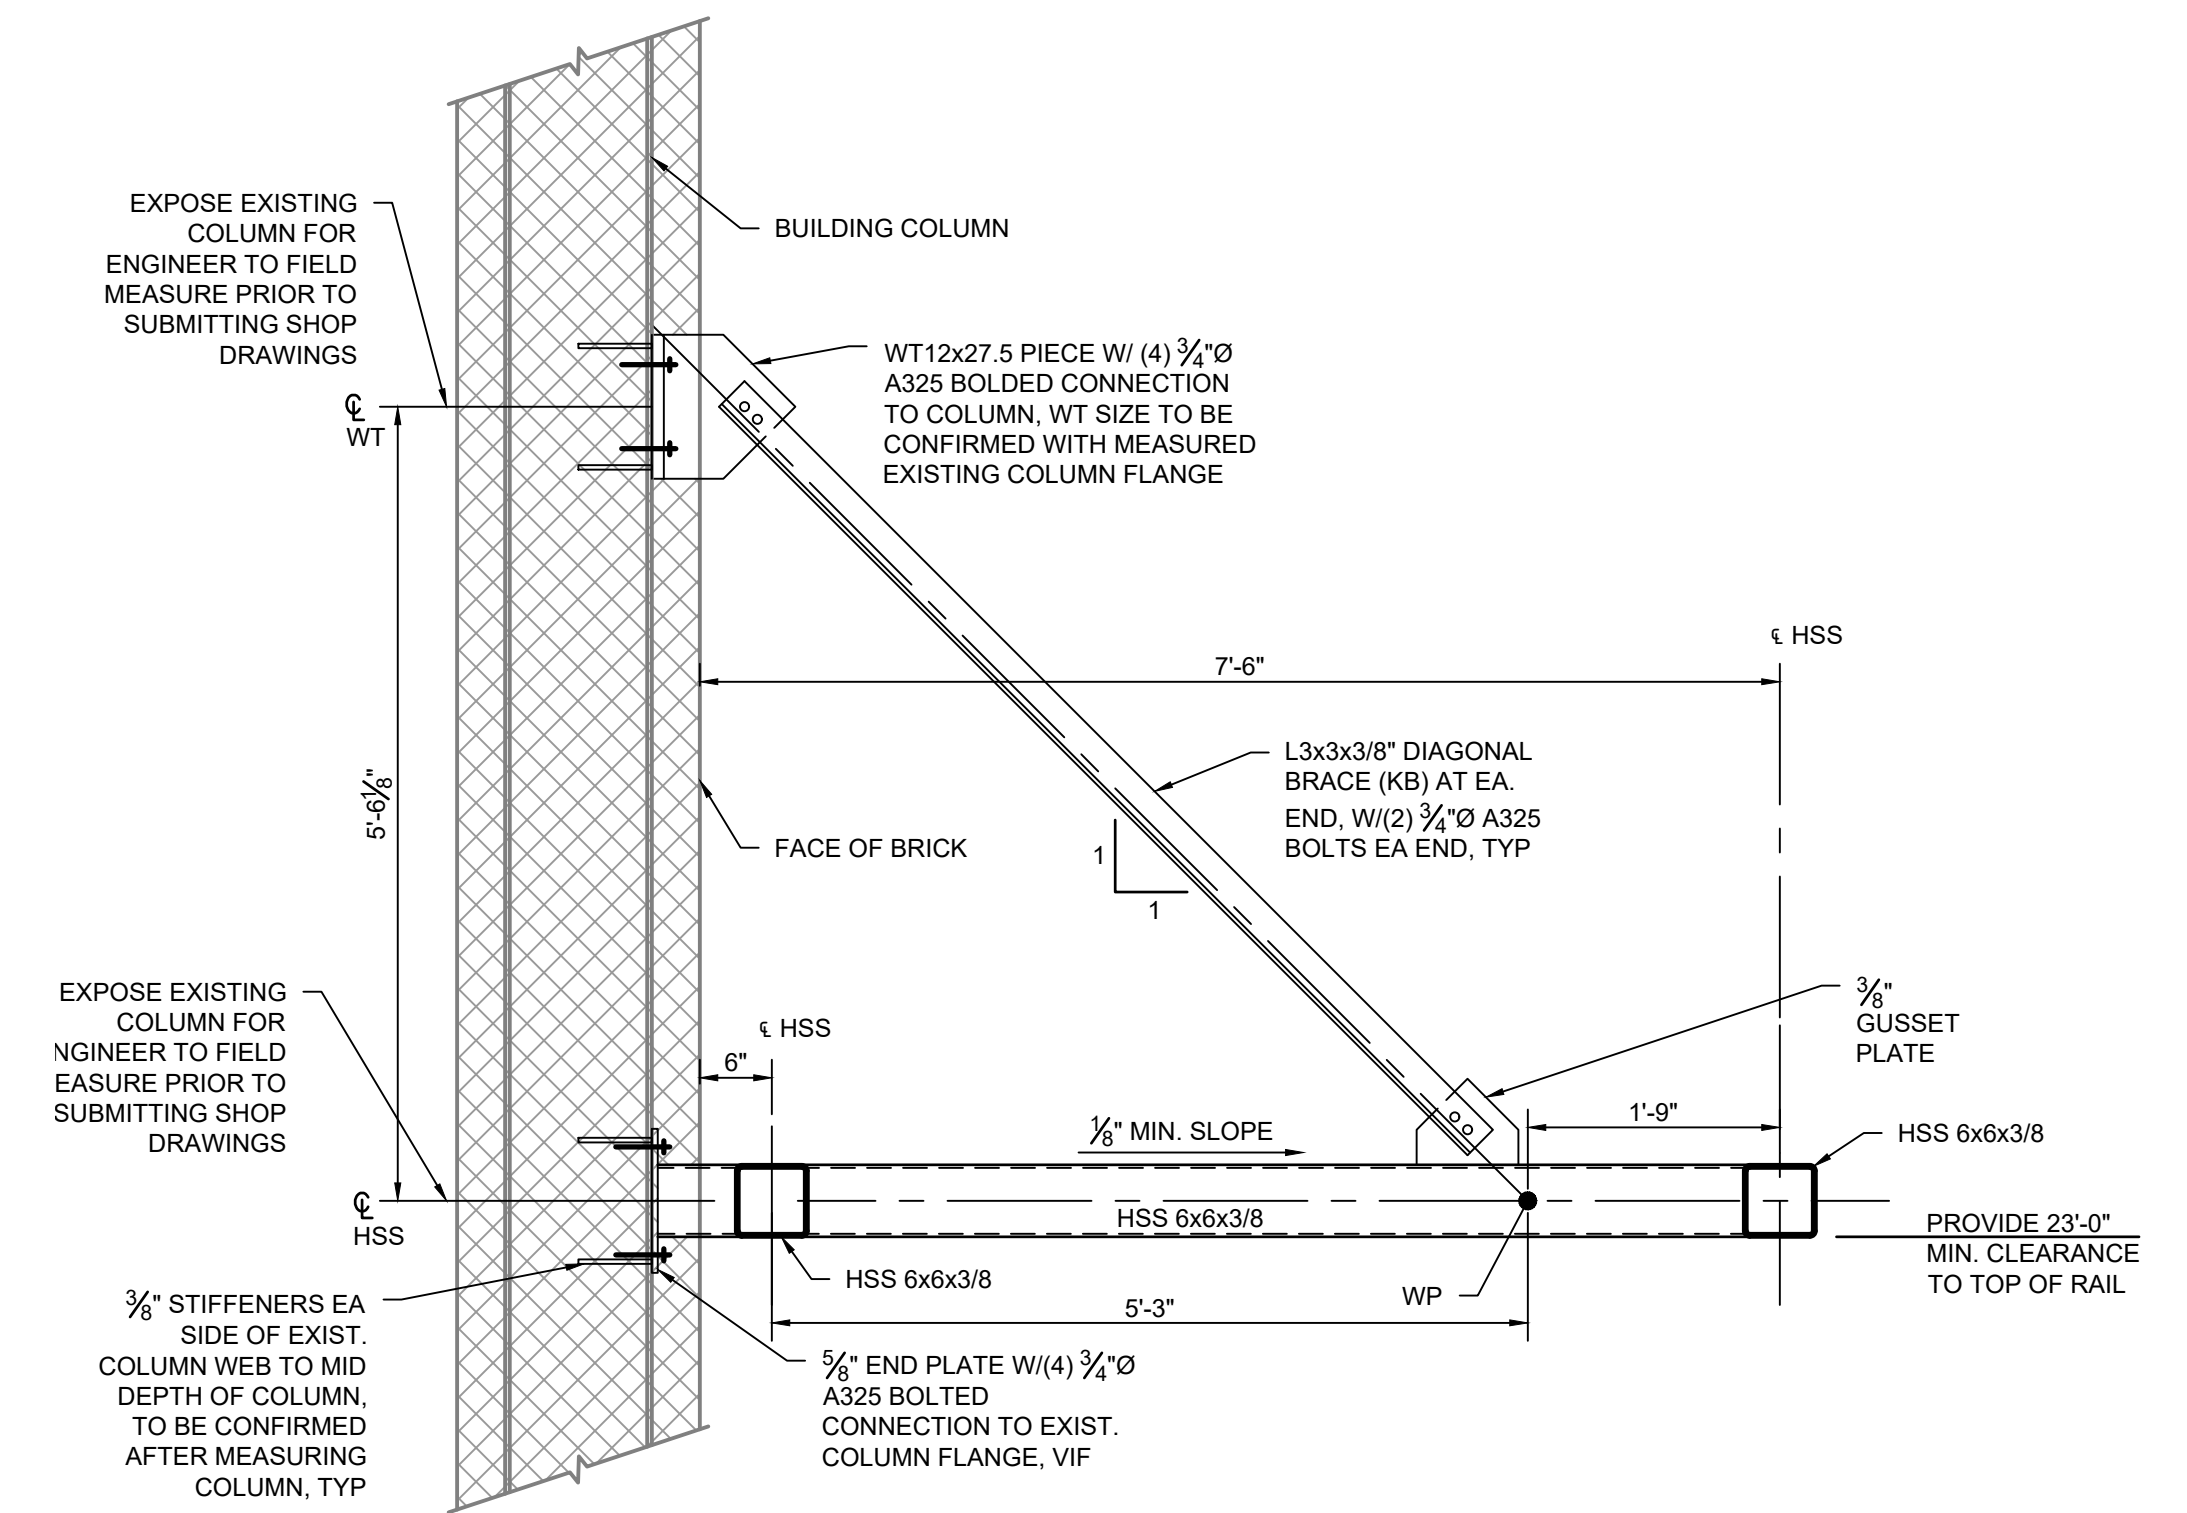


6B SECTION
 Scale: 3/4" = 1'-0"
 GRAPHIC SCALE

ISSUED FOR BID

	URBAN ENGINEERS, INC. 530 Walnut Street Philadelphia, PA 19106 (215) 922-8080 Fax (215) 922-8082
	LOCATION: CAMDEN, NJ TITLE: SJPC BALZANO MARINE TERMINAL RAIL INFRASTRUCTURE REHABILITATION CANOPY FRAMING PLAN AT BUILDING A AND SECTIONS
OWN: FYC PROJ #: 2021500064.000 DATE: 06/24/2022	DRAWING NUMBER: S-103


REV	BY	DATE	DESCRIPTION

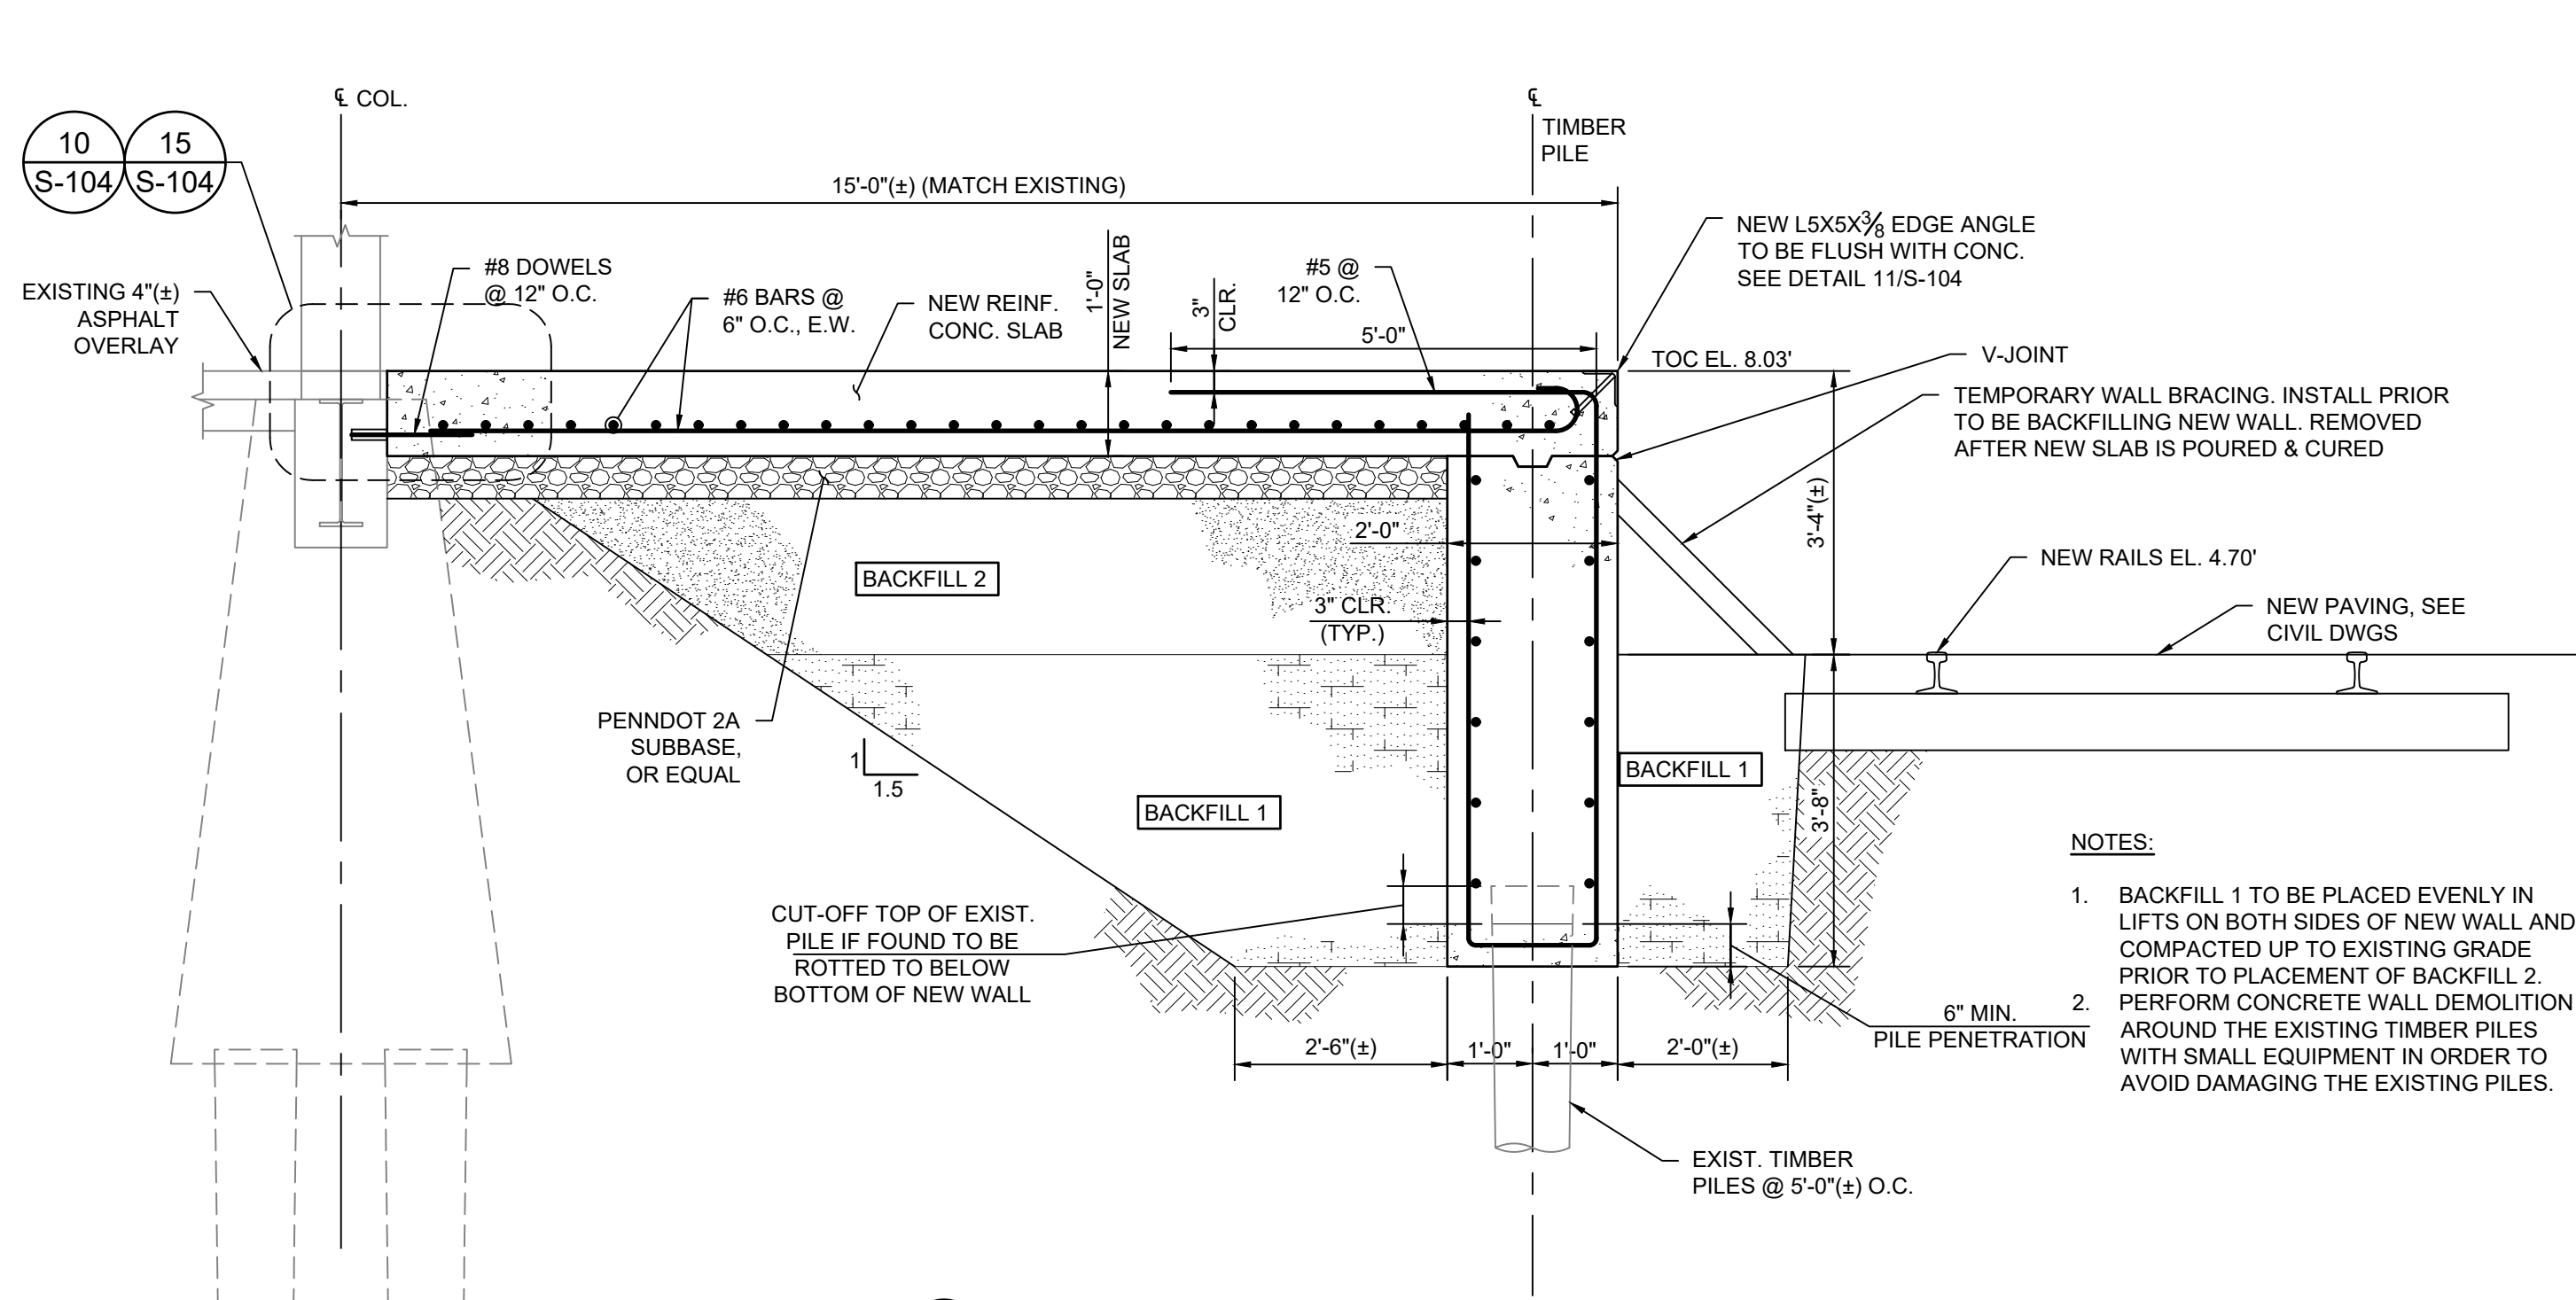


NOTES:

1. BACKFILL 1 TO BE PLACED EVENLY IN LIFTS ON BOTH SIDES OF NEW WALL AND COMPACTED UP TO EXISTING GRADE PRIOR TO PLACEMENT OF BACKFILL 2.
2. PERFORM CONCRETE WALL DEMOLITION AROUND THE EXISTING TIMBER PILES WITH SMALL EQUIPMENT IN ORDER TO AVOID DAMAGING THE EXISTING PILES.


2B SECTION 2B
Scale: 1/2" = 1'-0"
GRAPHIC SCALE

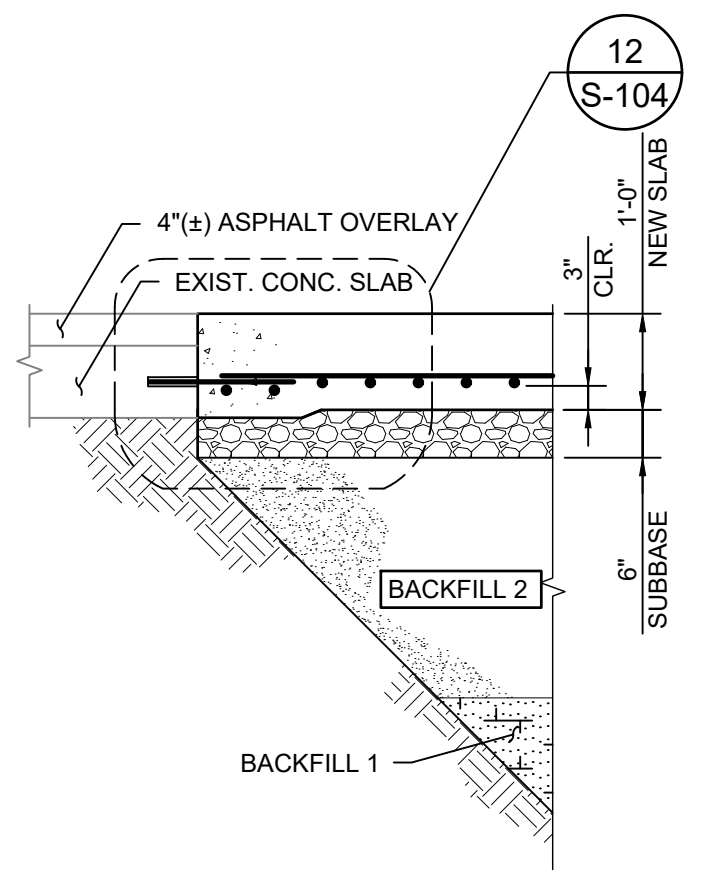


2C SECTION 2C
Scale: 1/2" = 1'-0"
GRAPHIC SCALE

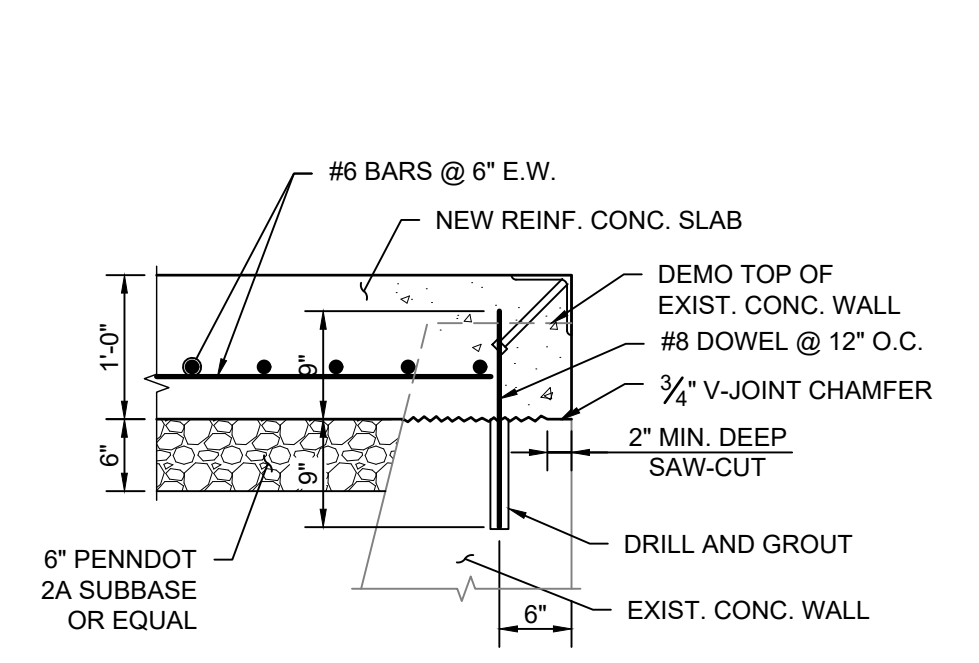


2D SECTION 2D
Scale: 3/4" = 1'-0"
GRAPHIC SCALE

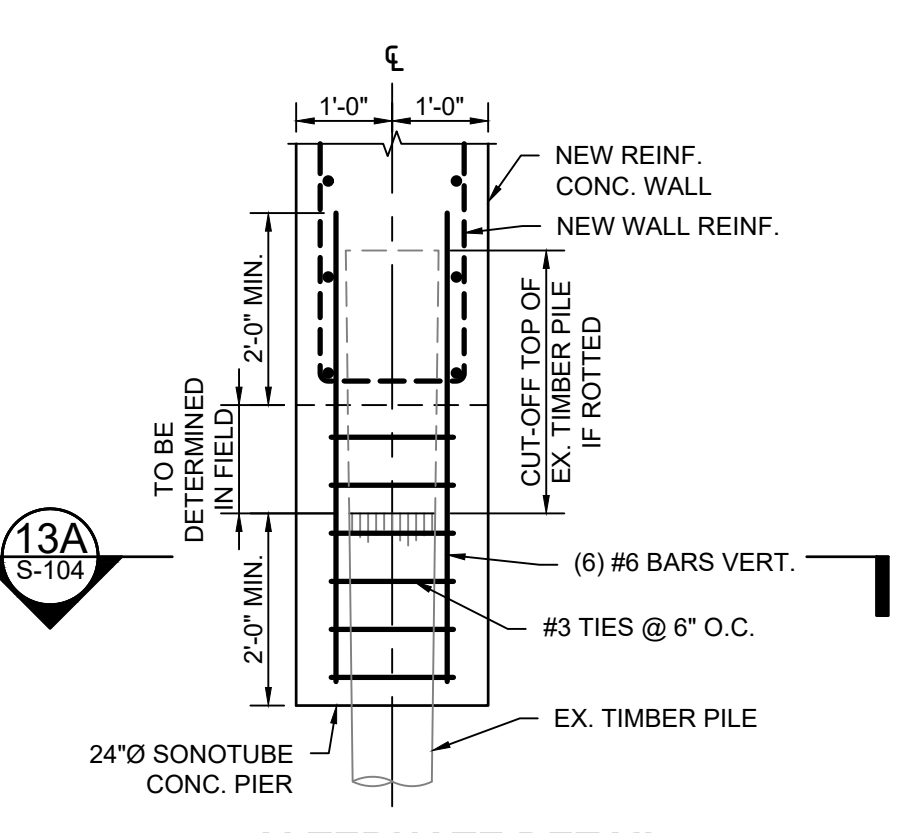


13A ALTERNATE DETAIL IF EX. PILES ARE ROTTED
Scale: 1/2" = 1'-0"
GRAPHIC SCALE

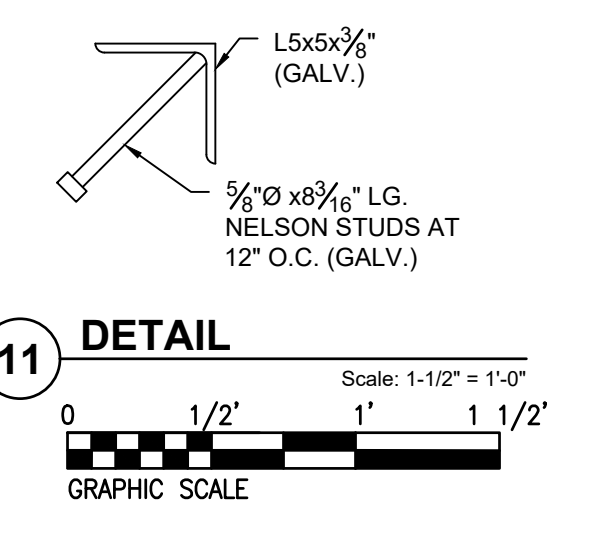


11 DETAIL
Scale: 1-1/2" = 1'-0"
GRAPHIC SCALE

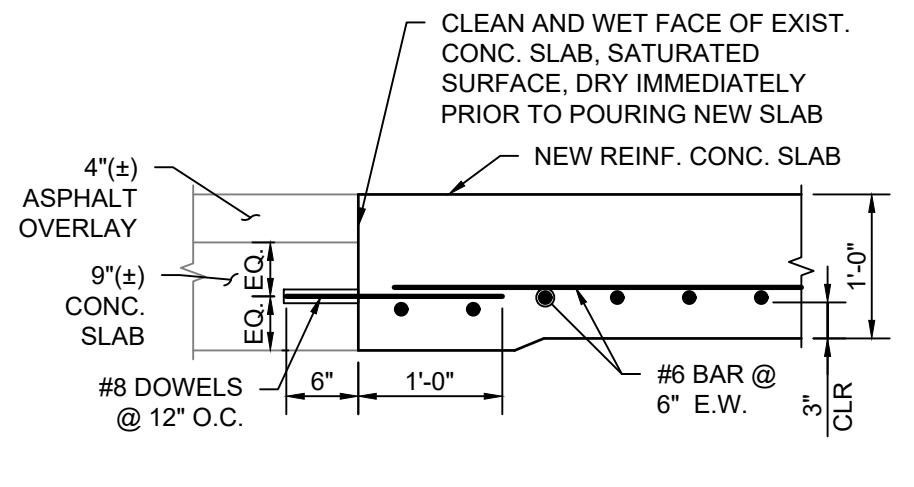


12 DETAIL
Scale: 3/4" = 1'-0"
GRAPHIC SCALE

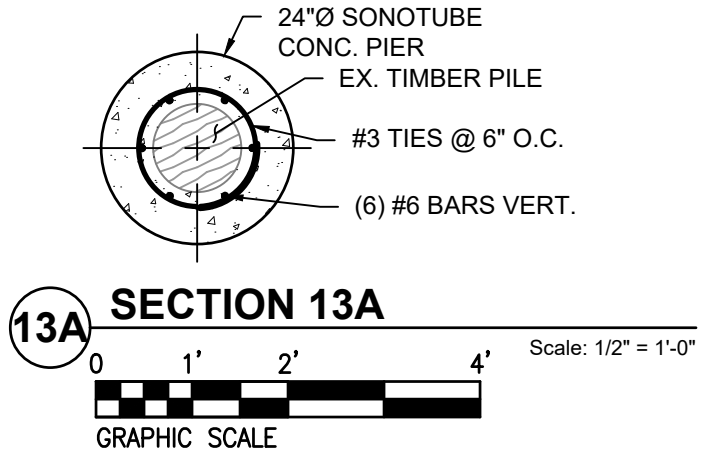


13A SECTION 13A
Scale: 1/2" = 1'-0"
GRAPHIC SCALE

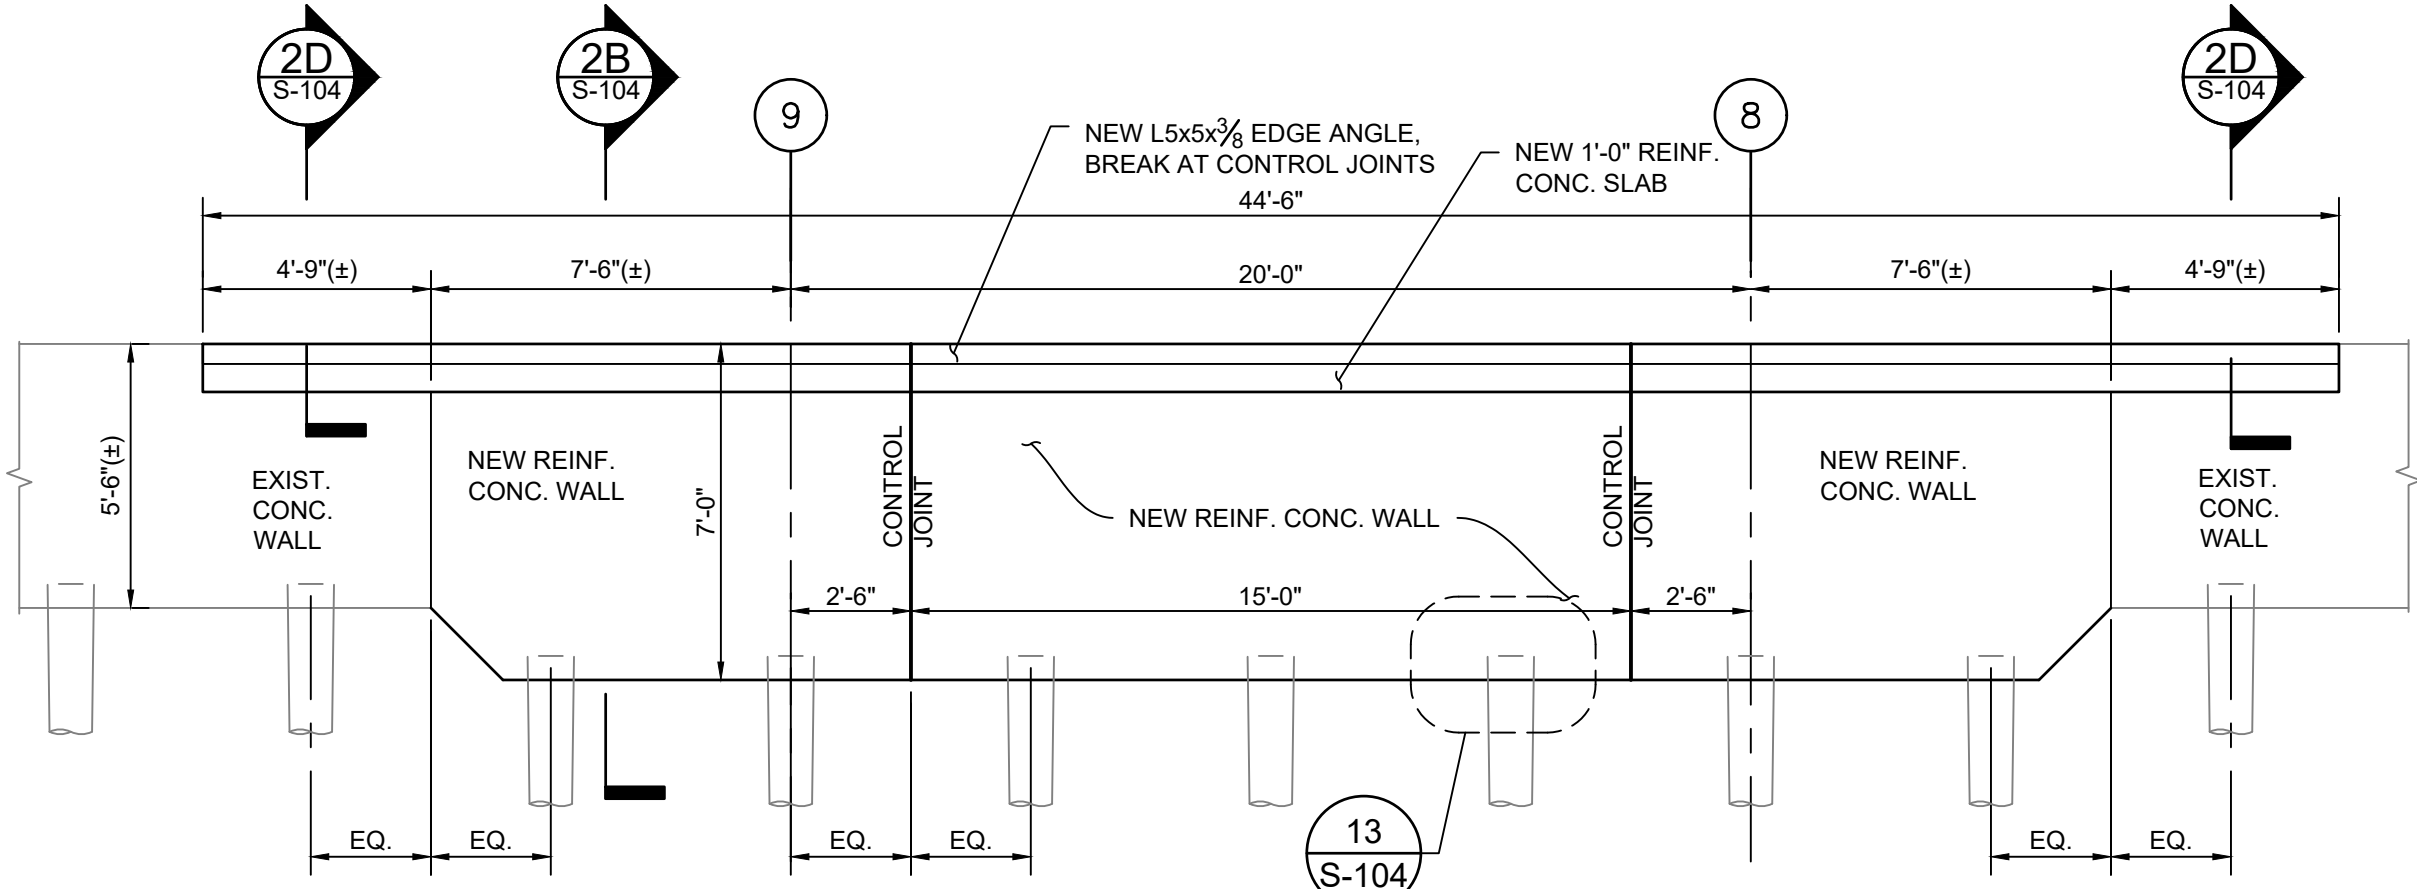


2E SECTION
Scale: 1/4" = 1'-0"
GRAPHIC SCALE

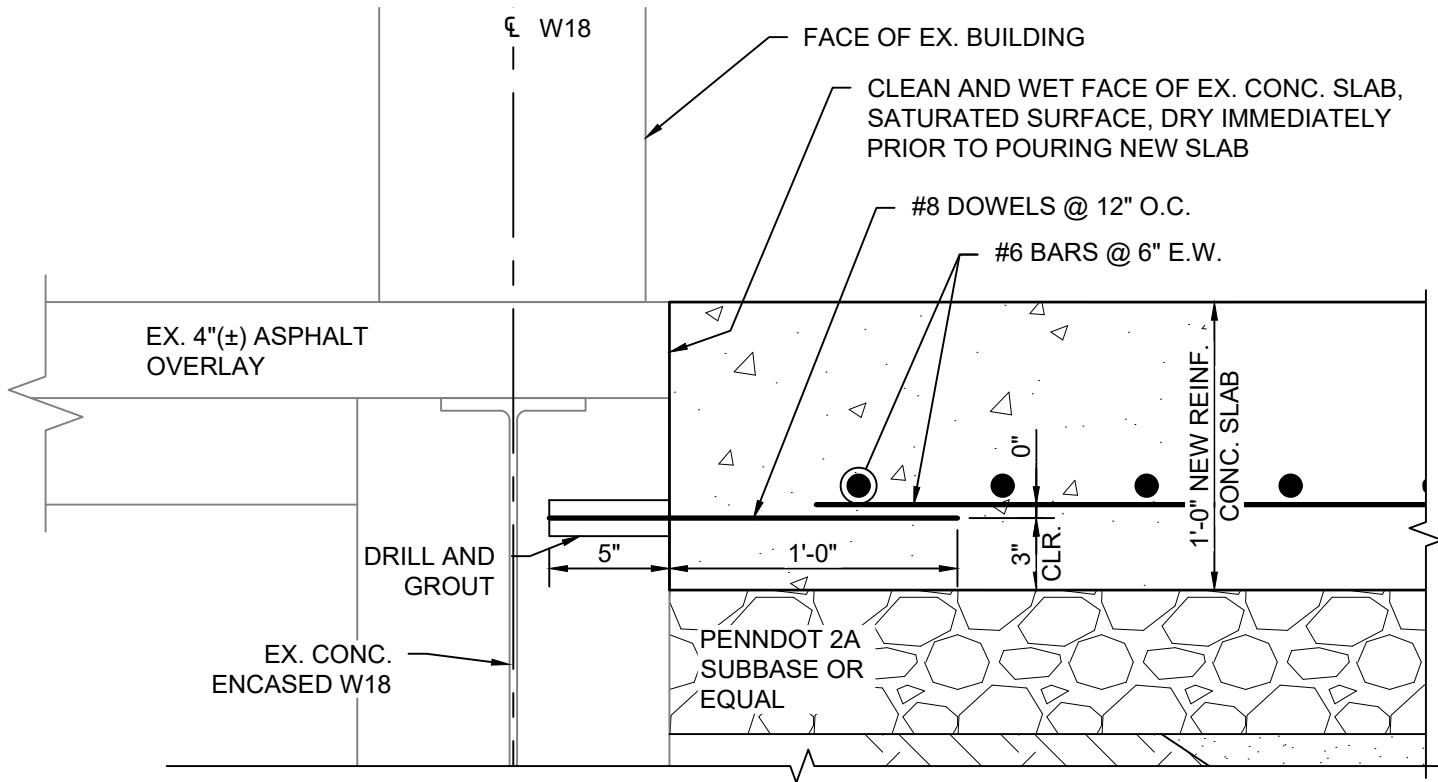

10 DETAIL @ GRADE BEAM
Scale: 1-1/2" = 1'-0"
GRAPHIC SCALE

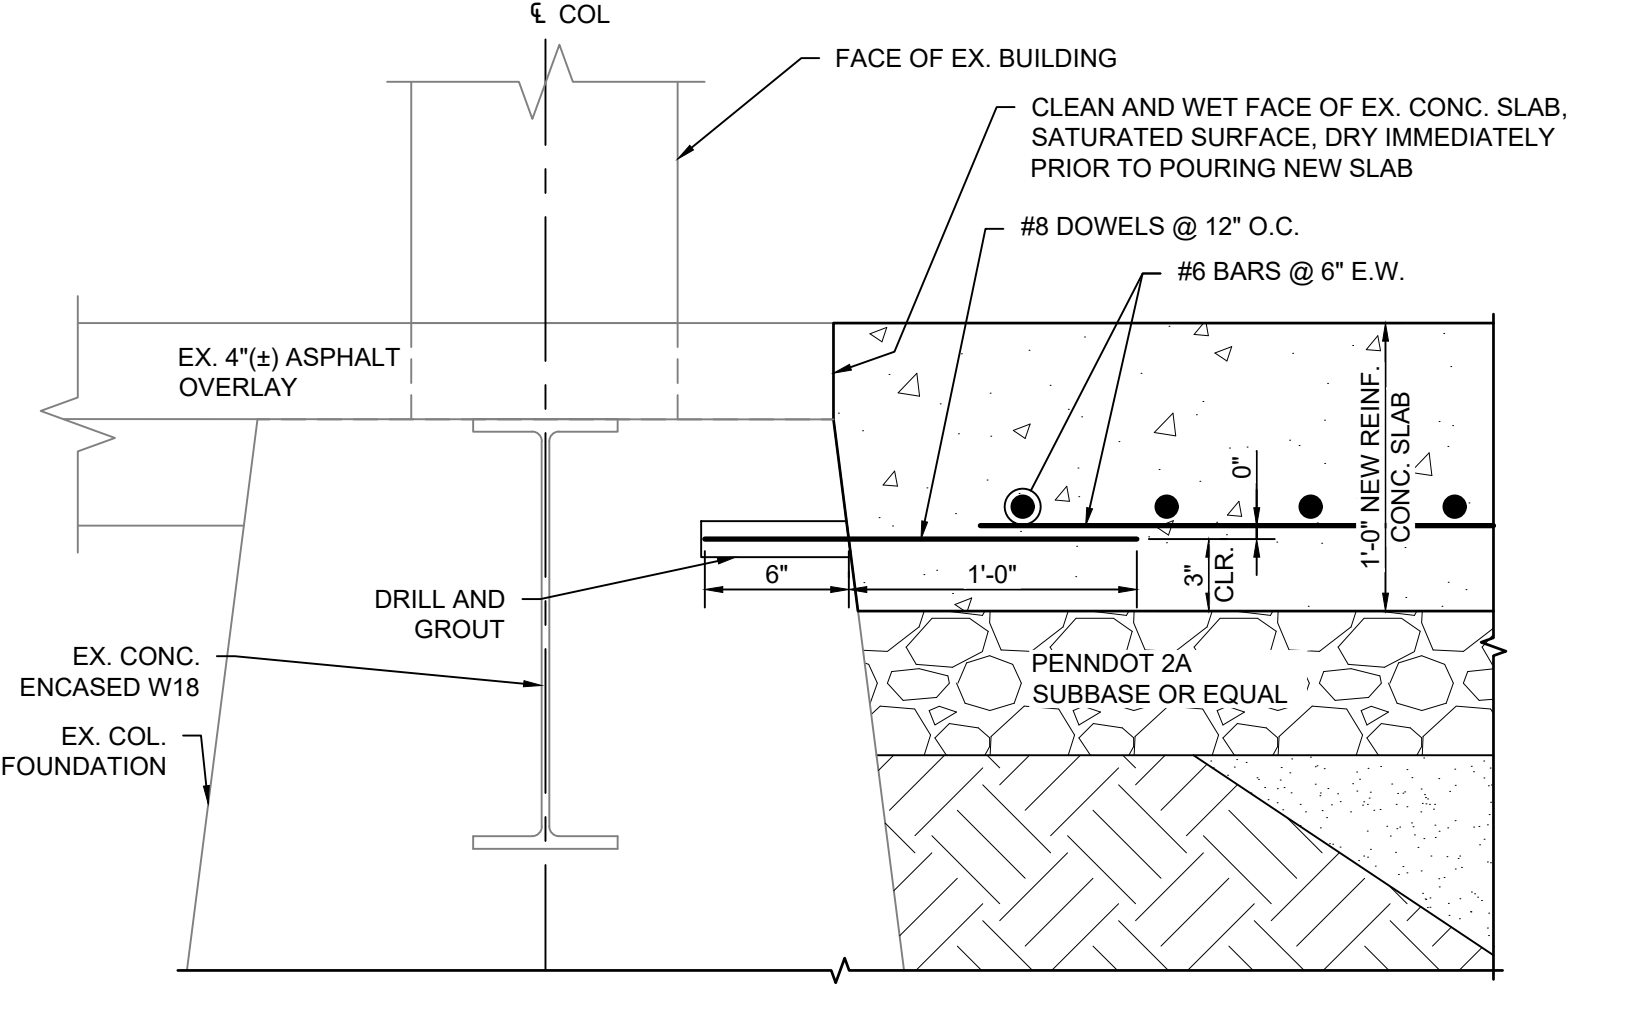

15 DETAIL @ CONC. PILE
Scale: 1-1/2" = 1'-0"
GRAPHIC SCALE

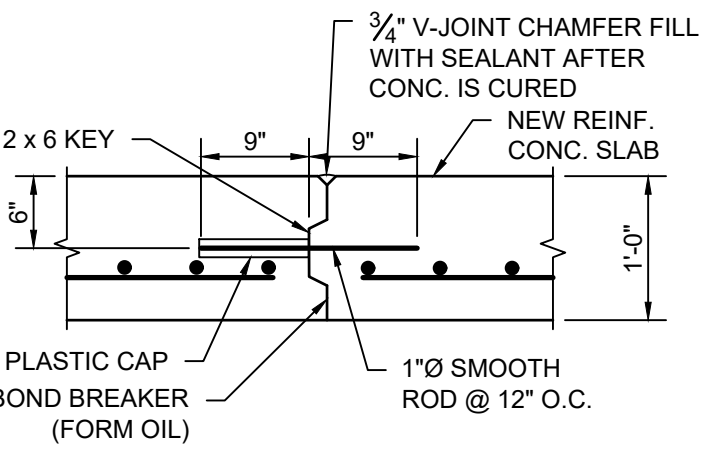

14 TYPICAL CONTROL JOINT DETAIL
Scale: 3/4" = 1'-0"
GRAPHIC SCALE

NOTES

1. SEE STRUCTURAL GENERAL NOTES SHEET S-000.

REV	BY	DATE	DESCRIPTION


ISSUED FOR BID

URBAN ENGINEERS, INC.
530 Walnut Street
Philadelphia, PA 19106
(215) 922-8080 Fax (215) 922-8082



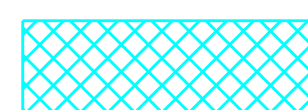



LOCATION: **CAMDEN, NJ**

TITLE: **SJPC BALZANO MARINE TERMINAL RAIL INFRASTRUCTURE REHABILITATION LOADING DOCK DETAILS**

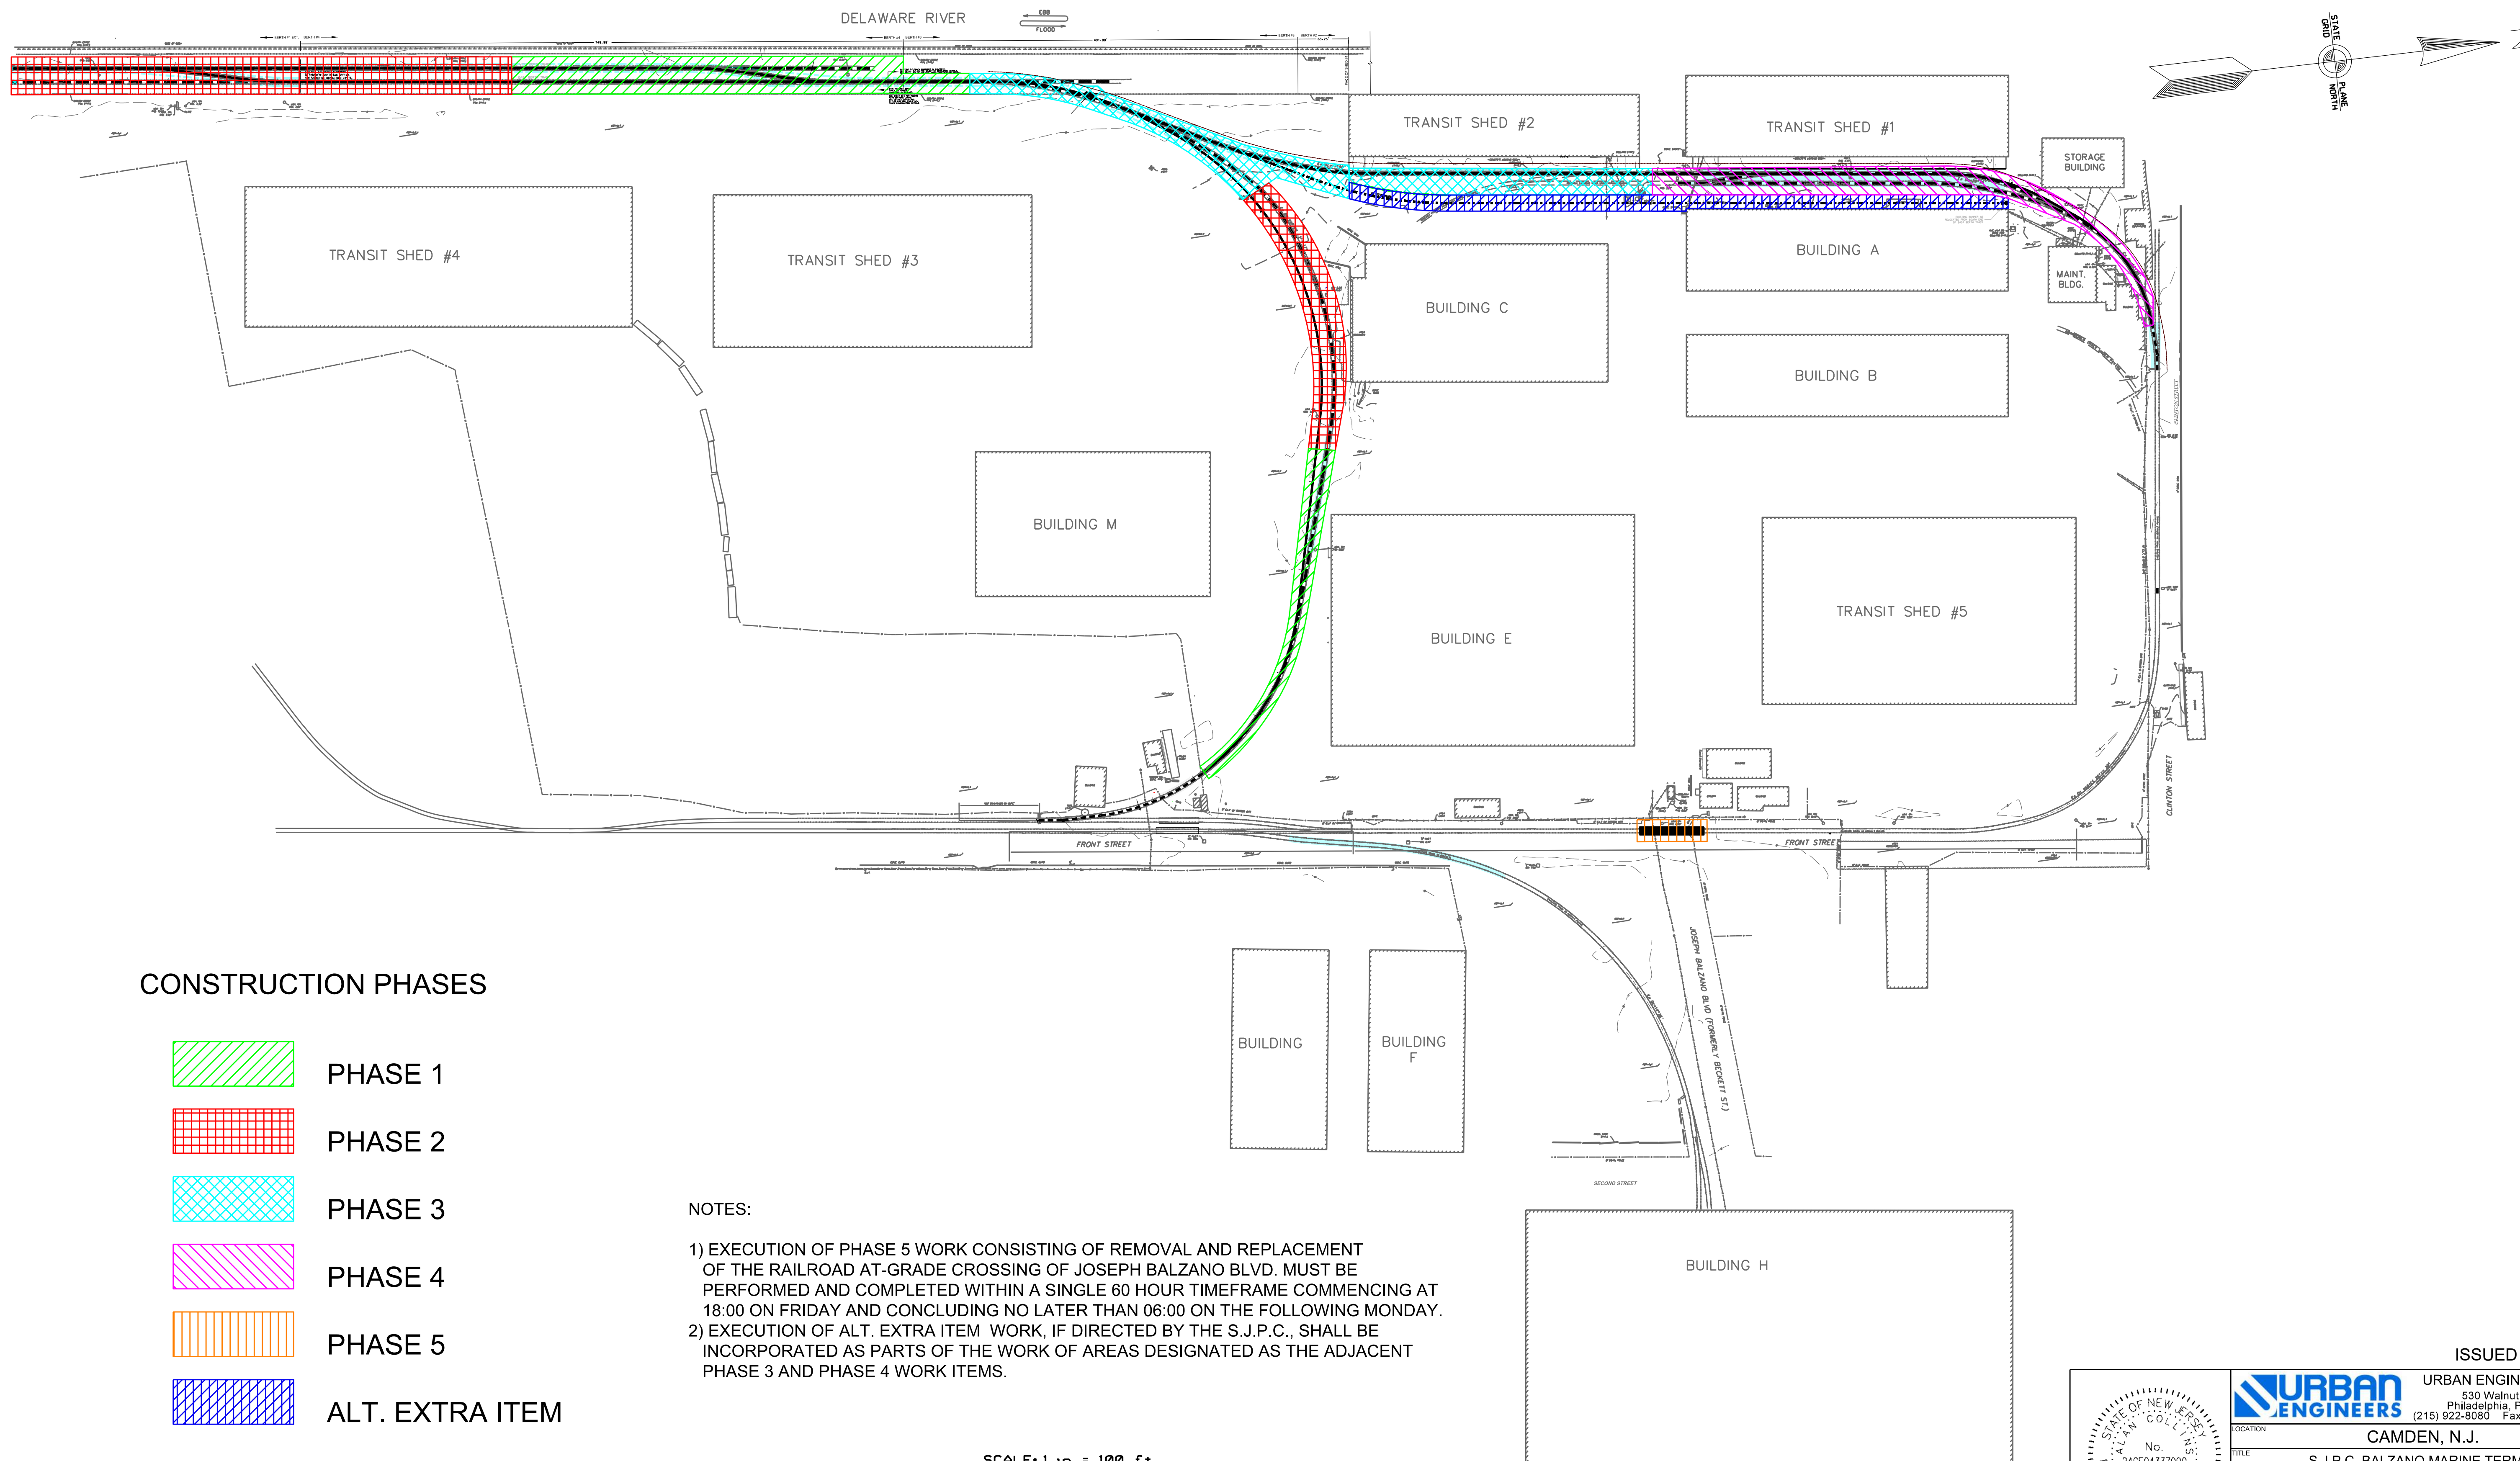DWN: FYC PROJ # 2021500064.000 DRAWING NUMBER: S-104
CHK: MGW DATE: 06/24/2022

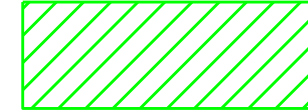

CONSTRUCTION PHASES

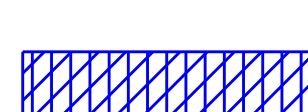
-  PHASE 1
-  PHASE 2
-  PHASE 3
-  PHASE 4
-  PHASE 5
-  ALT. EXTRA ITEM

NOTES:

- 1) EXECUTION OF PHASE 5 WORK CONSISTING OF REMOVAL AND REPLACEMENT OF THE RAILROAD AT-GRADE CROSSING OF JOSEPH BALZANO BLVD. MUST BE PERFORMED AND COMPLETED WITHIN A SINGLE 60 HOUR TIMEFRAME COMMENCING AT 18:00 ON FRIDAY AND CONCLUDING NO LATER THAN 06:00 ON THE FOLLOWING MONDAY.
- 2) EXECUTION OF ALT. EXTRA ITEM WORK, IF DIRECTED BY THE S.J.P.C., SHALL BE INCORPORATED AS PARTS OF THE WORK OF AREAS DESIGNATED AS THE ADJACENT PHASE 3 AND PHASE 4 WORK ITEMS.

SCALE: 1 in. = 100 ft
 0 100 200 300 400
 DO NOT SCALE THIS DRAWING FOR DIMENSIONS NOT GIVEN

REV	BY	DATE	DESCRIPTION

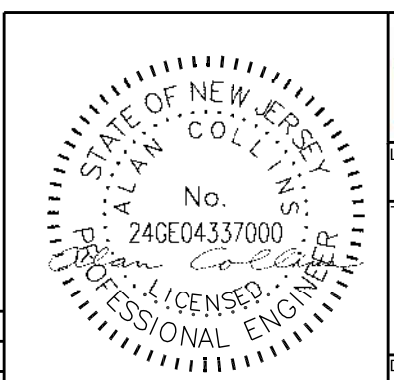

ISSUED FOR BID

URBAN ENGINEERS URBAN ENGINEERS, INC.
 530 Walnut Street
 Philadelphia, PA 19106
 (215) 922-8080 Fax (215) 922-8082

LOCATION: CAMDEN, N.J.

TITLE: S.J.P.C. BALZANO MARINE TERMINAL RAIL INFRASTRUCTURE REHABILITATION CONSTRUCTION PHASING PLAN

OWN: FST PROJ # DRAWING NUMBER
 CRK: DATE CP-1

GENERAL NOTES:

1) THE INFORMATION SHOWN PERTAINING TO THE PRESENCE OF EXISTING FACILITIES AND INFRASTRUCTURE OF THE SITE AND PROPOSED WORK DEPICTED HEREON, WERE DEVELOPED IN CONJUNCTION WITH INFORMATION PROVIDED BY THE SOUTH JERSEY PORT CORPORATION (SJPC). THIS INFORMATION CONSISTED OF HISTORICAL PLANS, DRAWINGS AND RECORD DOCUMENTS REVIEWED BY URBAN ENGINEERS. THE INFORMATION SHOWN IS BASED ON A CORRELATION OF THESE RECORD PLANS AND OTHER INFORMATION COLLECTED DURING FIELD INSPECTIONS CONDUCTED BY URBAN ENGINEERS DURING THE FALL OF 2020 AND THE SPRING AND SUMMER OF 2021. THE COLLECTED INFORMATION IS BELIEVED TO BE ACCURATE AS OF THE DATE OF PREPARATION OF THESE PLANS, HOWEVER URBAN ENGINEERS ASSUMES NO LIABILITIES FOR INACCURACIES, INCONSISTANCIES, ERRORS OR OMISSIONS RELATING TO INFORMATION CONTAINED IN SUCH RECORD DOCUMENTS.

2) THE BALZANO TERMINAL, FORMERLY KNOWN AS THE BECKETT STREET TERMINAL, IS AN OPERATING PORT FACILITY THAT HAS BEEN IN SERVICE FOR APPROXIMATELY 100 YEARS. CHANGES HAVE OCCURRED OVER TIME THAT MAY NOT HAVE BEEN DOCUMENTED. LOCATIONS OF ON AND OFF-SITE UTILITIES SHOWN ARE APPROXIMATE AND MAY NOT BE COMPLETE. THE NATURE AND EXACT LOCATION OF EXISTING UTILITIES SHOULD BE VERIFIED PRIOR TO INITIATING ANY ACTIVITY THAT MAY AFFECT OR IMPACT THEIR USE OR LOCATION.

3) URBAN ENGINEERS ASSUMES NO LIABILITIES NOR TAKES ANY RESPONSIBILITY FOR IMPACTS TO THE WORK DEPICTED ON THESE DRAWINGS RESULTING FROM SUBSEQUENT CHANGES TO THE EXISTING FACILITIES NOR ANY PROPOSED PLANS OR WORK FOR CONSTRUCTION, MODIFICATION, RETIREMENT OR REMOVAL OF THE EXISTING FACILITIES EITHER OWNED OR CONTROLLED BY SJPC, ITS HEIRS, ASSIGNS, DESIGNEES, LESSORS, TENNANTS, OR OTHER GOVERNMENTAL AUTHORITIES HAVING INTERESTS IN AND ABOUT THE BALZANO TERMINAL SITE.

4) IN ACCORDANCE WITH N.J.S.A. 48:2-73 et seq. and enabling rules - N.J.A.C. 14:2. THE CONTRACTOR SHALL COMPLETE AN 811 ONE-CALL NOTIFICATION BY DIALING 811 FROM WITHIN NEW JERSEY OR BY CALLING (800)272-1000, A MINIMUM OF THREE (3) BUSINESS DAYS PRIOR TO PERFORMING ANY EXCAVATIONS. THE CONTRACTOR SHALL VERIFY LOCATIONS AND DEPTH OF ALL UNDERGROUND UTILITIES AND STRUCTURES AND COORDINATE ACTIVITIES WITH THE WORK OF OTHER TRADES AND CONTRACTORS THAT MAY BE PERFORMING CONSTRUCTION ACTIVITIES CONCURRENTLY, PRIOR TO START OF THE WORK FOR THIS PROJECT.

5) THE TOPOGRAPHICAL INFORMATION ILLUSTRATED HEREIN WAS DEVELOPED FROM GROUND SURVEY PERFORMED BY COLLIER'S ENGINEERING AND DESIGN DURING THE SUMMER OF 2021 UTILIZING 3D LASER SCANNING EQUIPMENT AND REFERENCED TO THE NEW JERSEY STATE PLANE COORDINATE SYSTEM AND NAVD88 VERTICAL DATUM. UNDERGROUND UTILITIES SHOWN ARE BASED ON BEST AVAILABLE INFORMATION COMPILED FROM AVAILABLE DOCUMENTATION PROVIDED BY SJPC. HOWEVER, NEITHER THE SJPC NOR URBAN ENGINEERS REPRESENTS THAT THE DRAWINGS ARE COMPLETELY ACCURATE. THE LOCATIONS SHOWN MAY BE APPROXIMATE, AND OLDER OR PREVIOUSLY ABANDONED UTILITIES MAY NOT BE SHOWN.

6) THE DRAWINGS SHOW THE PROPOSED SCOPE OF TRACK CONSTRUCTION OR REHABILITATION AND OTHER INFRASTRUCTURE IMPROVEMENTS TO BE INCLUDED WITHIN THE SCOPE OF THIS PROJECT. THE CONTRACTOR SHALL NOTIFY THE SJPC AND THE PROJECT MANAGER IMMEDIATELY UPON DISCOVERY OF THE PRESENCE OF EXISTING UNDERGROUND UTILITIES THAT DO NOT COMPLY WITH THE MINIMUM REQUIREMENTS FOR DEPTH OF COVER BENEATH RAILROAD TRACKS OR ARE NOT SHOWN ON THE PLANS AND WHICH MAY BE IN CONFLICT WITH WORK TO BE PERFORMED UNDER TERMS OF THE CONTRACT WITH THE SJPC.

7) WHERE PROPOSED RAILROAD TRACK CONSTRUCTION OR REHABILITATION IS SHOWN TO PASS OVER EXISTING UNDERGROUND UTILITIES AS INDICATED ON THE PLANS AND THAT ARE NOT PRESENTLY PROTECTED FROM LOADS IMPOSED BY THE MOVEMENT OF RAILROAD LOCOMOTIVES OR ROLLING STOCK, THE CONTRACTOR MUST INSTALL CASING PIPES TO PROTECT ANY EXISTING UTILITY LINES CARRYING SUBSTANCES UNDER PRESSURE BENEATH TRACKS. THE CONTRACTOR MUST SUBMIT SITE SPECIFIC PLANS FOR EACH SUCH LOCATION IN ACCORDANCE WITH THE PROJECT SPECIFICATIONS, TO THE SJPC AND PROJECT MANAGER FOR PRIOR REVIEW AND APPROVAL BEFORE COMMENCING SUCH OPERATIONS.

8) THE QUANTITY FOR "RESTORATION OF PAVEMENT" WILL BE ADJUSTED UP OR DOWN BASED ON FINAL FIELD MEASUREMENTS. UNBALANCING OF THIS BID ITEM ON THE PROPOSAL FORM WILL BE CAUSE FOR REJECTION OF THE BID.

9) SOME LOCATIONS WHERE WORK WILL OCCUR IN THE PROJECT HAVE GROUND SURFACES OTHER THAN PAVEMENT, SUCH AS GRAVEL OR SILTY EARTH. THE CONTRACTOR SHALL RESTORE ALL SUCH LOCATIONS TO THE PRE-CONSTRUCTION CONDITIONS AFTER PERFORMANCE OF THE WORK. PAYMENT FOR SUCH RESTORATION WORK IN THESE AREAS WILL NOT BE MADE DIRECTLY BUT SHALL BE SUBSIDIARY FOR OTHER ITEMS FOR WHICH PAYMENT IS MADE.

10) THE CONTRACTOR SHALL TAKE NECESSARY PRECAUTIONS IN EXCAVATIONS AND SHALL HAND EXCAVATE AS NEEDED TO PROTECT EXISTING UNDERGROUND STRUCTURES AND UTILITIES. THE CONTRACTOR SHALL PLATE OVER TRENCHES AS NECESSARY FOR MAINTAINING PEDESTRIAN AND VEHICULAR TRAFFIC DURING THE WORK.

SURVEY NOTES

1. RAILROAD STATIONING FOR PROJECT PROFILES AND ALIGNMENTS IS BASED ON STATIONS ESTABLISHED FOR CHORD DEFINITION CURVES AT THE CENTERLINE OF THE PROPOSED TRACK UNLESS OTHERWISE NOTED.

2. THE CONTRACTOR IS RESPONSIBLE FOR THE PRESERVATION OF ALL SURVEY CONTROL MONUMENTS. IN THE EVENT MONUMENTS ARE DAMAGED OR DESTROYED BY THE CONTRACTOR, THE ENGINEER WILL REPLACE THE MONUMENT AT THE CONTRACTOR'S SOLE COST AND EXPENSE.

ABBREVIATIONS

MISCELLANEOUS

- AC. ACRES
- AVE. AVENUE
- BLVD. BOULEVARD
- BLDG. BUILDING
- C. Y. CUBIC YARDS
- CONC. CONCRETE
- ° DEGREE (S)
- DIA. DIAMETER
- DR. DRIVE
- DWG. DRAWING
- E. EAST
- ELEV. ELEVATION
- EXIST. EXISTING
- ' FOOT, FEET OR MINUTE (S)
- F. S. FINISHED SURFACE
- HORIZ. HORIZONTAL
- "INCH. INCHES OR SECOND (S)
- INV. INVERT
- LT. LEFT
- L. LENGTH
- L. F. LINEAL FEET
- MAX. MAXIMUM
- MIN. MINIMUM
- N. NORTH
- NAVD NORTH AMERICAN VERTICAL DATUM
- NGVD NATIONAL GEODETIC VERTICAL DATUM
- NTS NOT TO SCALE
- NO. NUMBER
- OH. OVERHEAD
- PROP. PROPOSED
- RR. RAILROAD
- RWY. RAILWAY
- R/W. RIGHT OF WAY
- RT. RIGHT
- S. SOUTH
- S. F. SQUARE FEET
- STA. STATION
- STD. STANDARD
- ST. STREET
- TWP. TOWNSHIP
- TYP. TYPICAL
- UG. UNDERGROUND
- V. VELOCITY
- WT. WEIGHT
- W. WEST
- X-ING. CROSSING



TRACK

- ATR. ABOVE TOP OF RAIL
- ALIGN. ALIGNMENT
- BBR. BELOW BASE OF RAIL
- CNTRS. CENTERS
- CWR. CONTINUOUS WELDED RAIL
- D. F. DIRECT FIXATION
- DSPD. DOUBLE SWITCH POINT DERAIL
- EOT. END OF TRACK
- HH. HEAD HARDENED
- JTD. JOINTED RAIL
- LH. LEFT HAND
- LLT. LAST LONG TIMBER
- ML. MAIN LINE
- MM. MILE MARKER
- MP. MILE POST
- NSC. NOT SUFFICIENT CLEARANCE
- OTM. OTHER TRACK MATERIAL
- PCC. POINT OF COMPOUND CURVE
- PC. POINT OF CURVE
- PCS. POINT OF CURVE TO SPIRAL
- POC. POINT ON CURVE
- PF. 1/2" POINT OF FROG
- PI. POINT OF INTERSECTION
- PITO. POINT OF INTERSECTION OF TURNOUT
- POS. POINT ON SPIRAL
- POT. POINT ON TANGENT
- PS. POINT OF SWITCH
- PSC. POINT OF SPIRAL TO CURVE
- PST. POINT OF SPIRAL TO TANGENT
- PT. POINT OF TANGENT
- PTS. POINT OF TANGENT TO SPIRAL
- PVC. POINT OF VERTICAL CURVE
- PVI. POINT OF VERTICAL INTERSECTION
- PVT. POINT OF VERTICAL TANGENT
- RBM. RAIL BOUND MANGANESE
- RH. RIGHT HAND
- SH. SECOND HAND
- SM. SOLID MANGANESE
- SMSG. SOLID MANGANESE SELF GUARDED
- SSPD. SINGLE SWITCH POINT DERAIL
- TC. TRACK CENTERS
- T. F. TRACK FEET
- TRK. TRACK
- UXO. UNIVERSAL CROSS-OVER

- F.W. EXISTING FIRE WATER LINE
- Ex-W EXISTING WATER LINE
- UD UNDER DRAIN
- SS EXISTING STORM SEWER
- ABN-W ABANDONED WATER LINE
- SAN EXISTING SANITARY SEWER
- S EXISTING STEAM LINE
- IWW EXISTING WASTEWATER LINE
- EXISTING DUCT BANK
- GAS EXISTING GAS LINE
- D DRAIN LINE
- CS COMBINED SEWER
- OHE OVERHEAD ELECTRIC
- E OTHER ELECTRIC LINE
- UGE UNDERGRADE ELECTRIC
- CHAIN LINK FENCE W/BARBED WIRE
- CHAIN LINK FENCE
- STEEL PIPE HANDRAIL
- RESIDENTIAL CHAIN LINK FENCE
- FM FORCE MAIN
- SFM SANITARY FORCE MAIN
- JO JOURNAL OIL LINE
- LO LUBE OIL LINE
- WO WASTE OIL LINE
- FUEL MISC. FUEL LINE
- DF DIESEL FUEL LINE
- CA COMPRESSED AIR LINE
- OIL MISC. OIL LINE
- LPG LPG LINE
- MCI MCI U.G. CABLE
- AT&T AT&T U.G. CABLE
- PT&T SPRINT U.G. CABLE
- WU WESTERN UNION U.G. CABLE
- COM COMMUNICATION LINE
- FOC FIBER OPTIC LINE
- EBT&TV ELECTRIC, TELEPHONE AND TELEVISION
- LD/SF LIMIT OF DISTURBANCE AND SILT FENCE
- LD LIMIT OF DISTURBANCE
- SF SILT FENCE
- ? UNKNOWN UTILITY LINE
- PL PROPERTY LINE
- SINGLE SIDE GUIDERAIL
- DOUBLE SIDE GUIDERAIL
- PIPELINE WITH CASING SLEEVE
- NOISE BARRIER WALL

- CO CLEANOUT
- EXISTING FIRE HYDRANT
- MANHOLE
- INLET
- XXX.XX' PROPOSED SPOT ELEVATION
- Mw MONITORING WELL
- EB ELECTRIC PULL BOX
- GVWV EXISTING WATER VALVE
- G GAS VALVE BOX
- M METER PIT
- CONTINUATION ON OTHER SHEET
- PROPOSED FIRE HYDRANT
- UTILITY POLE
- UTILITY POLE W/PULLOFF GUY
- UTILITY POLE W/COBRAHEAD LIGHT
- AREA DOWN LIGHT
- PROPOSED HAYES "WD" BUMPER
- EXISTING RAILS
- EXISTING TRACK CENTERLINES
- PROPOSED TRACK CENTERLINES
- EXISTING TRACKS TO BE REMOVED
- EXISTING TRACK TO REMAIN IN PLACE INCLUDED IN NEW GEOMETRY
- PROPOSED TURNOUT
- LIMITS OF CONCRETE FOR PROPOSED FULLY EMBEDDED TRACK CONSTRUCTION
- CENTERLINE OF TRACK ALTERNATE ADDITIONAL BID ITEM

ISSUED FOR BID

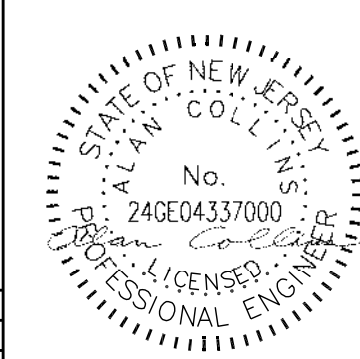			URBAN ENGINEERS, INC. 530 Walnut Street Philadelphia, PA 19106 (215) 922-8080 Fax (215) 922-8082
	LOCATION: CAMDEN, N.J.		
TITLE: S.J.P.C. BALZANO MARINE TERMINAL RAIL INFRASTRUCTURE REHABILITATION GENERAL NOTES AND LEGEND			
EWN: FST CRK:	PROJ #: DATE:	DRAWING NUMBER: G-02	

REV	BY	DATE	DESCRIPTION

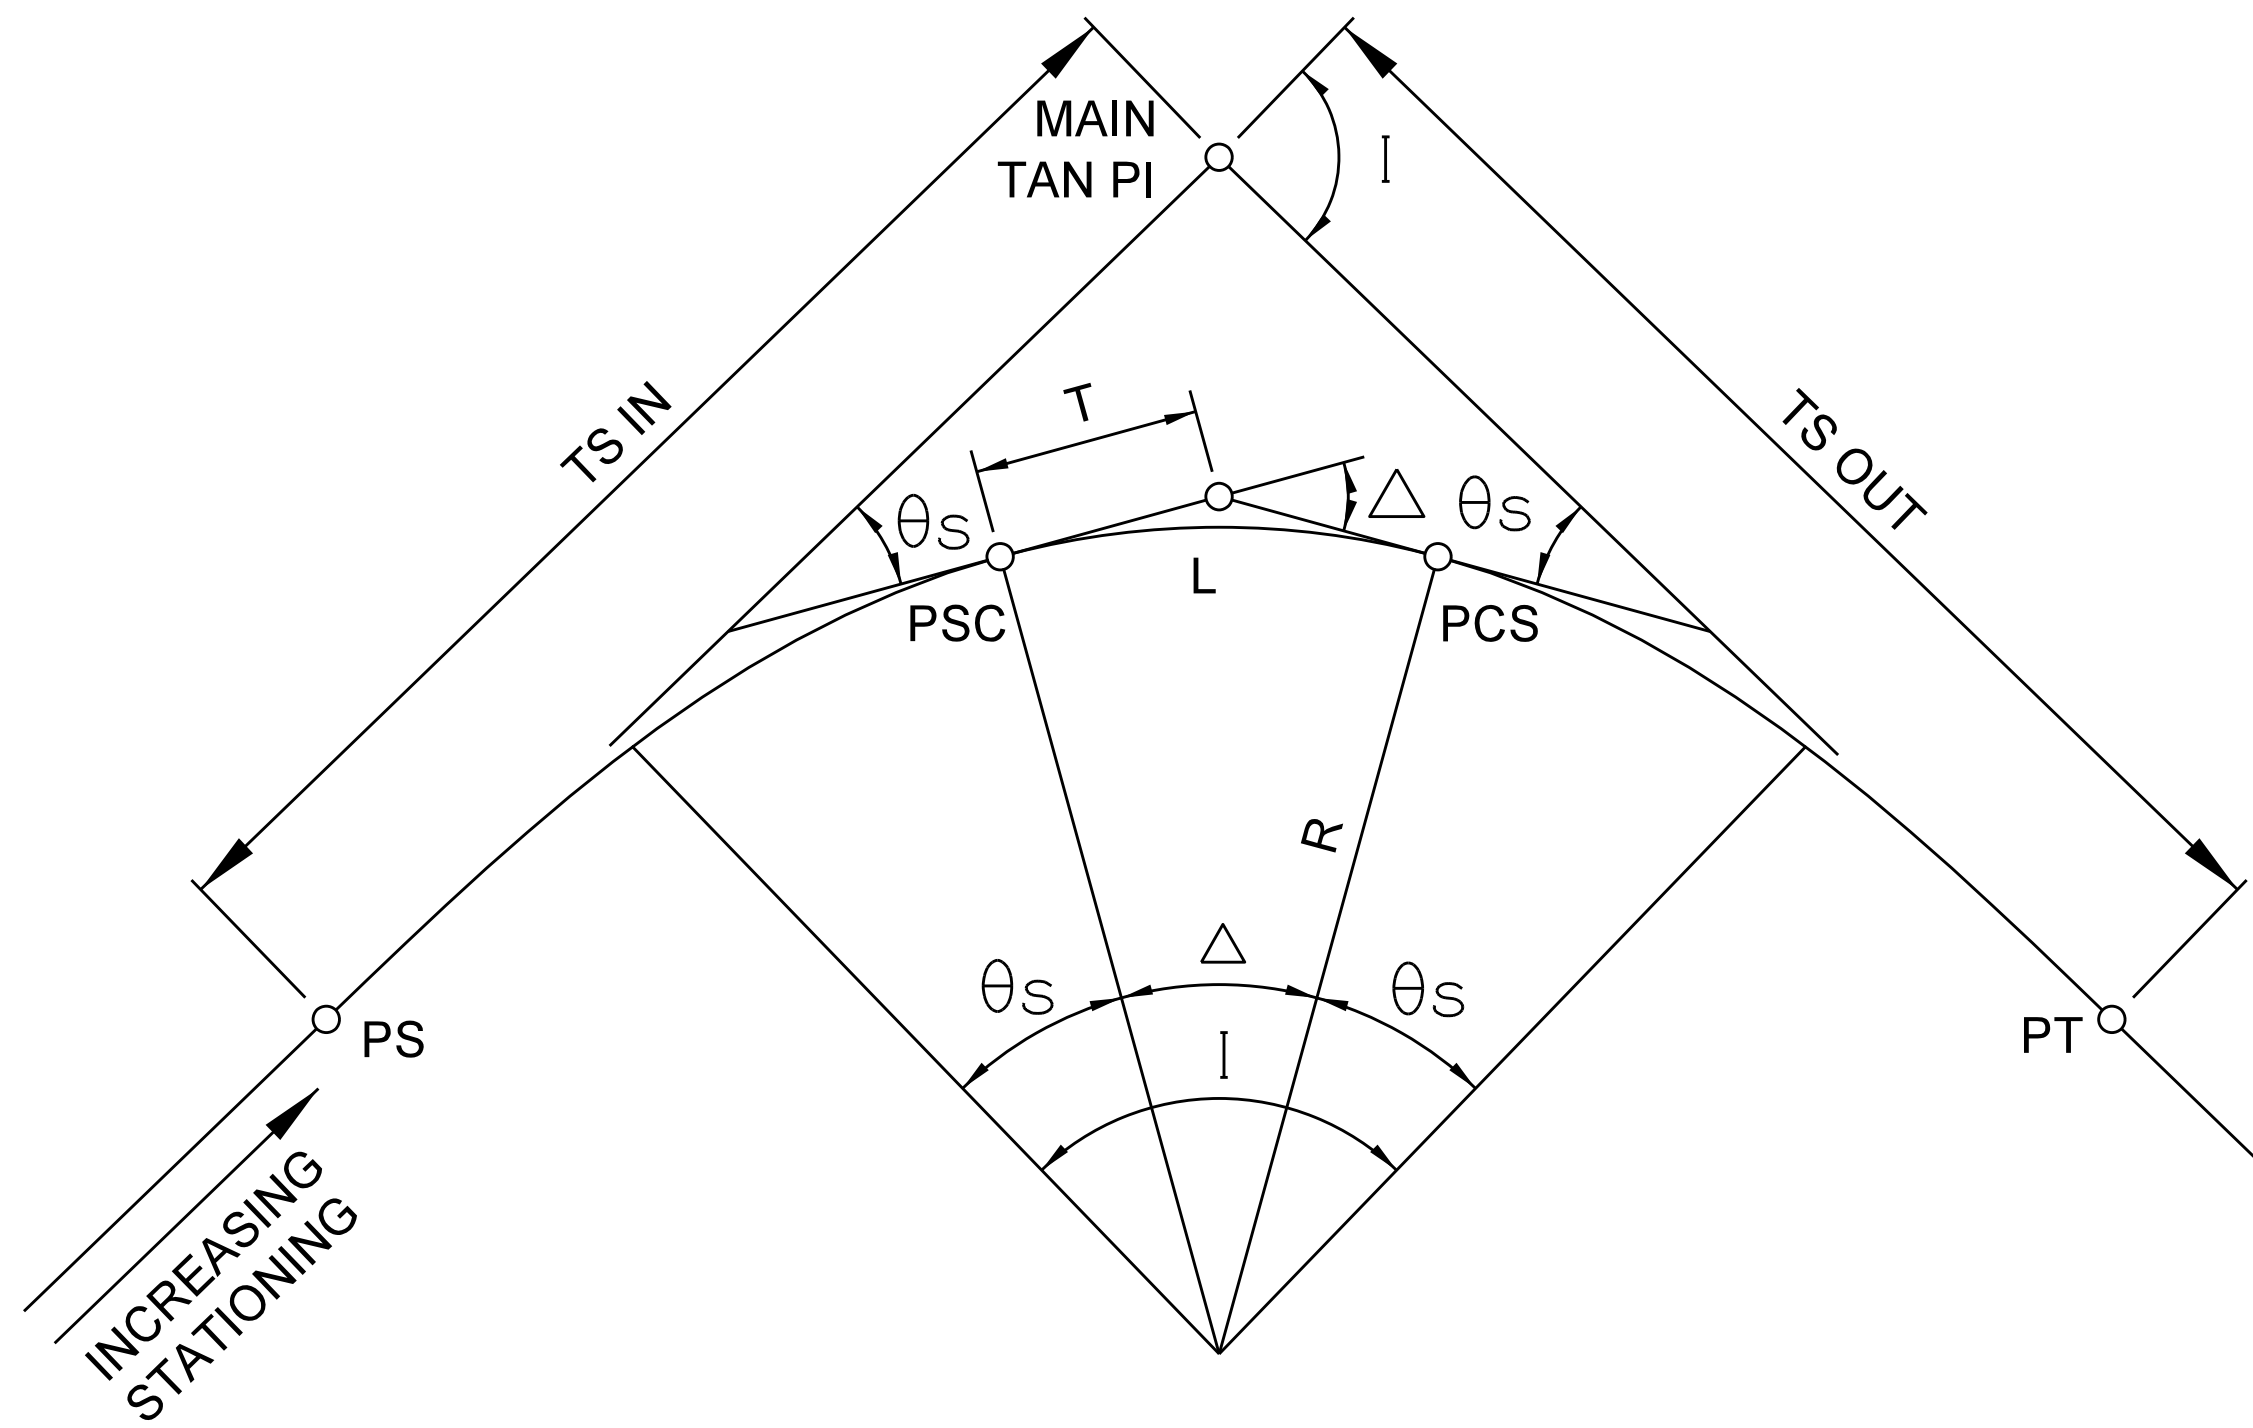


FIGURE A
CIRCULAR CURVES
WITH SPIRAL TRANSITION

I - TOTAL INTERSECTION ANGLE
 θ_s - SPIRAL ANGLE = $\frac{AL^2}{2}$
 Δ - CENTRAL ANGLE OF CIRCULAR CURVE = $I - 2\theta_s$
 D_c - DEGREE OF CURVE
 A - RATE OF CHANGE OF DEGREE OF CURVE PER 100-ft. OF LENGTH = $\frac{D_c}{L}$
 R - RADIUS OF CIRCULAR CURVE
 T - TANGENT LENGTH OF CIRCULAR CURVE = $R \tan \frac{\Delta}{2}$
 L - LENGTH OF CIRCULAR CURVE = $\frac{\Delta}{D_c} \times 100$
 PS - TANGENT TO SPIRAL
 PSC - SPIRAL TO CURVE
 PCS - CURVE TO SPIRAL
 PT - SPIRAL TO TANGENT
 MAIN TAN PI - POINT OF INTERSECTION OF MAIN TANGENTS
 (TS IN) - TANGENT LENGTH OF COMPLETE CURVE = $(R+o) \tan \frac{1}{2} I$
 (TS OUT)
 (WHEN SPIRALS OF EQUAL LENGTH ARE USED ON BOTH SIDES OF CIRCULAR CURVE, SEE FIGURE C. FOR o AND t).

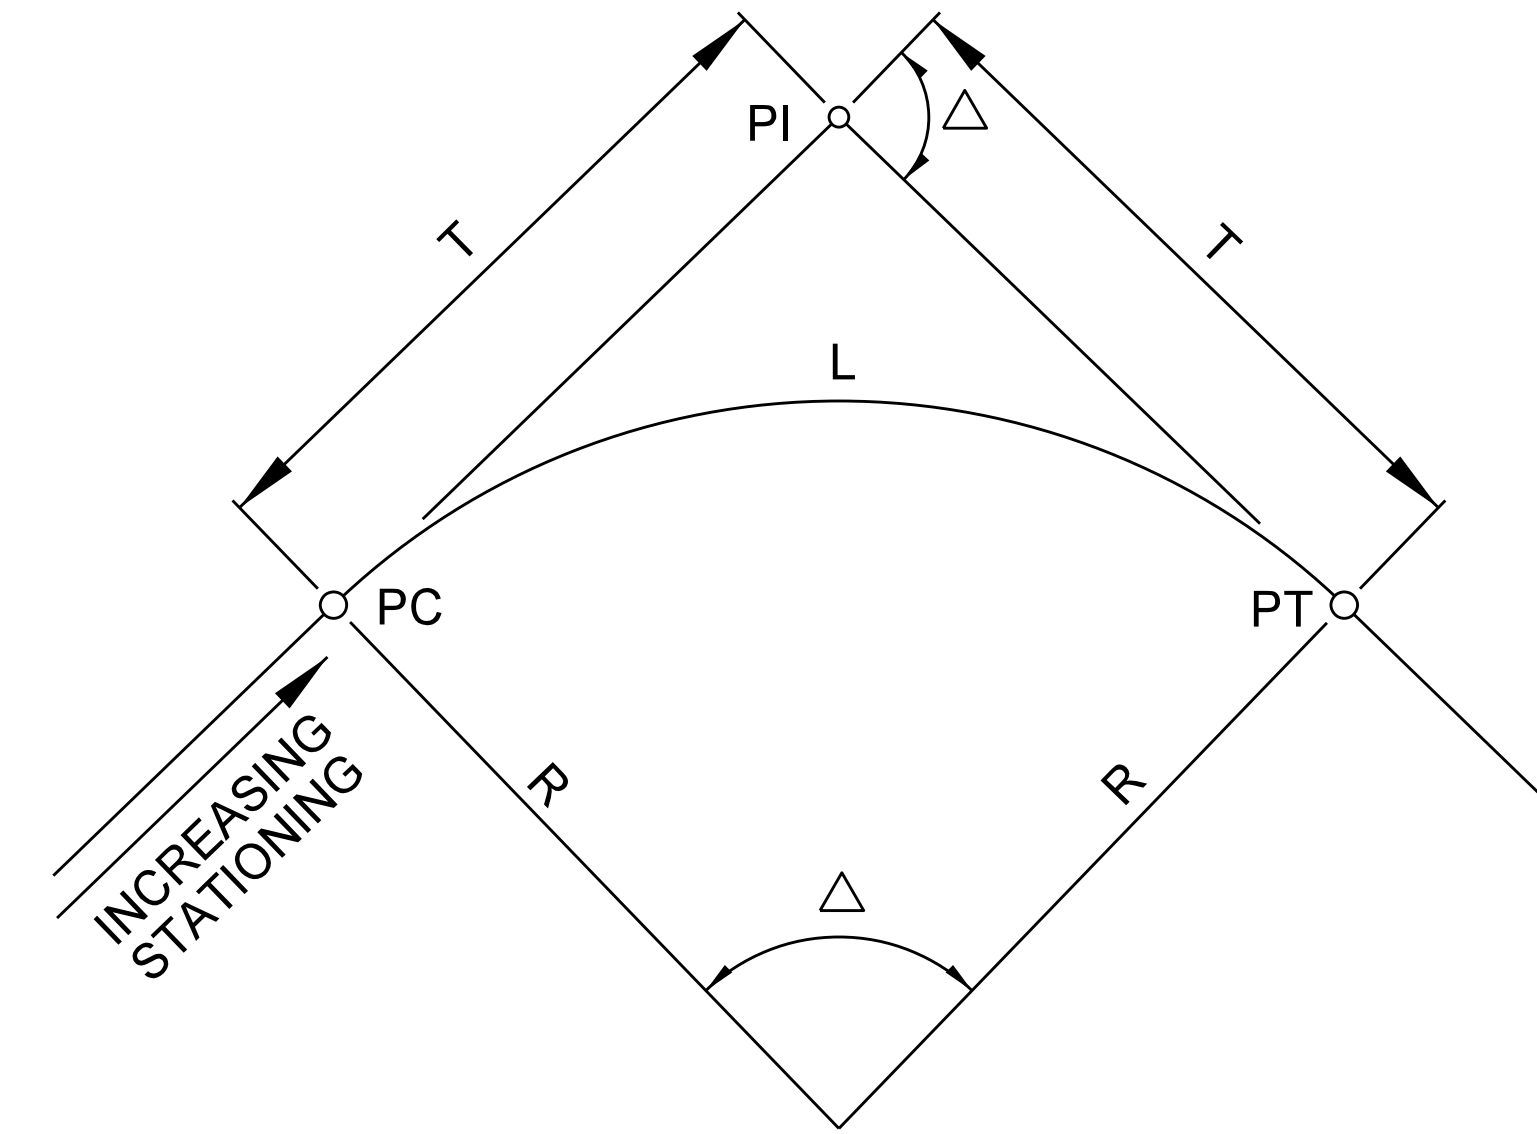


FIGURE B
SIMPLE CIRCULAR CURVE

R = RADIUS OF CIRCULAR CURVE
 Δ = CENTRAL ANGLE OF CIRCULAR CURVE
 $T = R \tan \frac{\Delta}{2}$
 $L = \frac{\Delta}{D_c} \times 100$
 $D_c = 2 \sin^{-1} (50/R) =$ DEGREE OF CURVE (CHORD DEFINITION)

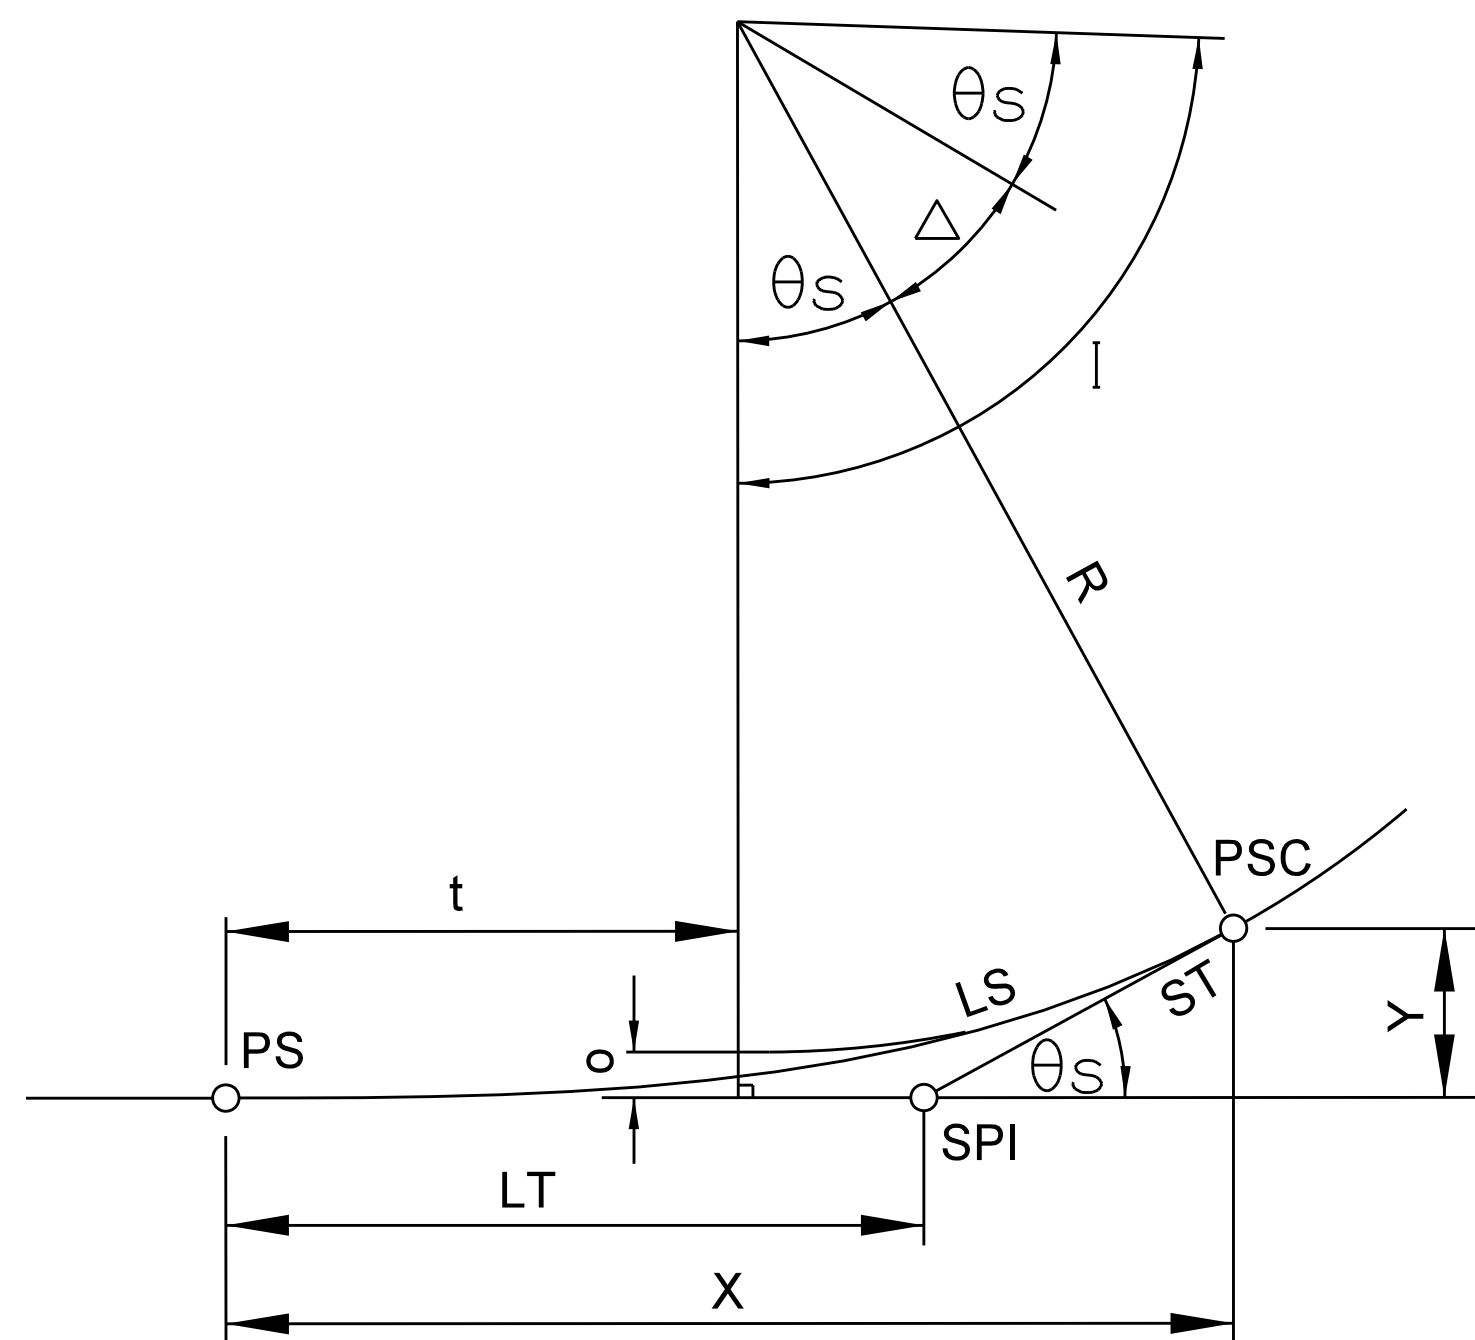


FIGURE C
SPIRAL TRANSITION CURVE


SPIRAL TRANSITION CURVE DATA:
 THE SPIRAL USED IS DEFINED BY THE TALBOT SPIRAL.

LS = LENGTH OF SPIRAL (TS TO PSC)
 $\theta_s = \frac{AL^2}{2}$
 $X = 100 L_1 - 0.000762A L_1^5$
 $Y = 0.291AL_1^3 - 0.0000158A L_1^7$
 $o = 0.0727AL_1^3$
 $t = 50L_1 - 0.000127A L_1^5$
 $ST = \frac{Y}{\sin \theta_s}$
 $LT = X - \frac{Y}{\tan \theta_s}$
 $D_c = 2 \sin^{-1} (50/R) =$ DEGREE OF CURVE (CHORD DEFINITION)
 L_1 - TOTAL NO. OF STATIONS IN SPIRAL
 SPI - SPIRAL POINT OF INTERSECTION
 NOTE: D_c , θ_s , Δ AND I ARE IN DEGREES.
 ALL OTHERS DIMENSIONS ARE FEET.

ISSUED FOR BID


		URBAN ENGINEERS, INC. 530 Walnut Street Philadelphia, PA 19106 (215) 922-8080 Fax (215) 922-8082
	LOCATION CAMDEN, N.J.	TITLE S.J.P.C. BALZANO MARINE TERMINAL RAIL INFRASTRUCTURE REHABILITATION TRACKWORK GEOMETRY DEFINITIONS
EWN CRK	PROJ # DATE	DRAWING NUMBER G-03

REV	BY	DATE	DESCRIPTION

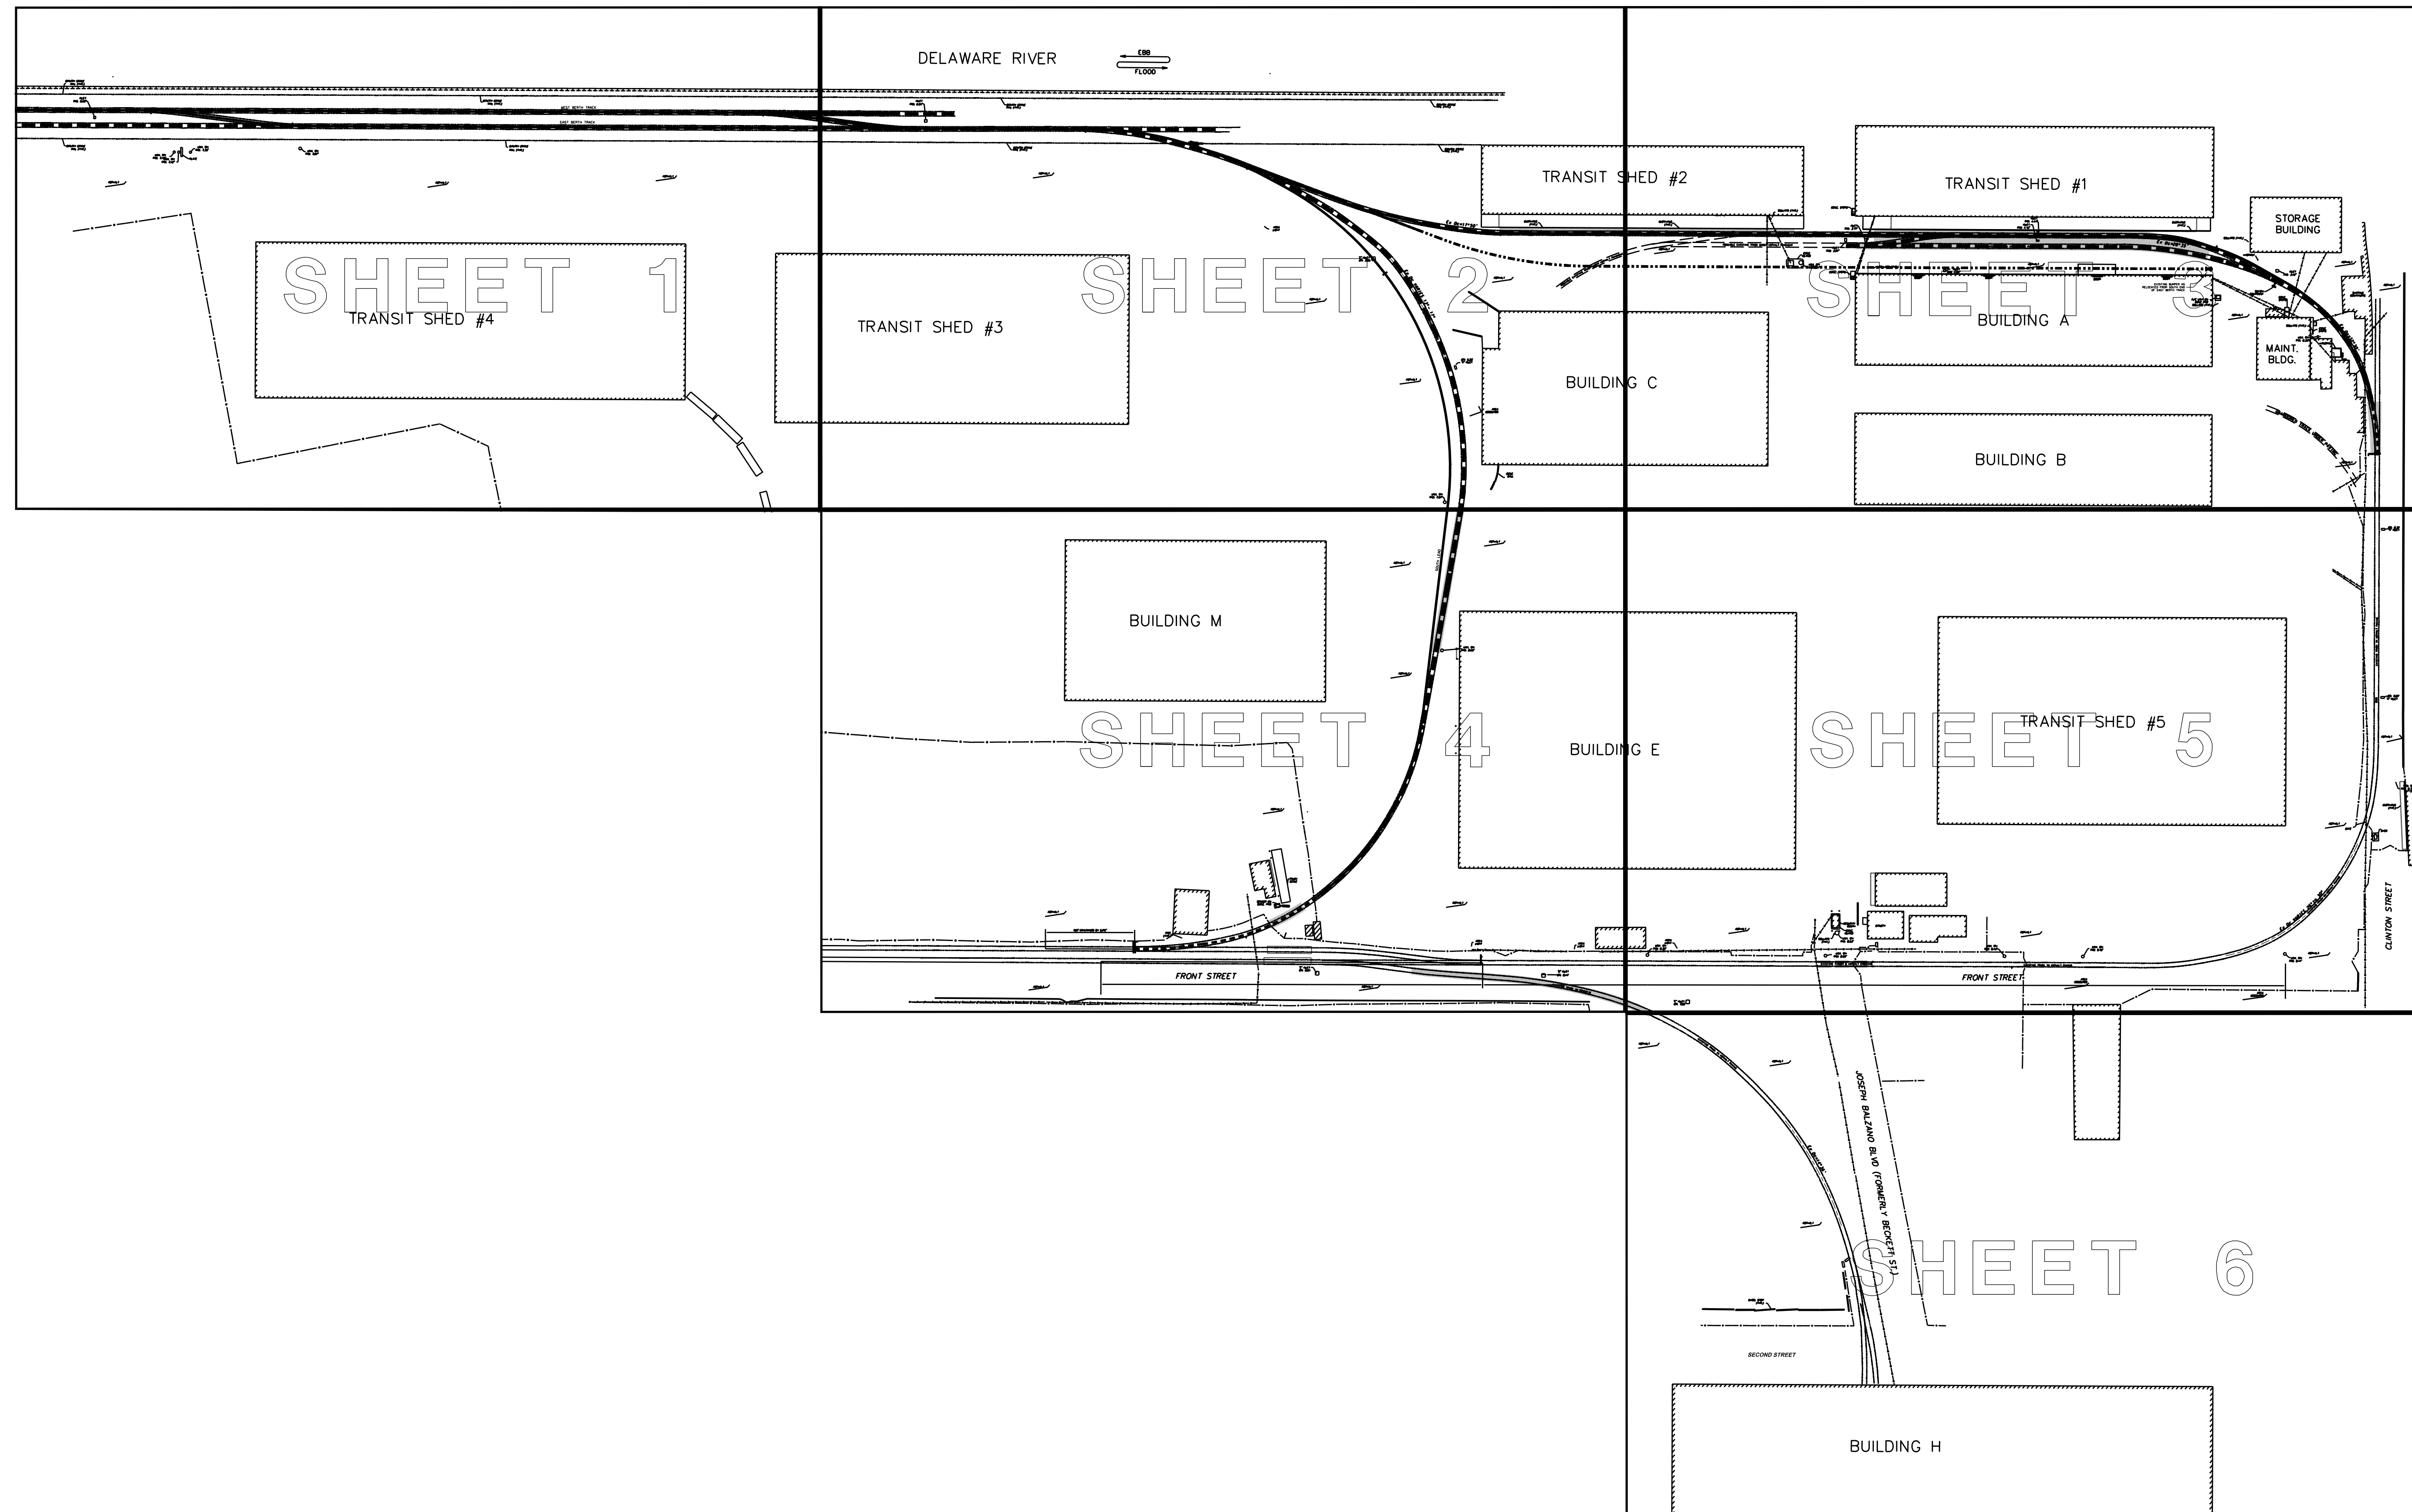

ISSUED FOR BID




URBAN ENGINEERS URBAN ENGINEERS, INC.
 530 Walnut Street
 Philadelphia, PA 19106
 (215) 922-8080 Fax (215) 922-8082

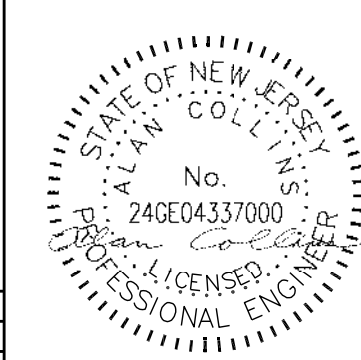

LOCATION: CAMDEN, N.J.
 TITLE: S.J.P.C. BALZANO MARINE TERMINAL RAIL INFRASTRUCTURE REHABILITATION DRAWING SHEET INDEX

REV	BY	DATE	DESCRIPTION

OWN	FST	PROJ #	DRAWING NUMBER
CRK	DATE		G-04

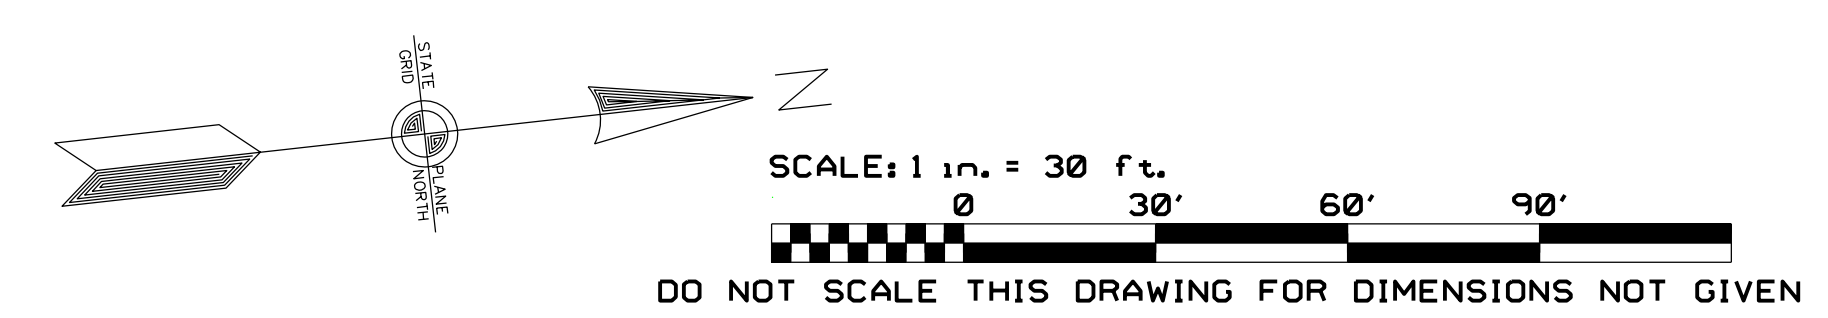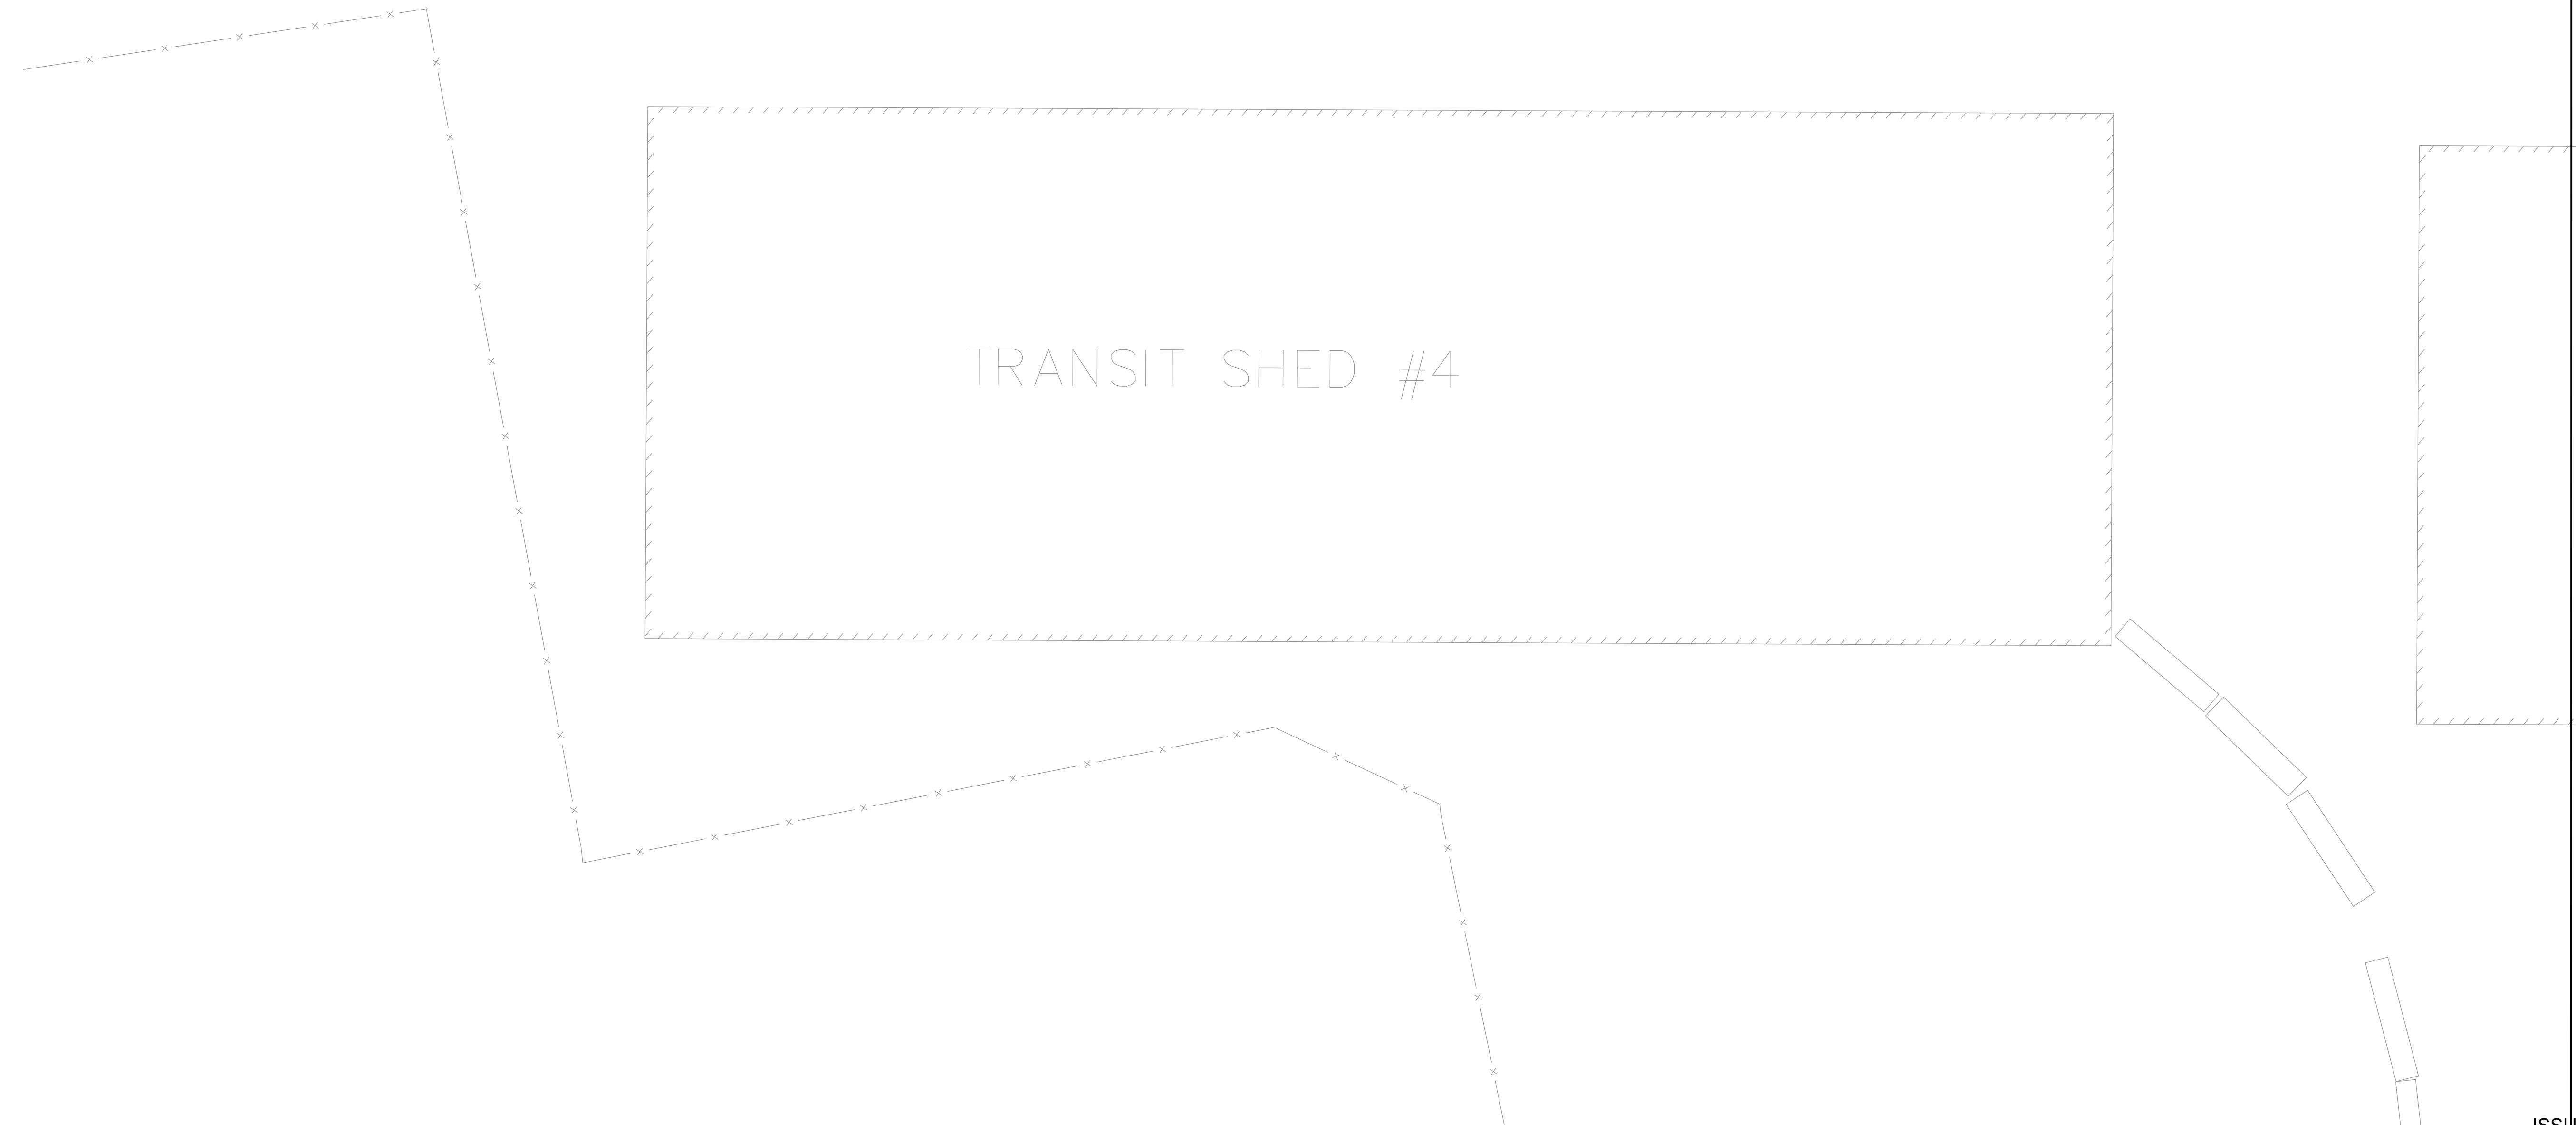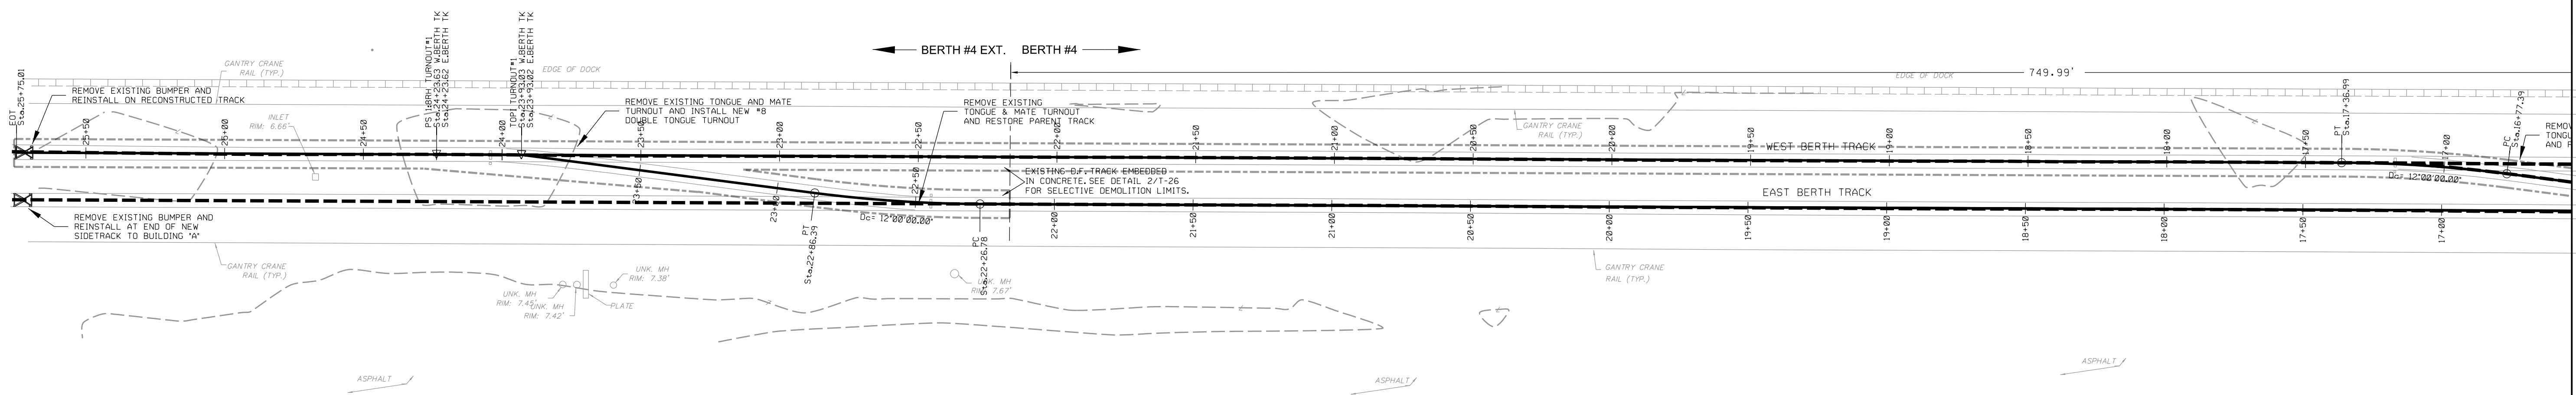

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		URBAN ENGINEERS, INC. 530 Walnut Street Philadelphia, PA 19106 (215) 922-8080 Fax (215) 922-8082
	LOCATION CAMDEN, N.J.	TITLE S.J.P.C. BALZANO MARINE TERMINAL RAIL INFRASTRUCTURE REHABILITATION PROPOSED TRACK CONSTRUCTION
EWN CRK	PROJ # DATE	DRAWING NUMBER T-1


REV	BY	DATE	DESCRIPTION

SHEET 1

MATCH LINE

MATCH LINE

DELAWARE RIVER

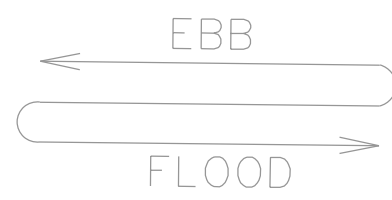

BERTH #4 BERTH #3

491.00'

BERTH #3 BERTH #2

63.25'

FACE OF SHED #1

TRANSIT S

TRANSIT SHED #3



BUILDING

SHEET 3

MATCH LINE


SHEET 4

ISSUED FOR BID

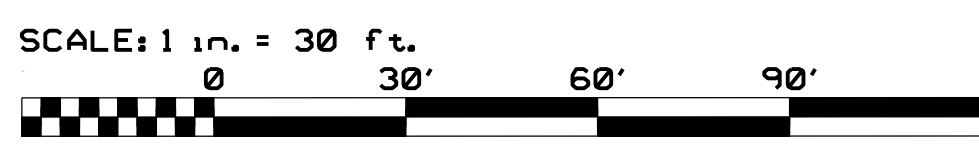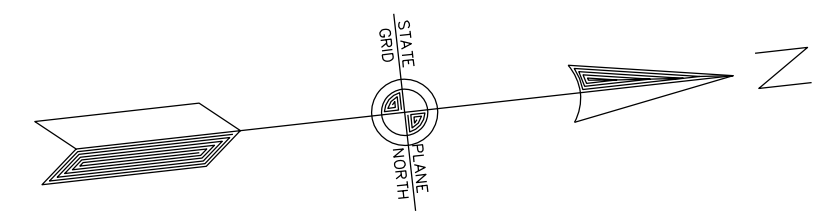

DO NOT SCALE THIS DRAWING FOR DIMENSIONS NOT GIVEN

REV	BY	DATE	DESCRIPTION

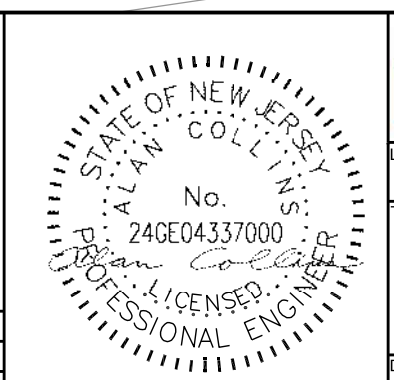

URBAN ENGINEERS, INC.
 530 Walnut Street
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 (215) 922-8080 Fax (215) 922-8082


LOCATION: **CAMDEN, N.J.**

TITLE: **S.J.P.C. BALZANO MARINE TERMINAL RAIL INFRASTRUCTURE REHABILITATION PROPOSED TRACK CONSTRUCTION**



DATE: _____

DRAWING NUMBER: **T-2**

X:\2021\50094\000 - sjc balzano rail rehab\technical\dwg\enr\EBHTTLEBLOCK4K22.dwg

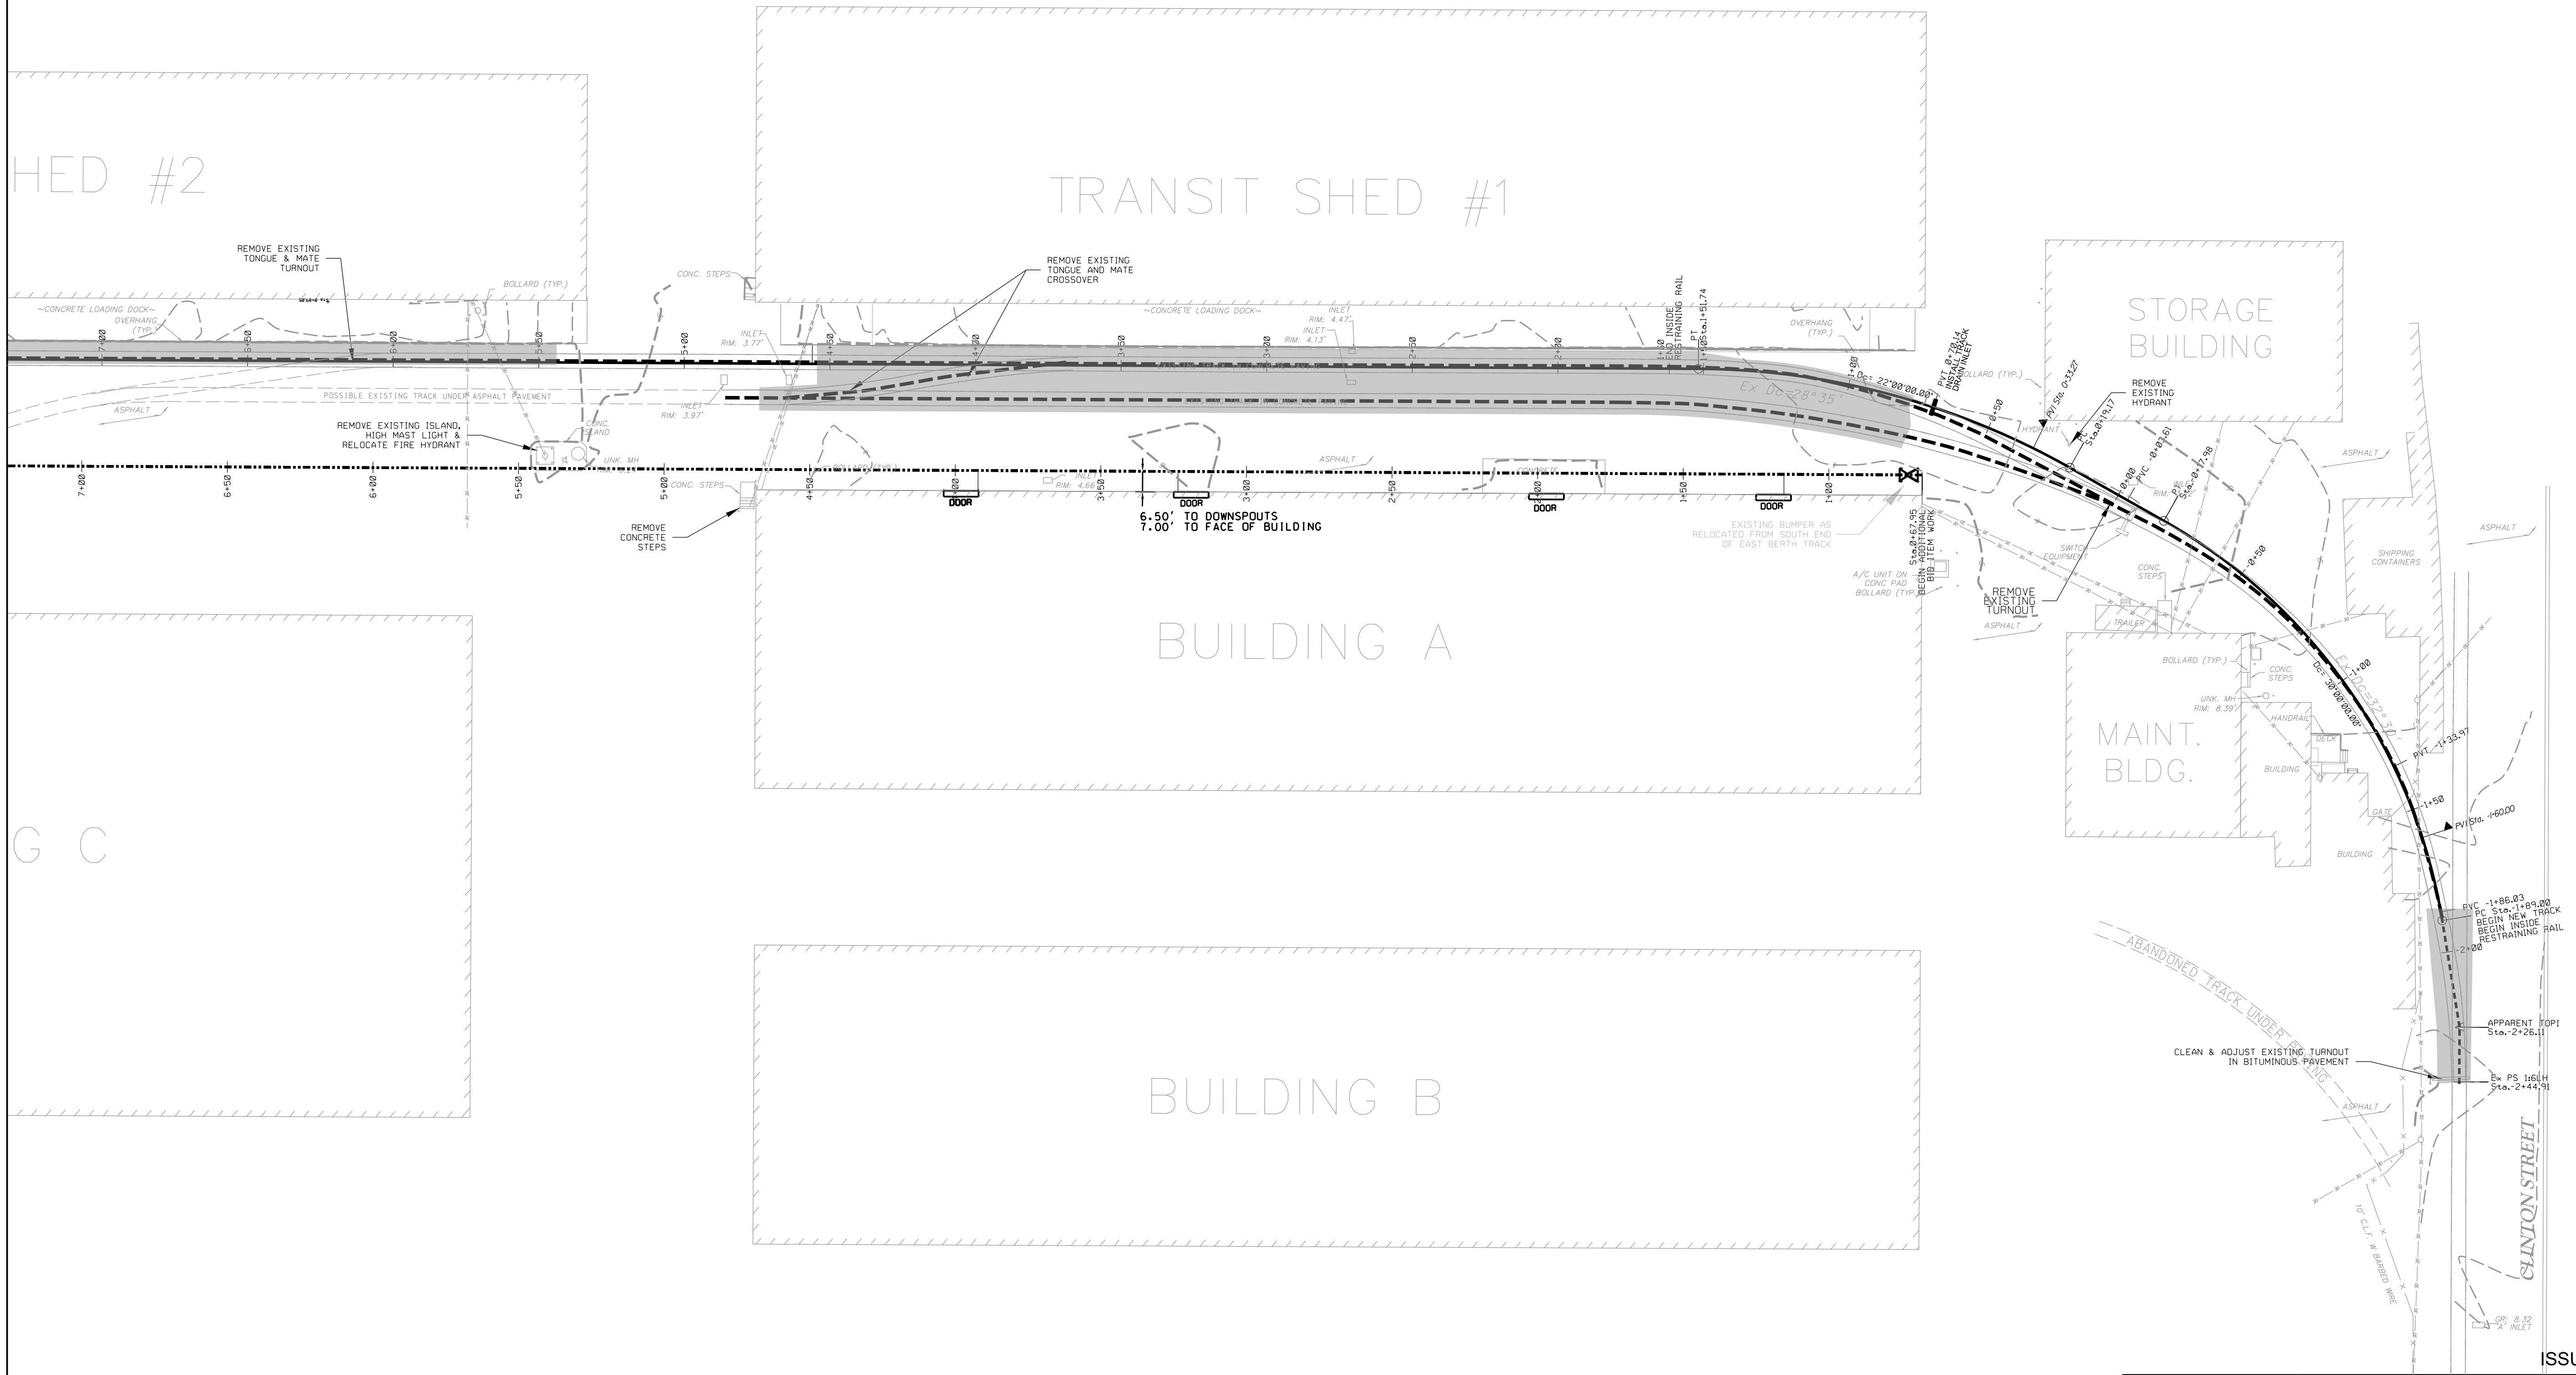


MATCH LINE

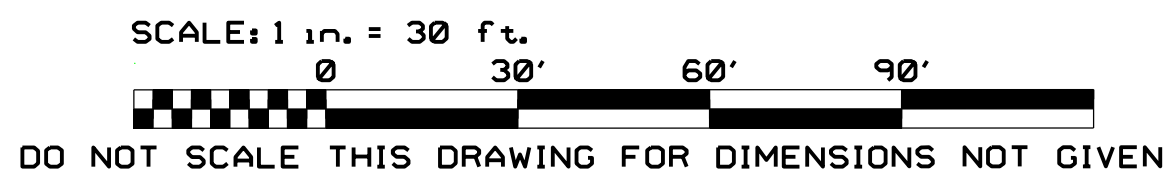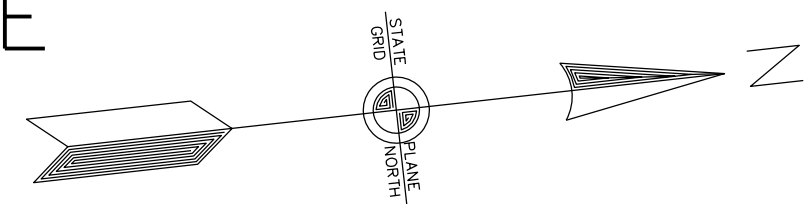

SHEET 5

ISSUED FOR BID

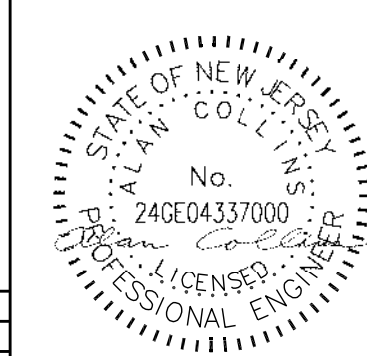



URBAN ENGINEERS, INC.
 530 Walnut Street
 Philadelphia, PA 19106
 (215) 922-8080 Fax (215) 922-8082

LOCATION: **CAMDEN, N.J.**

TITLE: **S.J.P.C. BALZANO MARINE TERMINAL RAIL INFRASTRUCTURE REHABILITATION PROPOSED TRACK CONSTRUCTION**

OWN	FST	PROJ #	DRAWING NUMBER
CRK	DATE		T-3

REV	BY	DATE	DESCRIPTION

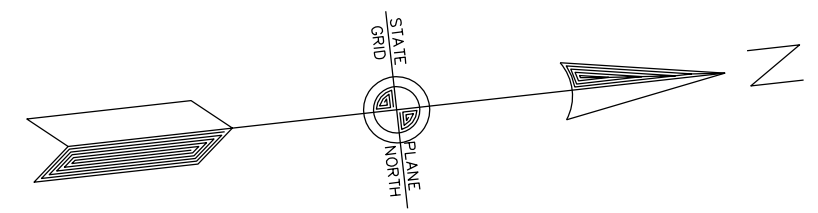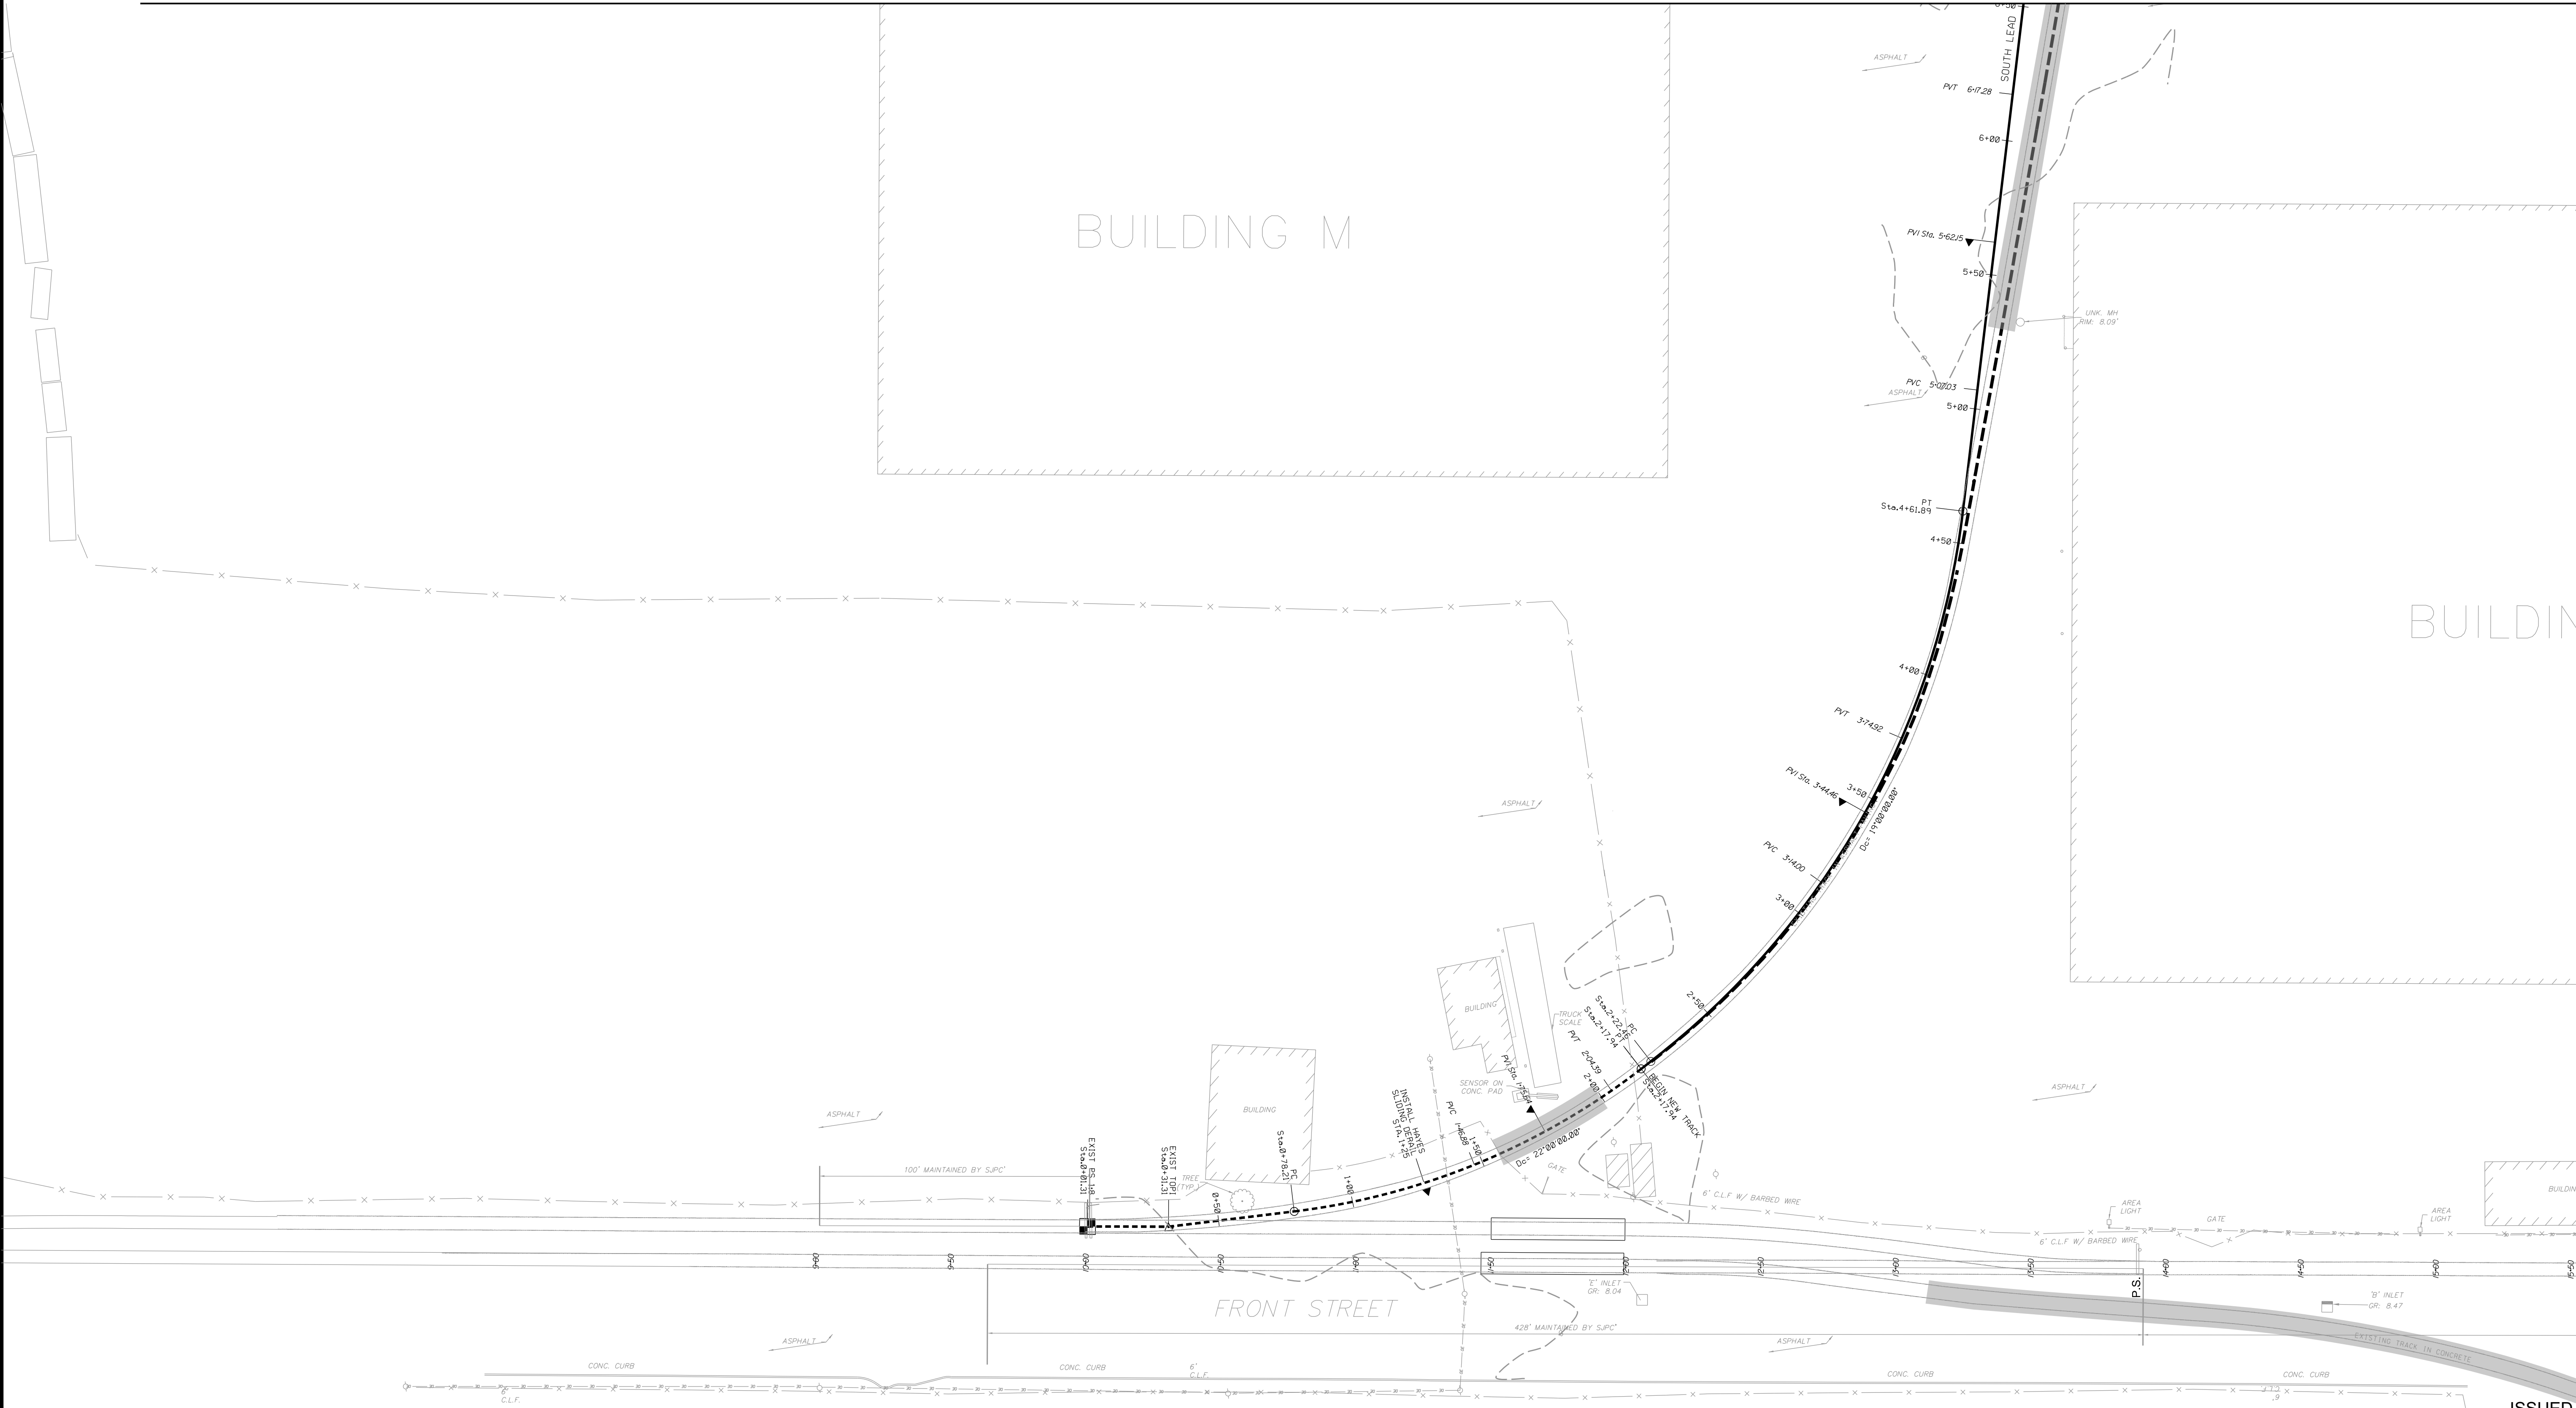

SCALE: 1 in. = 30 ft.

0 30' 60' 90'

DO NOT SCALE THIS DRAWING FOR DIMENSIONS NOT GIVEN

REV	BY	DATE	DESCRIPTION

STATE OF NEW JERSEY
A. LAW COL'NS.
No. 24604337000
S.J.P.C. BALZANO
LICENSED PROFESSIONAL ENGINEER


URBAN ENGINEERS, INC.
530 Walnut Street
Philadelphia, PA 19106
(215) 922-8080 Fax (215) 922-8082

LOCATION	CAMDEN, N.J.		
TITLE	S.J.P.C. BALZANO MARINE TERMINAL RAIL INFRASTRUCTURE REHABILITATION PROPOSED TRACK CONSTRUCTION		
OWN	FST	PROJ #	DRAWING NUMBER
CHK	DATE		T-4

MATCH LINE

SHEET 3

SHEET 4


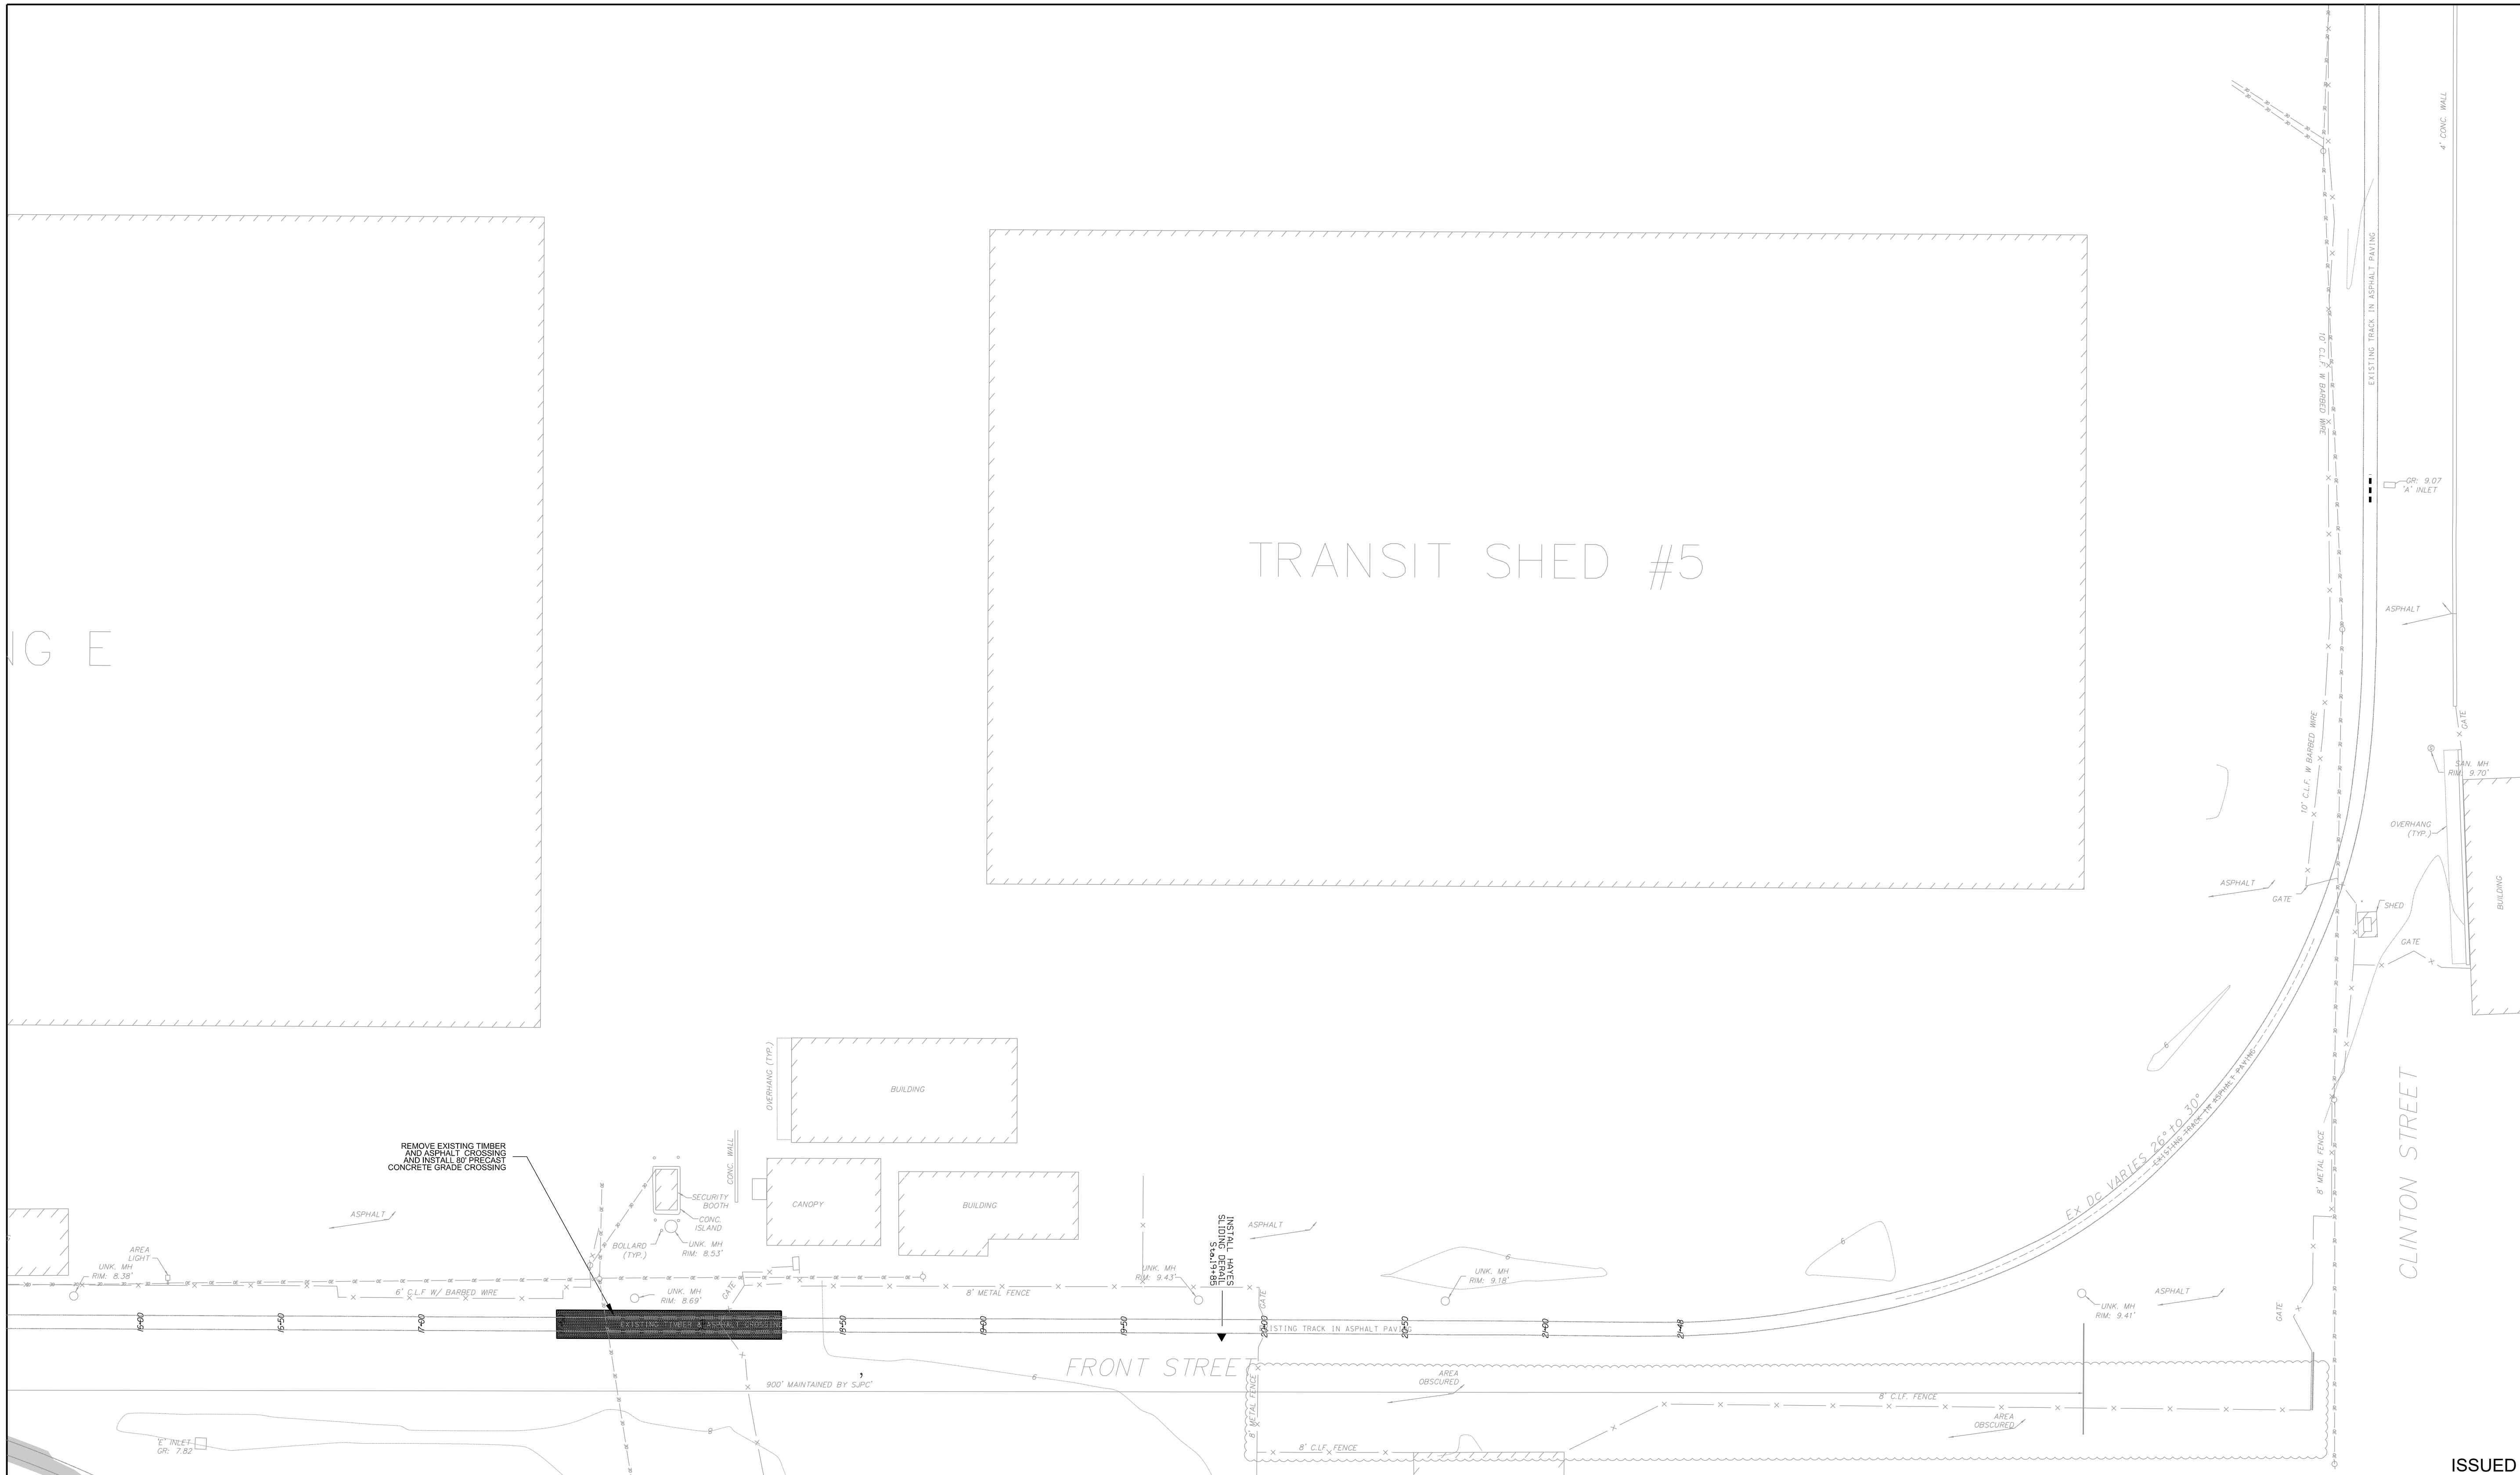


MATCH LINE


MATCH LINE

SHEET 6

ISSUED FOR BID

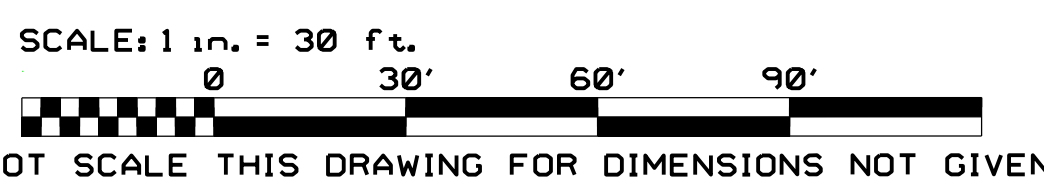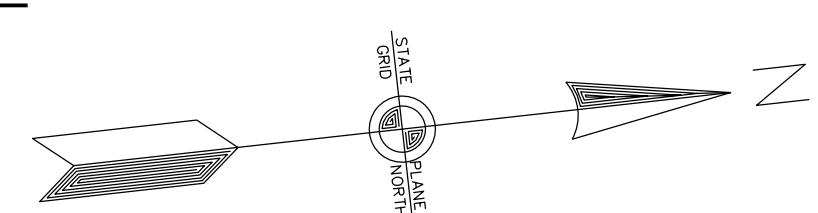

REV	BY	DATE	DESCRIPTION

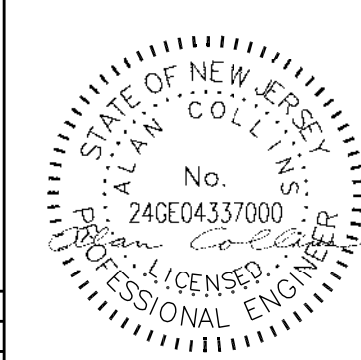

URBAN ENGINEERS, INC.
 530 Walnut Street
 Philadelphia, PA 19106
 (215) 922-8080 Fax (215) 922-8082

LOCATION: CAMDEN, N.J.
 TITLE: S.J.P.C. BALZANO MARINE TERMINAL RAIL INFRASTRUCTURE REHABILITATION PROPOSED TRACK CONSTRUCTION

DATE: 1/11/11
 DRAWING NUMBER: T-5


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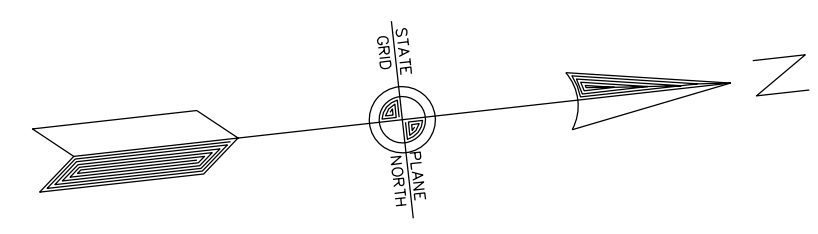
NO WORK THIS SHEET

ISSUED FOR BID

URBAN ENGINEERS, INC.
 530 Walnut Street
 Philadelphia, PA 19106
 (215) 922-8080 Fax (215) 922-8082



LOCATION	CAMDEN, N.J.	
TITLE	S.J.P.C. BALZANO MARINE TERMINAL RAIL INFRASTRUCTURE REHABILITATION PROPOSED TRACK CONSTRUCTION	
DWN	FST	PROJ #
CRK	DATE	DRAWING NUMBER
		T-6

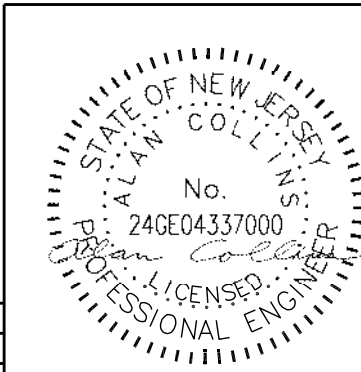

SCALE: 1 in. = 30 ft.
 DO NOT SCALE THIS DRAWING FOR DIMENSIONS NOT GIVEN

REV	BY	DATE	DESCRIPTION

Horizontal Alignment Name: Pr-South Lead

Table with columns: STATION, NORTHING, EASTING. Elements include TANGENT, CURVE, and TANGENT with various sub-elements like APPARANT TOPI, PC, PI, CC, PT, and detailed curve data (Radius, Delta, Degree of Curvature, etc.).

Horizontal Alignment Name: Pr-Shed 1-2 Lead

Table with columns: STATION, NORTHING, EASTING. Elements include TANGENT, CURVE, and TANGENT with various sub-elements and detailed curve data.

Horizontal Alignment Name: Pr-West Berth Track Extended

Table with columns: STATION, NORTHING, EASTING. Elements include TANGENT, CURVE, and TANGENT with various sub-elements and detailed curve data.


Horizontal Alignment Name: Pr-Building A Lead

Table with columns: STATION, NORTHING, EASTING. Elements include TANGENT, CURVE, and TANGENT with various sub-elements and detailed curve data.

Horizontal Alignment Name: Pr-East Berth Track



Table with columns: STATION, NORTHING, EASTING. Elements include TANGENT, CURVE, and TANGENT with various sub-elements and detailed curve data.

ISSUED FOR BID

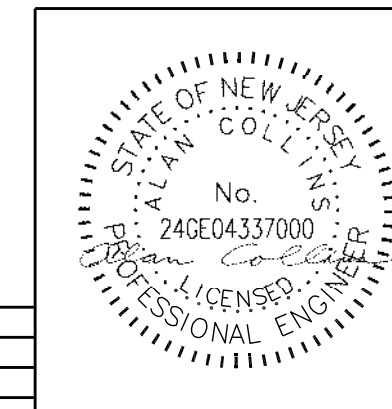


URBAN ENGINEERS, INC. logo and contact information. Project title: S.J.P.C. BALZANO MARINE TERMINAL RAIL INFRASTRUCTURE REHABILITATION HORIZONTAL TRACK GEOMETRY DATA. Drawing number: T-10.

Table with columns: REV, BY, DATE, DESCRIPTION. Contains revision history entries.

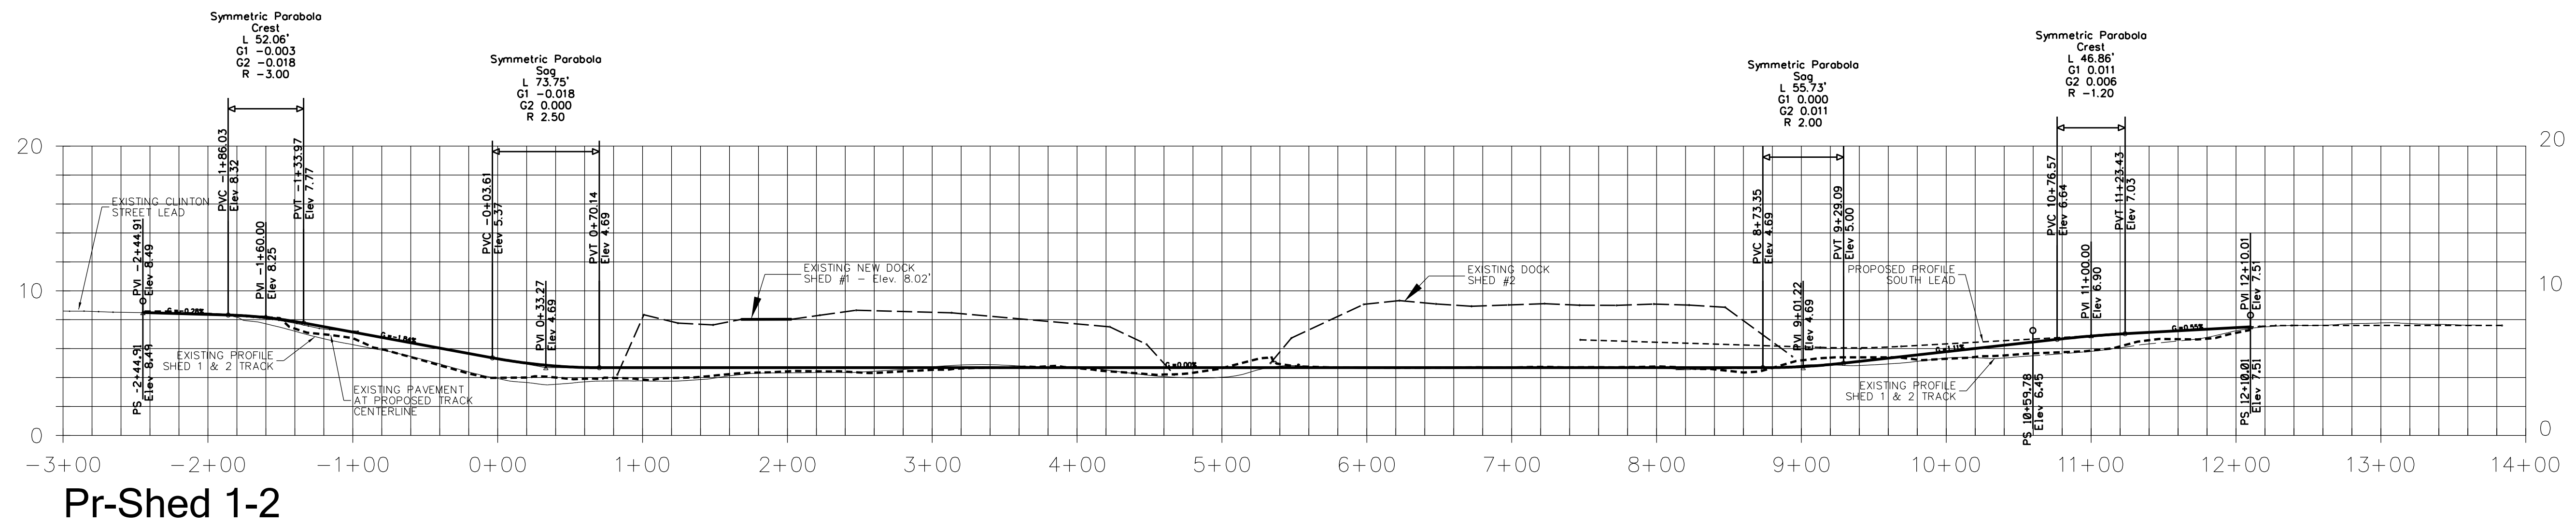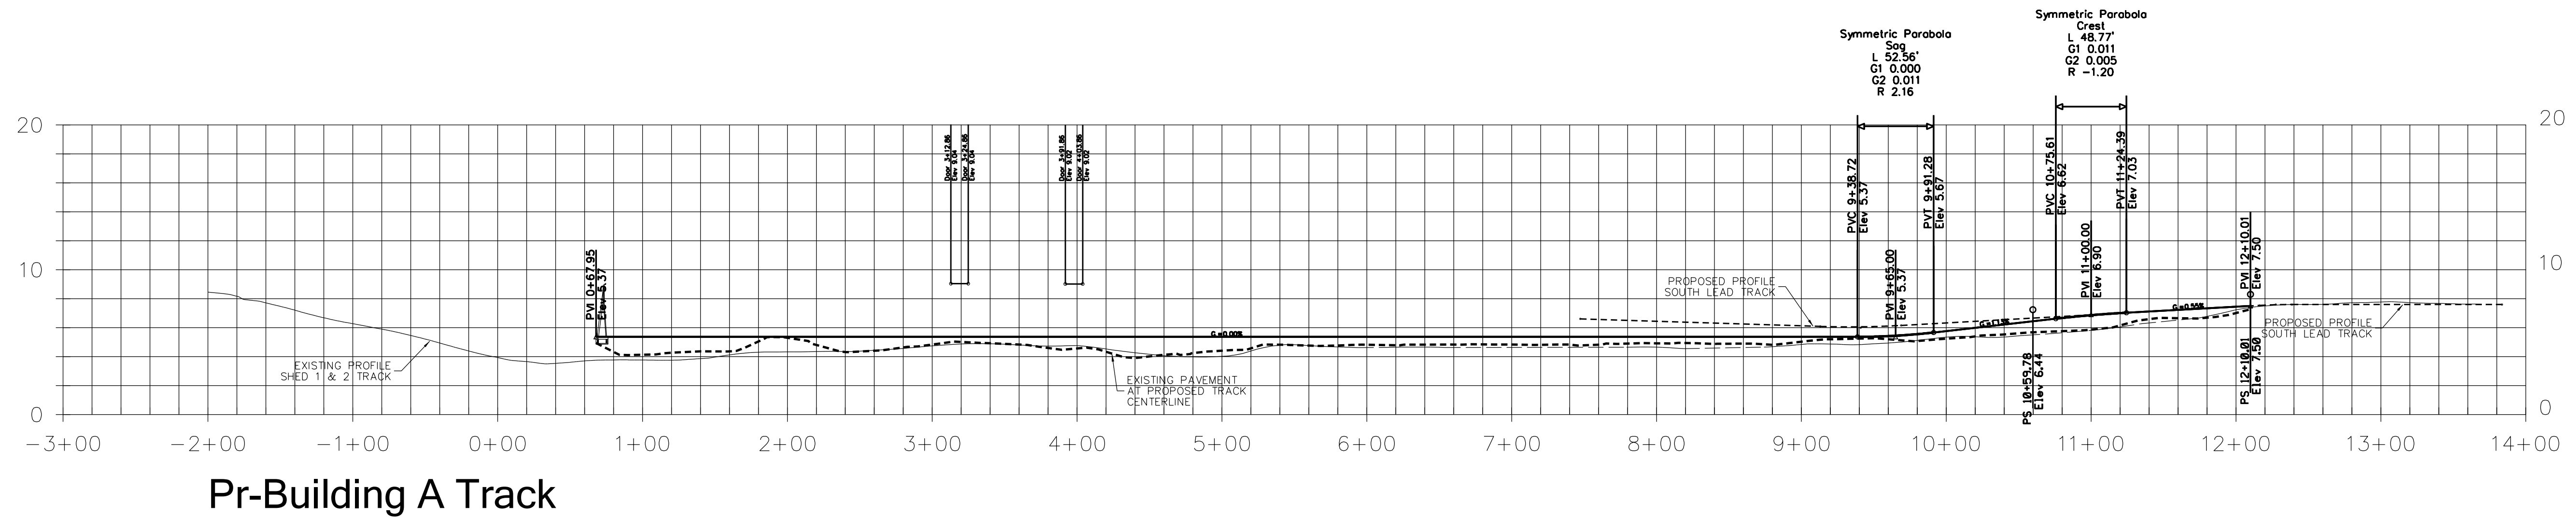

REV	BY	DATE	DESCRIPTION

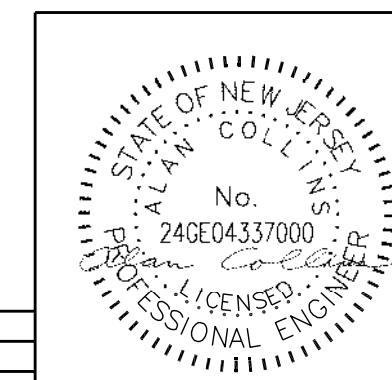

URBAN ENGINEERS, INC.
 530 Walnut Street
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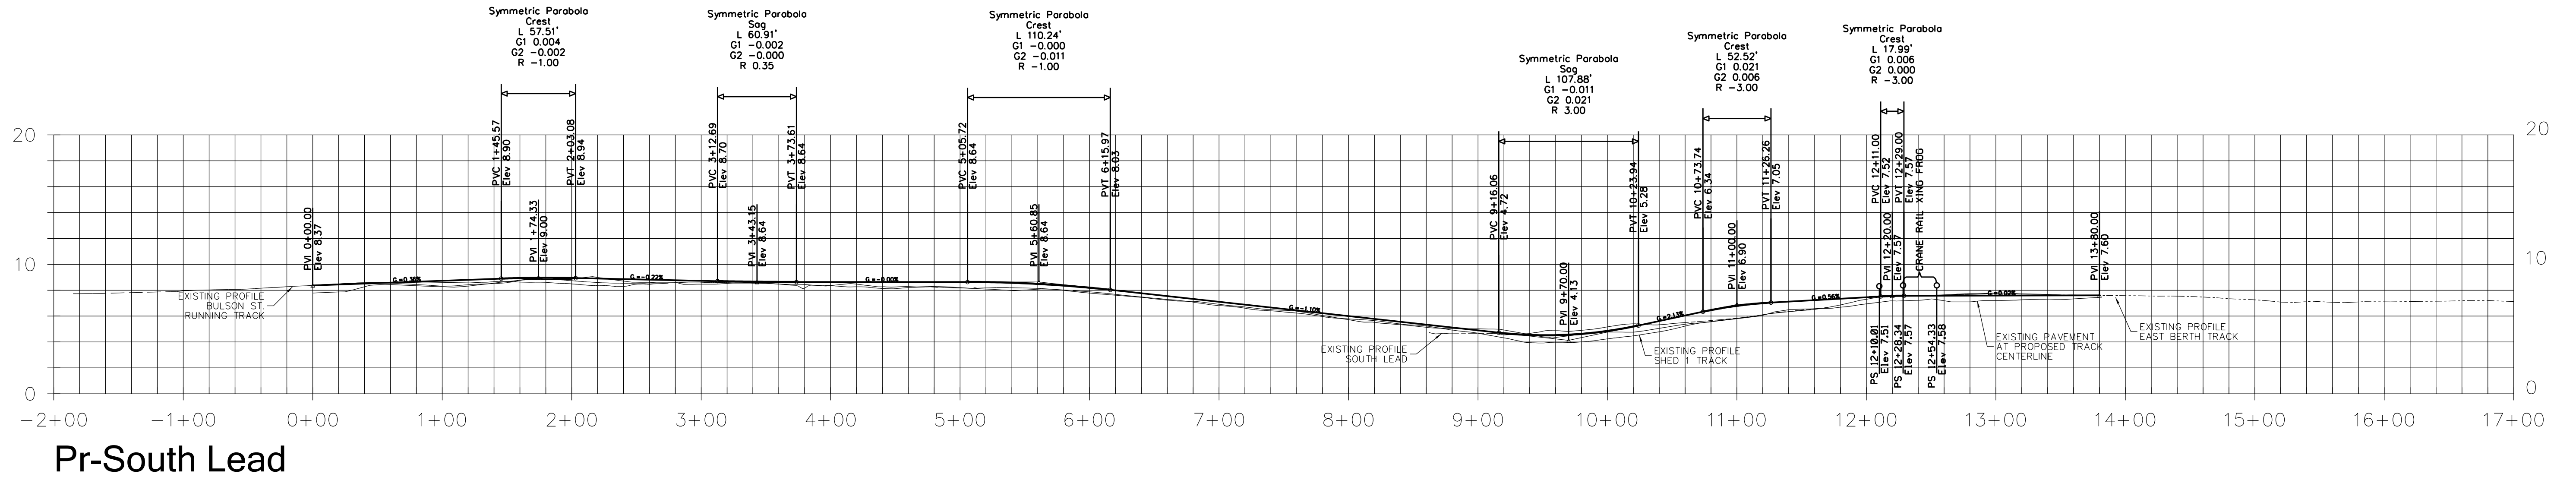
LOCATION: **CAMDEN, N.J.**

TITLE: **S.J.P.C. BALZANO MARINE TERMINAL RAIL INFRASTRUCTURE REHABILITATION PROPOSED TOP OF RAIL PROFILES - 1 OF 2**


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CRK: DATE


ISSUED FOR BID



Pr-South Lead

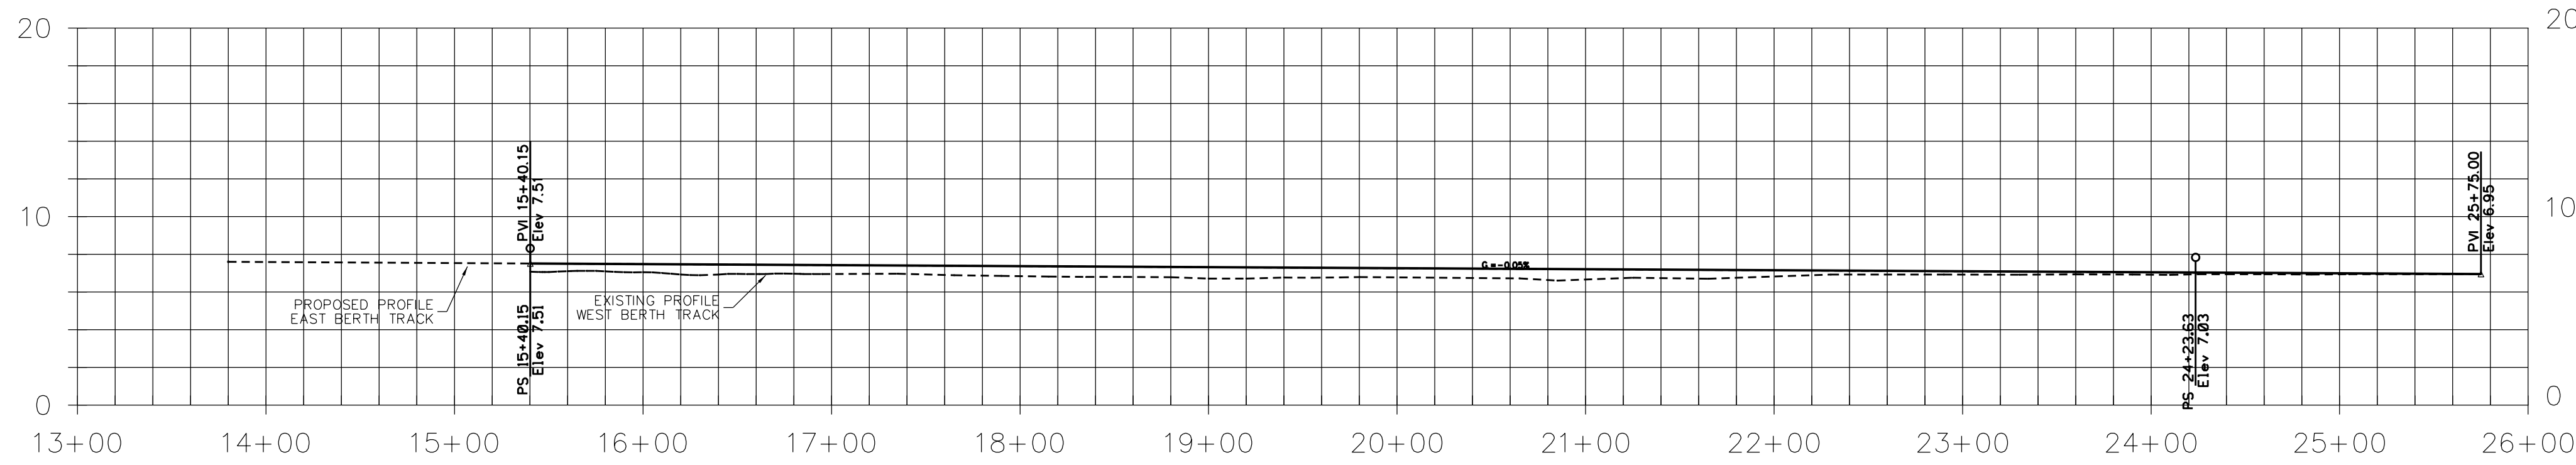

Pr-West Berth Track

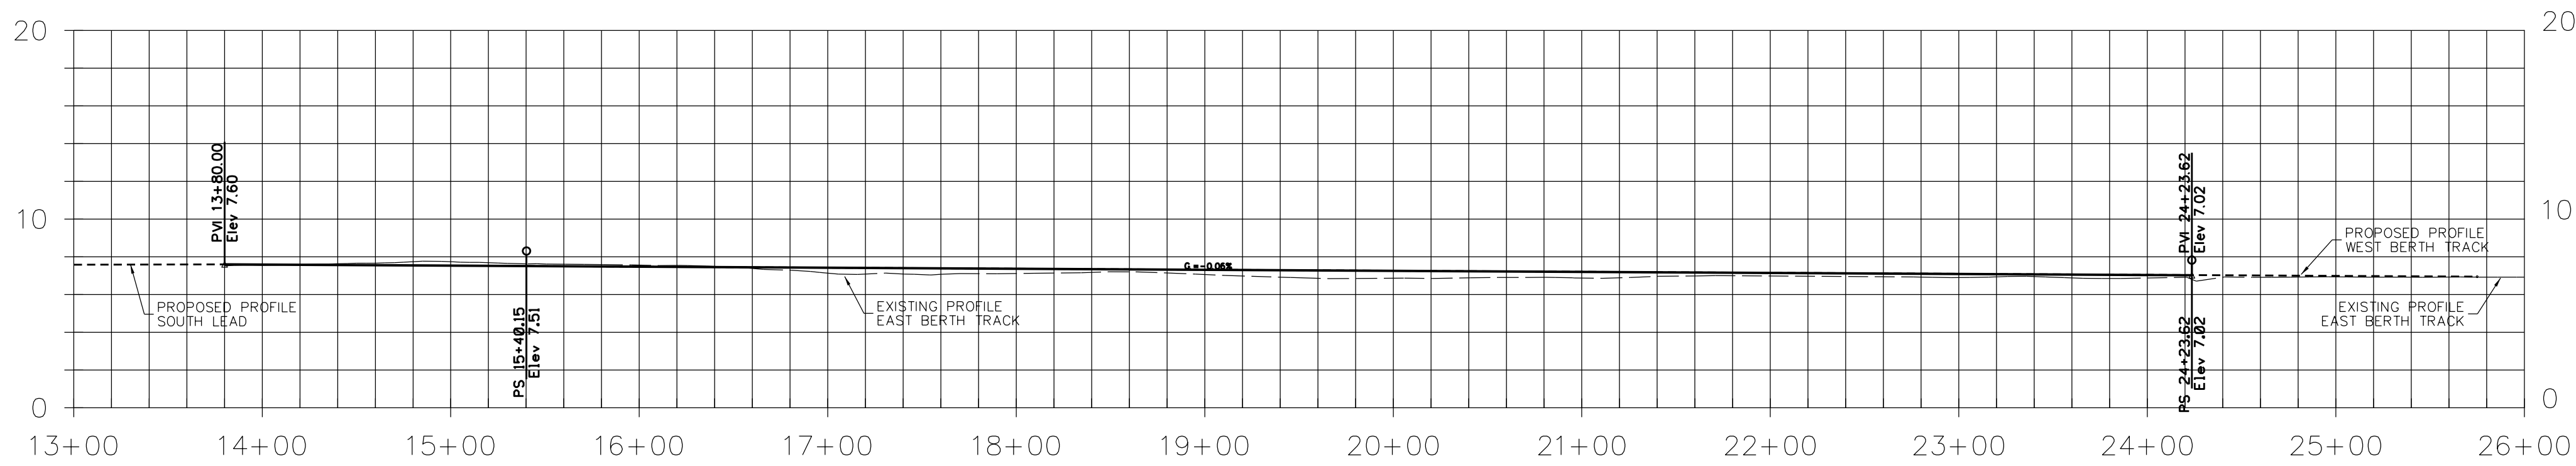

Pr-East Berth Track

REV	BY	DATE	DESCRIPTION

ISSUED FOR BID


URBAN ENGINEERS URBAN ENGINEERS, INC.
 530 Walnut Street
 Philadelphia, PA 19106
 (215) 922-8080 Fax (215) 922-8082

LOCATION: CAMDEN, N.J.

TITLE: S.J.P.C. BALZANO MARINE TERMINAL RAIL INFRASTRUCTURE REHABILITATION PROPOSED TOP OF RAIL PROFILES - 2 OF 2


DWN: FST PROJ # 24604337000 DRAWING NUMBER T-14
 CRK: DATE

STATE OF NEW JERSEY
 JAMES J. COUGHLIN
 No. 24604337000
 REGISTERED PROFESSIONAL ENGINEER

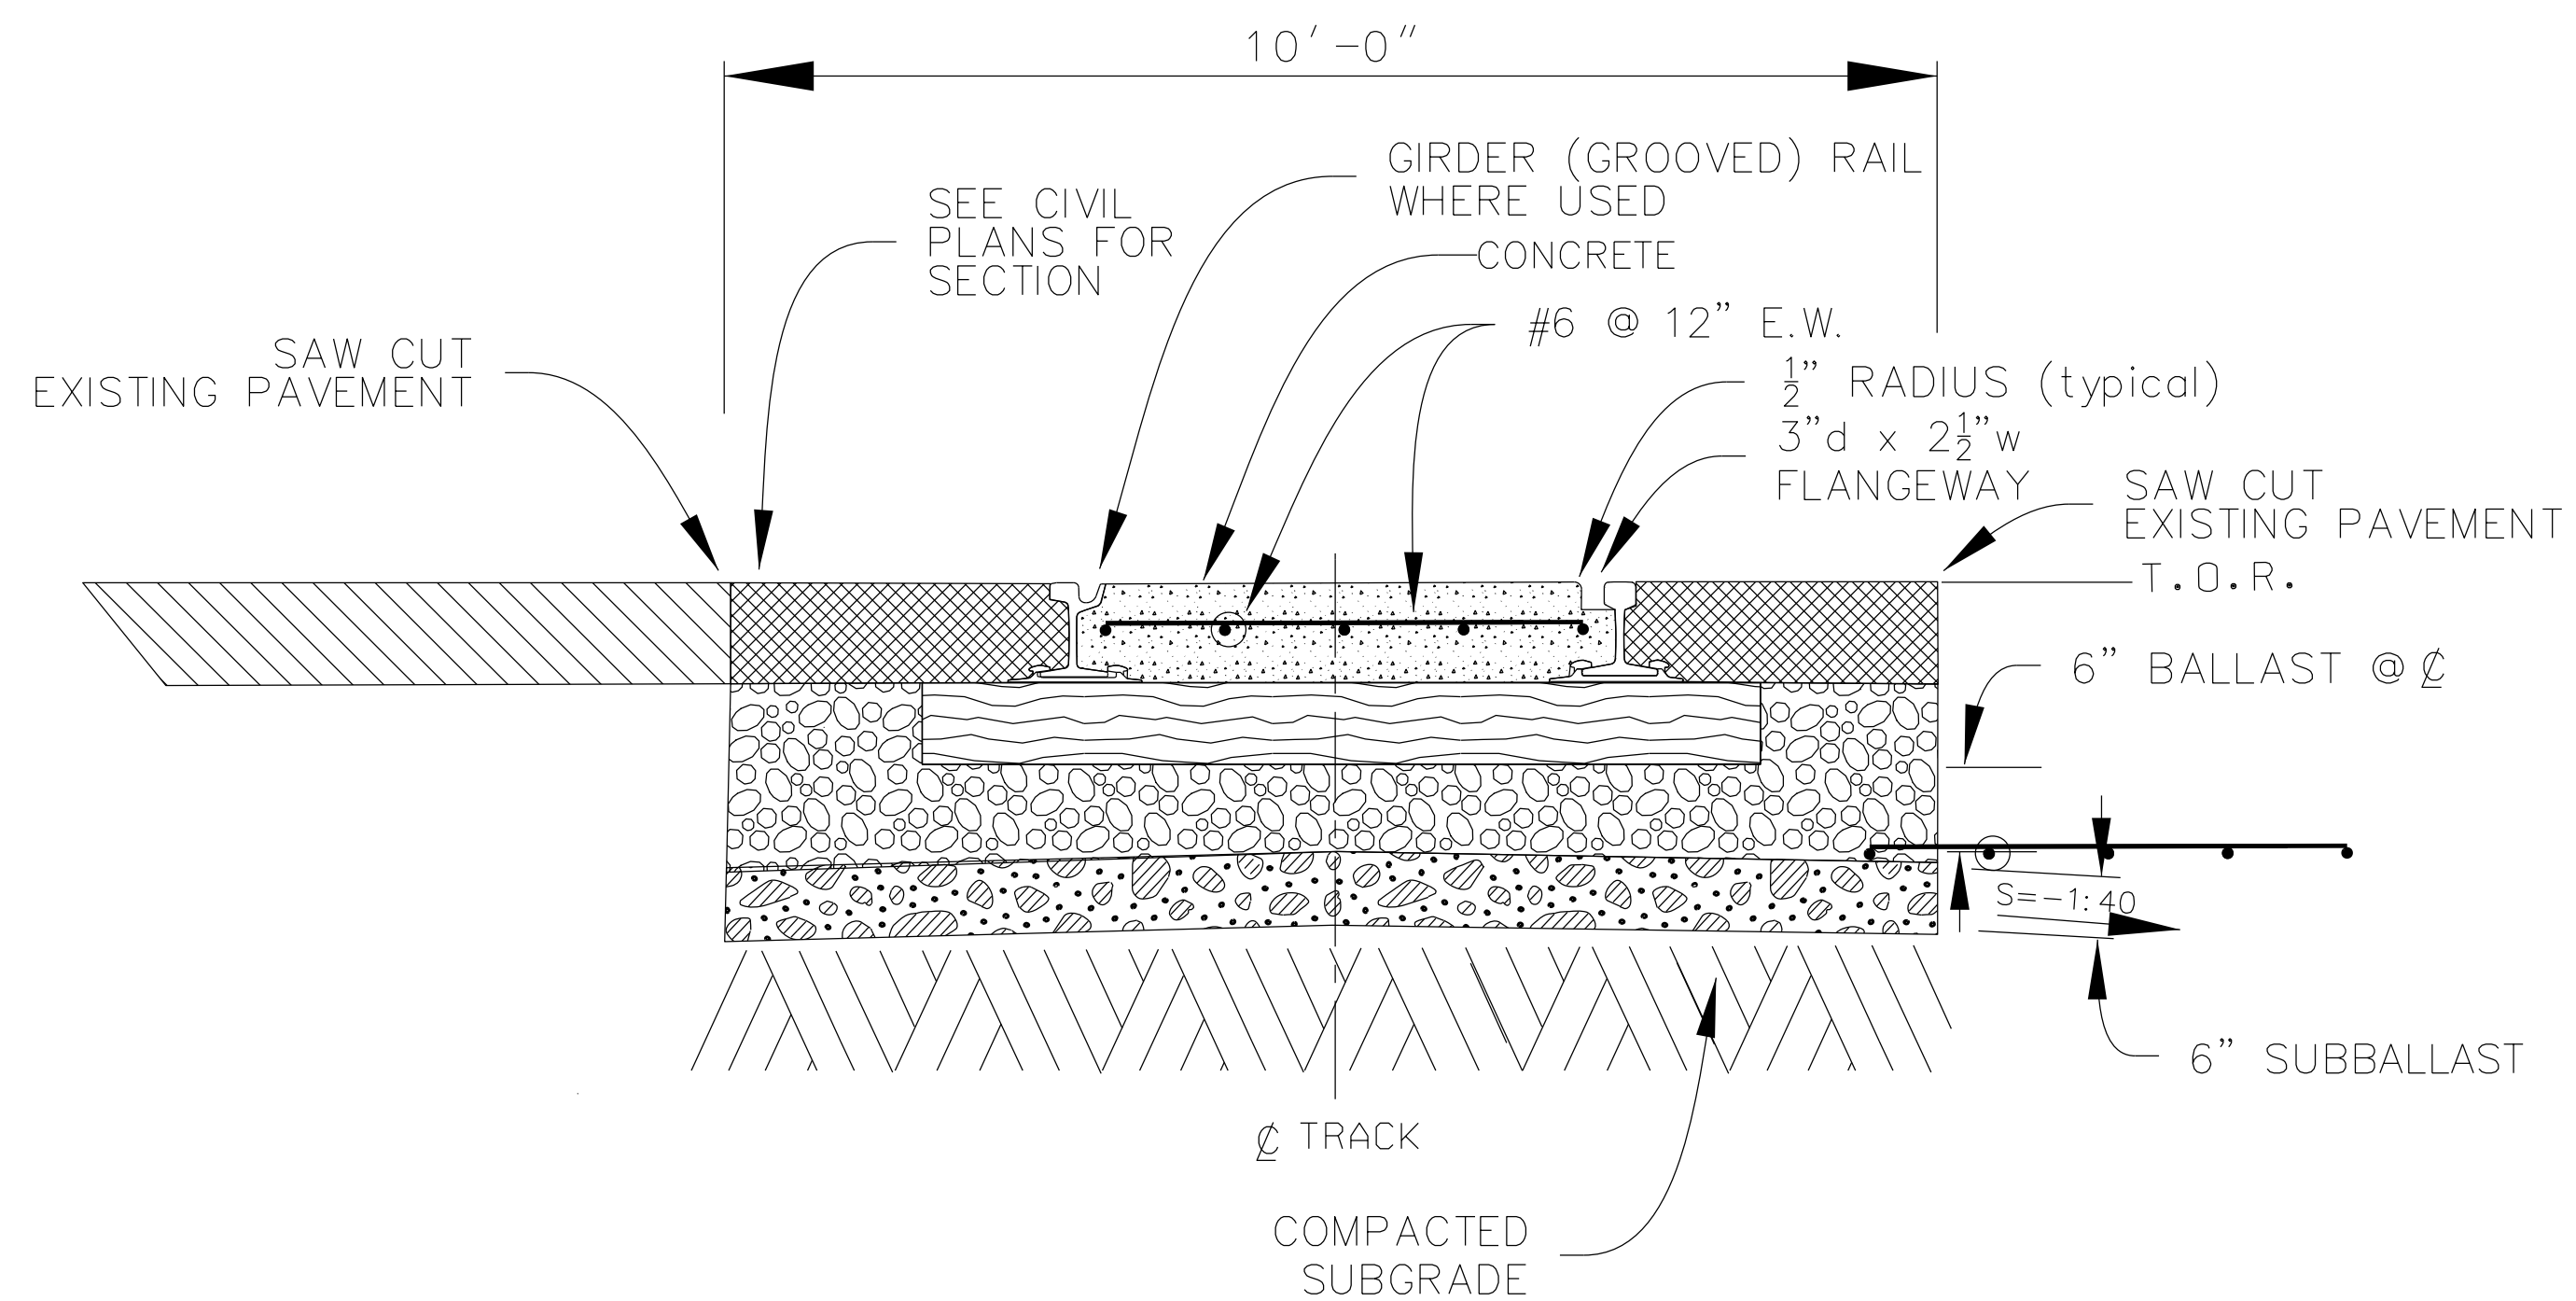


TYPICAL TRACK SECTION WITH TIMBER CROSSIES IN BITUMINOUS PAVEMENT
NO SCALE

1
T-20

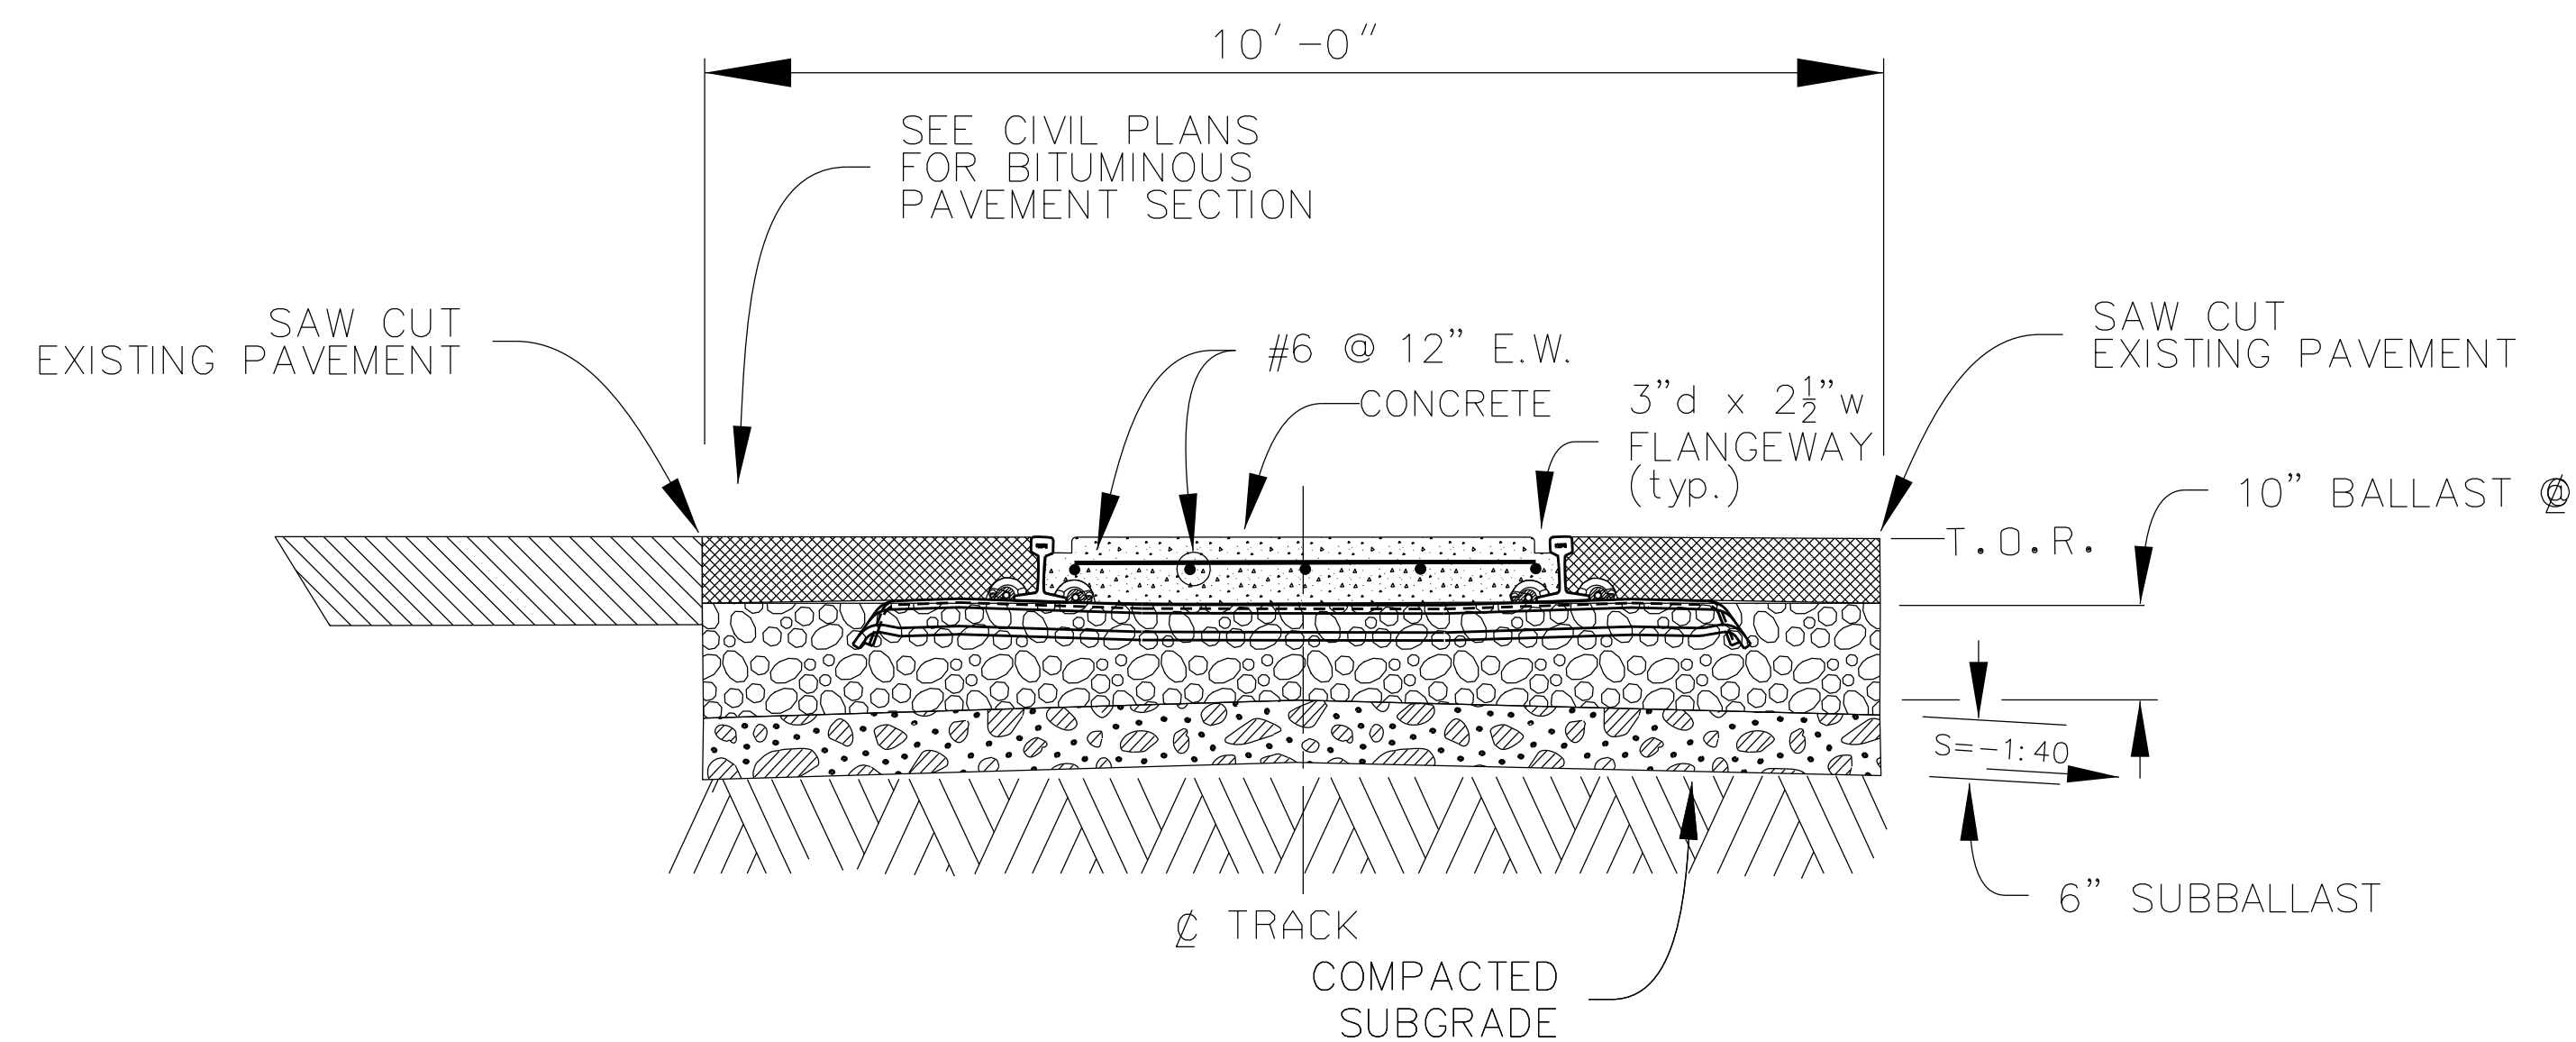


TYPICAL BALLASTED TRACK SECTION WITH STEEL CROSSIES IN BITUMINOUS PAVED AREAS
NO SCALE

2
T-20

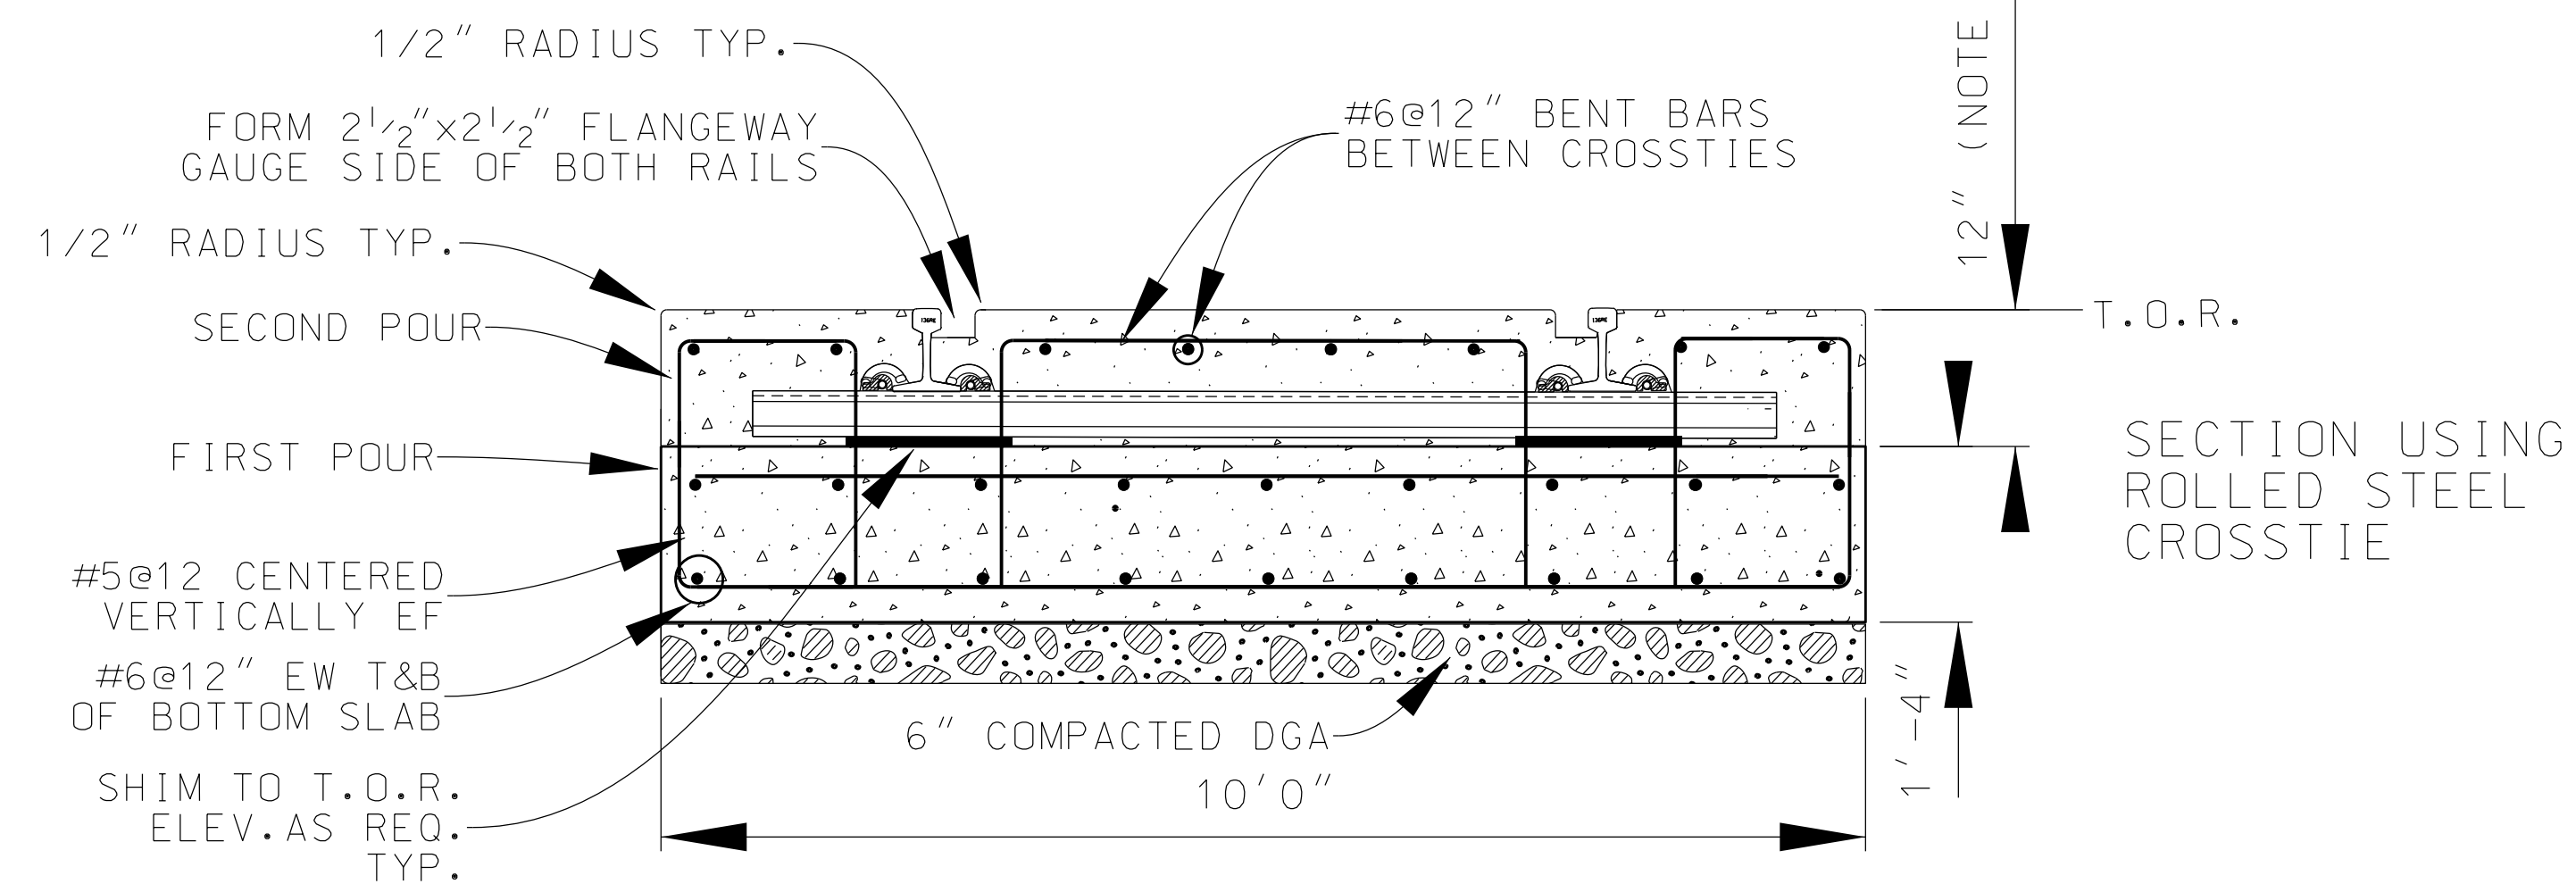

SECTION USING ROLLED STEEL CROSSIE

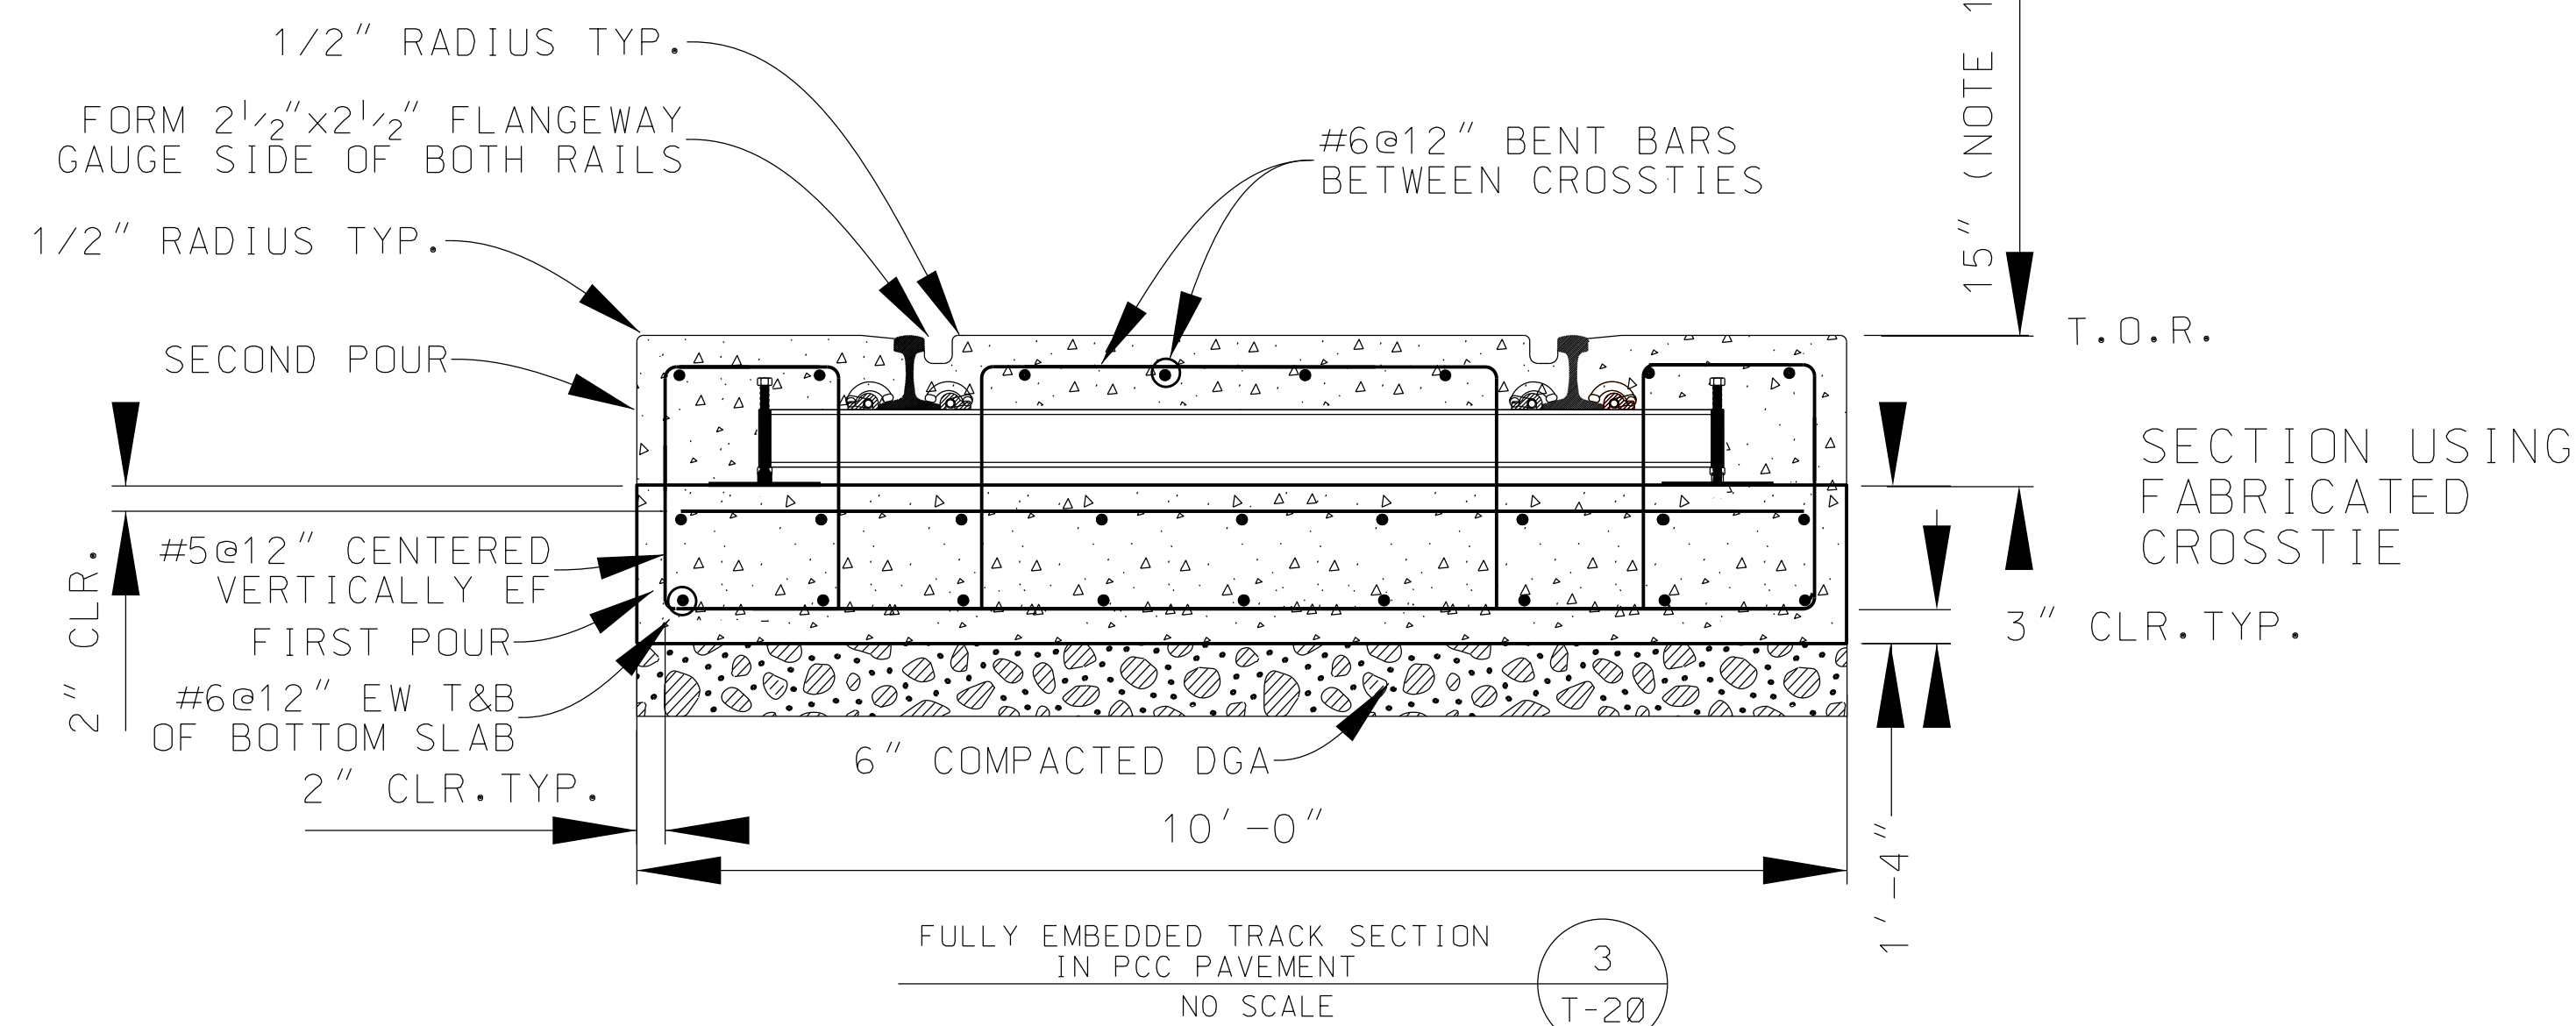

FULLY EMBEDDED TRACK SECTION IN PCC PAVEMENT
NO SCALE

3
T-20

1) DIMENSIONS SHOWN FOR USE WITH 136#RE RAIL.

2) FOR DETAILS OF PANDROL SHOULDER ATTACHMENT WELDS, SEE PANDROL DRAWING #USK-1136, SHEET 1 OF 4.

3) CONTRACTOR MAY PROPOSE "TOP DOWN", "BOTTOM UP" OR "BASE SLAB" METHOD OF CONSTRUCTION SUBJECT TO PRIOR APPROVAL OF ENGINEER.


4) CONTRACTOR MAY USE COMMERCIALY AVAILABLE FIXTURES FOR SETTING RAILS AT PROPER ALIGNMENT, PROFILE AND GAUGE SUBJECT TO PRIOR APPROVAL OF ENGINEER.

5) CONCRETE EMBEDDED TRACK CONSTRUCTION SHOWN IN DETAIL 3 OF THIS SHEET SHALL BE UTILIZED THRUOUT ALL NEW DOUBLE TONGUE TURNOUTS AND PORTIONS OF TRACK AS INDICATED ON PLANS.

6) FOR FABRICATED CROSSIE DIMENSIONS AND ADDITIONAL INFORMATION SEE DETAIL 1/T-25.

7) CONCRETE MIX FOR ALL EMBEDDED TRACKWORK SHALL HAVE MINIMUM COMPRESSIVE STRENGTH 5000 PSI @ 28 DAYS.

REV	BY	DATE	DESCRIPTION

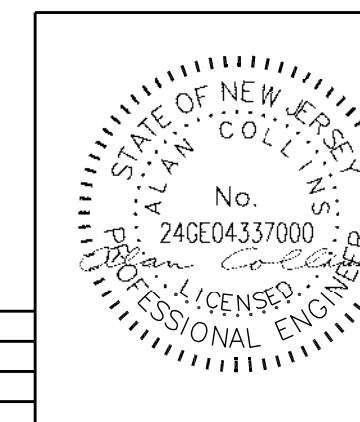

ISSUED FOR BID


URBAN ENGINEERS URBAN ENGINEERS, INC.
530 Walnut Street
Philadelphia, PA 19106
(215) 922-8080 Fax (215) 922-8082

LOCATION: CAMDEN, N.J.

TITLE: S.J.P.C. BALZANO MARINE TERMINAL RAIL INFRASTRUCTURE REHABILITATION TYPICAL TRACK CONSTRUCTION DETAILS


OWN: FST PROJ #
CRK: DATE

DRAWING NUMBER: T-20

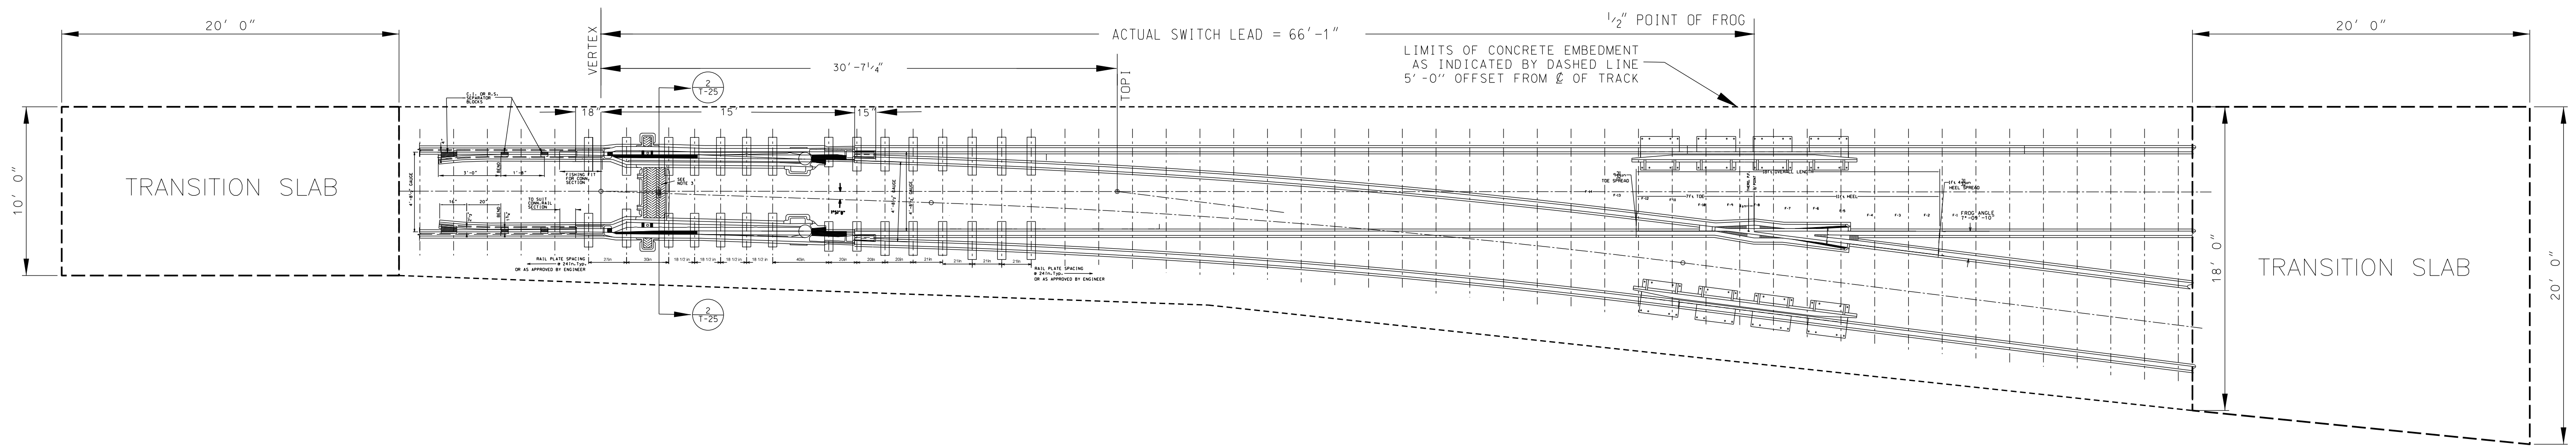

GENERAL ARRANGEMENT #8
DOUBLE TONGUE TURNOUT
NO SCALE

1
T-21

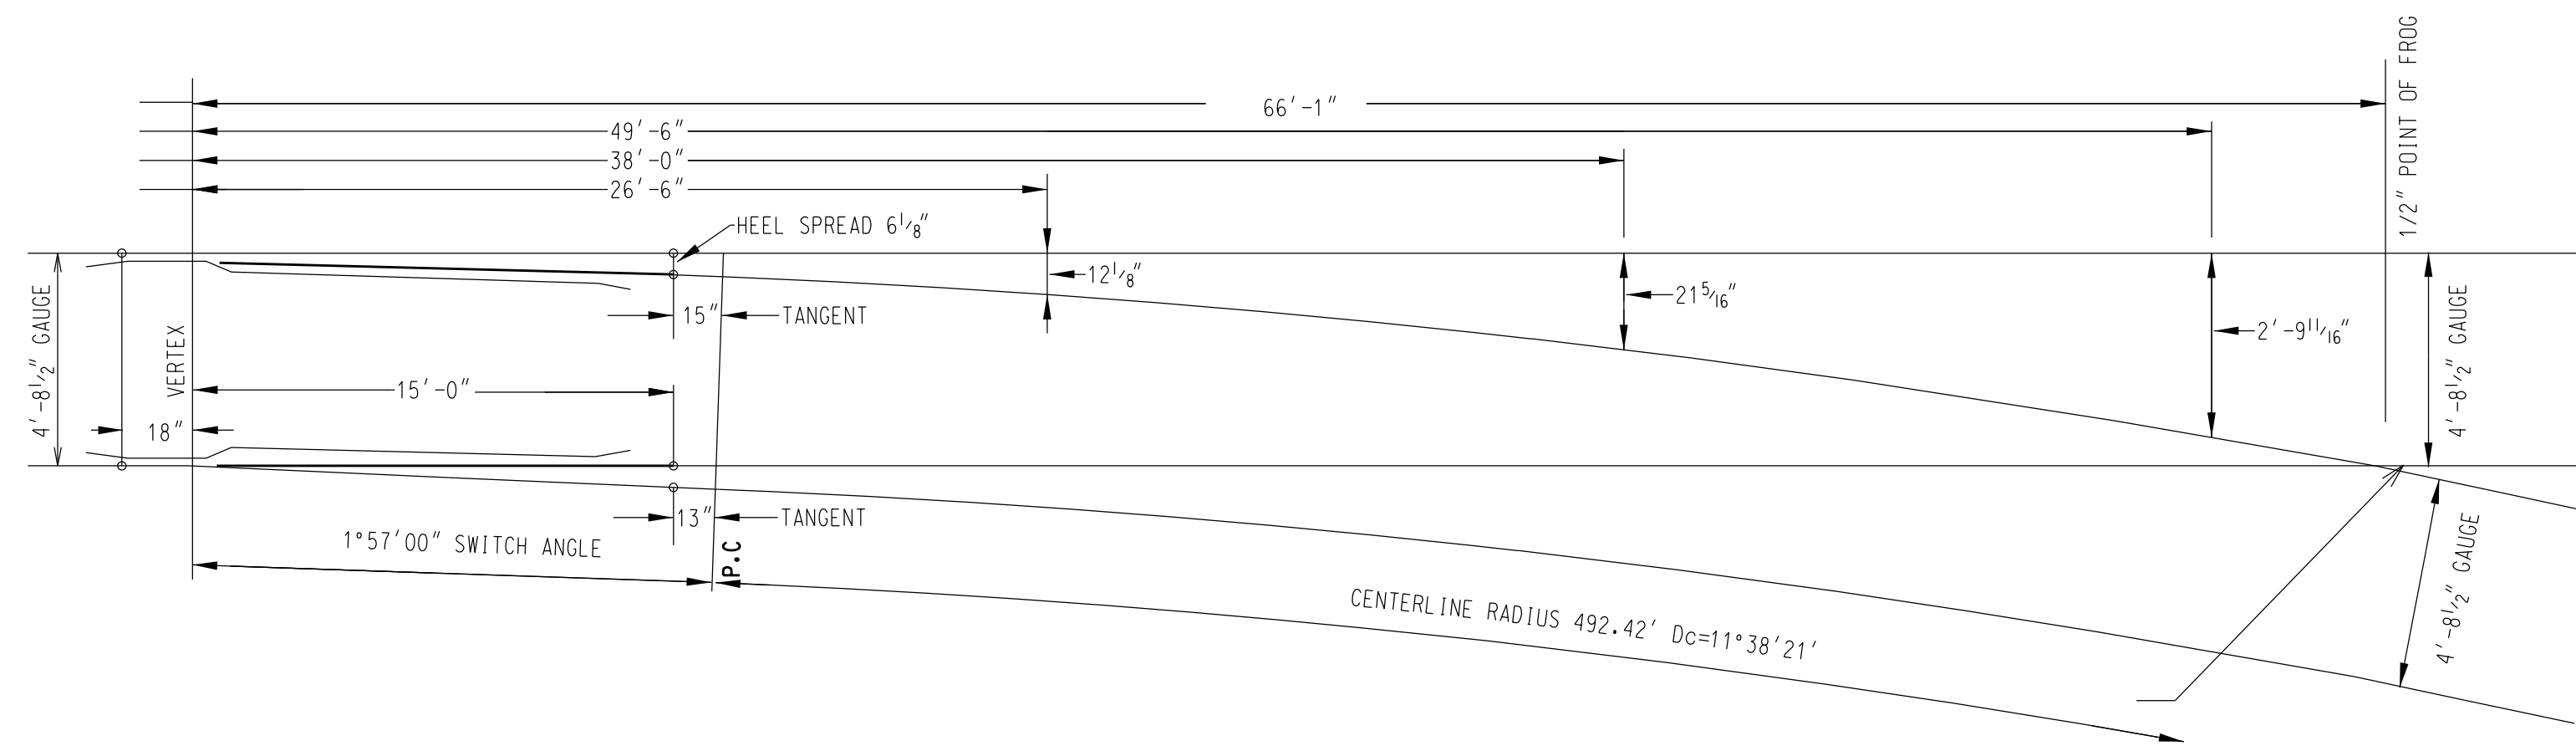

OFFSETS FOR #8 DOUBLE
TONGUE TURNOUT
NO SCALE

2
T-21

1) ARRANGEMENT IS SHOWN FOR RECOMMENDED LOCATION AND SPACING OF DOUBLE TONGUE SWITCH FASTENING PLATES THRU TURNOUT. THE CONTRACTOR MAY PROPOSE ALTERNATE MEANS FOR SETTING THE ALIGNMENT AND PROFILE OF THE TURNOUT COMPONENTS. CONTRACTOR SHALL SUBMIT COMPLETE DRAWINGS AND PRODUCT SPECIFICATIONS, INCLUDING PROPOSED LOCATIONS OF REINFORCING STEEL FOR ANY SUCH PROPOSED ALTERNATE METHODS PRIOR TO PROCUREMENT. THE ENGINEER IS UNDER NO OBLIGATION TO APPROVE ALTERNATE MEANS OF SUCH INSTALLATION.

2) RAIL BOUND MANGANESE FROG SHOWN. SOLID MANGANESE FROG CONFORMING TO AREMA STANDARD PLAN 671 MAY BE SUBSTITUTED. SOLID MANGANESE SELF GUARDED FROGS ARE NOT PERMITTED.

3) REFER TO AREMA BASIC PLAN 989 FOR ALTERNATE ARRANGEMENT OF OPERATING MECHANISM LOCATED OUTSIDE OF GAUGE.


4) FOR ADDITIONAL DETAILS OF DOUBLE TONGUE SWITCH NOT SHOWN, REFER TO AREMA PLAN 987.

5) SUPPLIER TO SUBMIT COMPLETE SHOP DRAWINGS AND LAYOUT PLANS FOR TURNOUT AND ALL TURNOUT COMPONENTS INCLUDING TYPE OF POSITIVE RESTRAINT RAIL FASTENING SYSTEM TO BE EMPLOYED. TO THE ENGINEER FOR REVIEW PRIOR TO COMMENCING FABRICATION.

6) REFER TO SHEET T-23 FOR DETAILS OF TRANSITION SLABS.


7) REFER TO DETAIL 2/T-25 FOR SWITCH POINT MECHANISM DRAIN.

REV	BY	DATE	DESCRIPTION

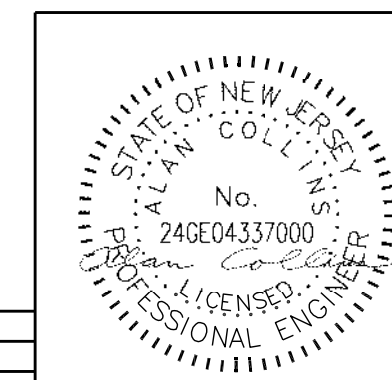


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		LOCATION: CAMDEN, N.J.	
TITLE: S.J.P.C. BALZANO MARINE TERMINAL RAIL INFRASTRUCTURE REHABILITATION		DRAWING NUMBER: T-21	
EWN: FST CRK: DATE	PROJ # DATE		

ISSUED FOR BID

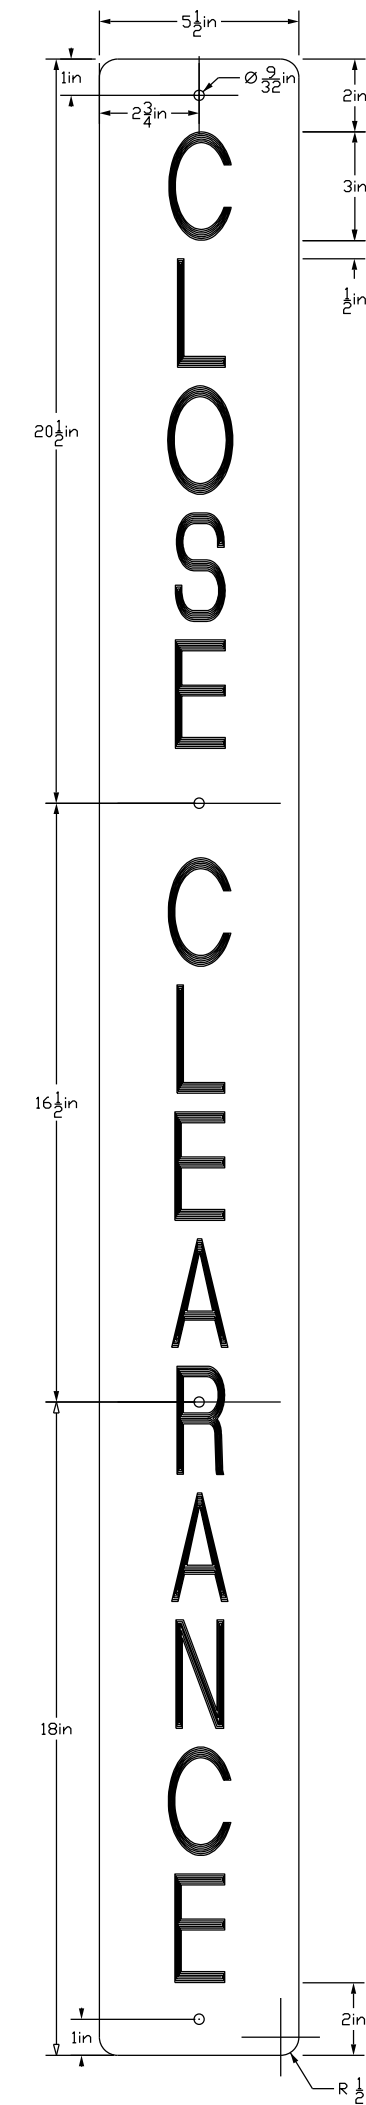

VERTICAL SIGN

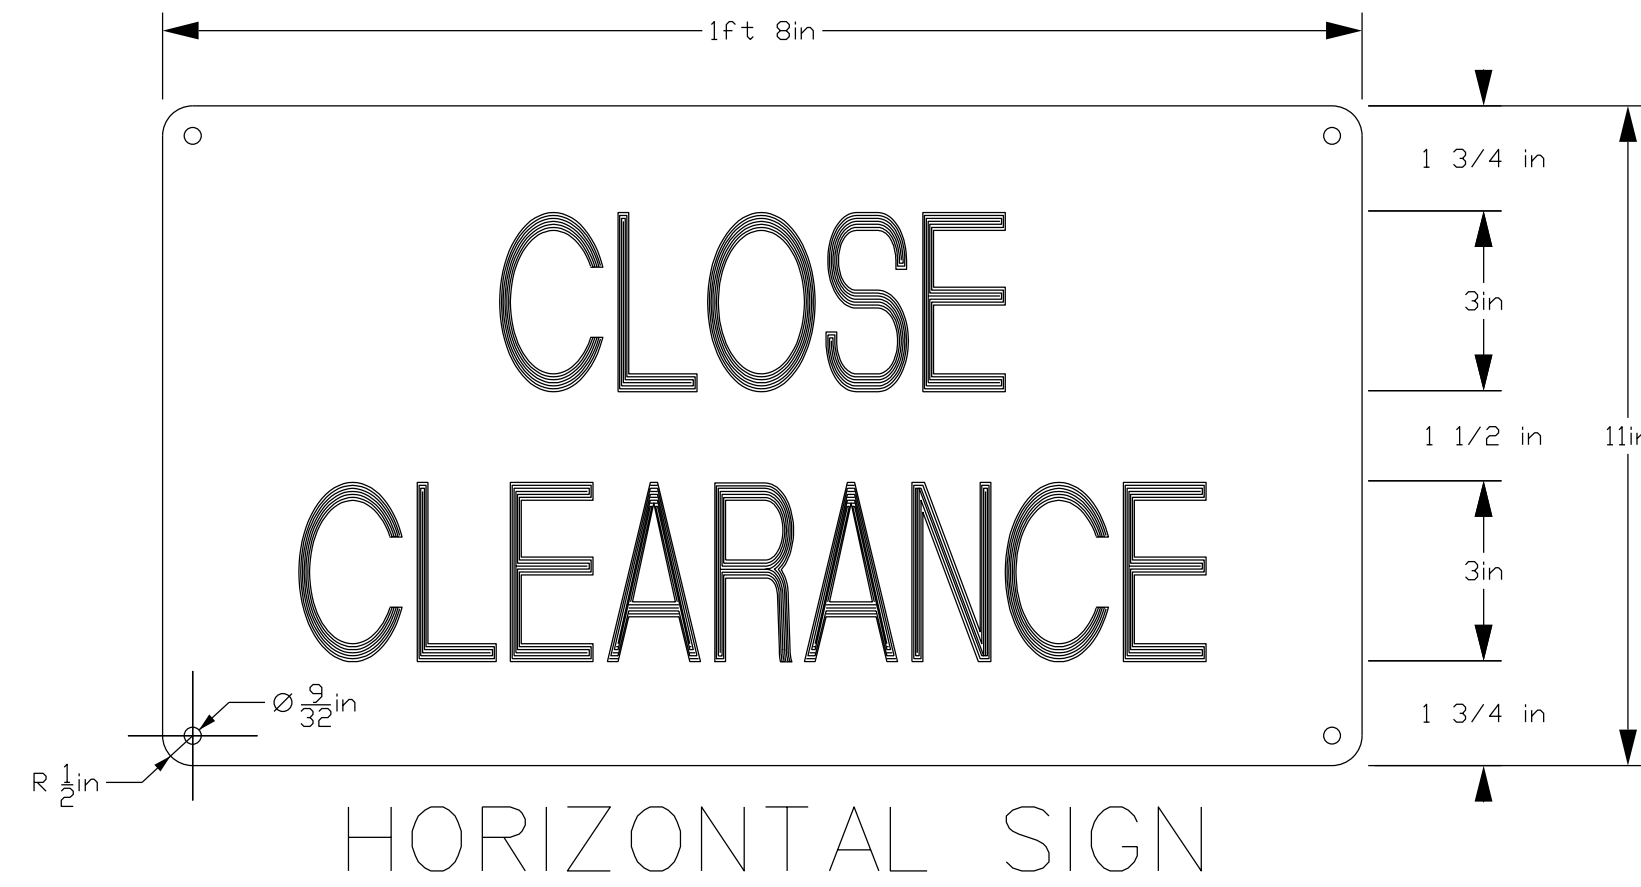

HORIZONTAL SIGN

1- THE SIGN SHALL BE 6061-T6 ALUMINUM SHEETING .081" THICK, WITH ONE SIDE COVERED WITH NO.2870 SILVER SCOTCHLITE AND NO. 605 BLACK SCOTCHCAL LETTERS.



2- "CLOSE CLEARANCE" SIGNS SHALL BE DISPLAYED WHERE OBJECTS DO NOT PROVIDE FOR FULL CLEARANCE PER RAILROAD'S CLEARANCE DIAGRAM. THE SIGNS SHALL BE ATTACHED TO THE SIDE OF A BUILDING OR OTHER FLAT SURFACE AND SHALL BE HELD AWAY FROM THE SURFACE ABOUT 1" WITH FURRING STRIPS OR SPOOLS TO ALLOW FOR VENTILATION. NO.14 STAINLESS STEEL ROUND HEAD WOOD SCREWS OR 1/2" DIAMETER STAINLESS STEEL BOLTS SHALL BE USED TO ATTACH THE SIGNS. STAINLESS STEEL WASHERS SHALL BE USED UNDER THE HEADS OF BOLTS OR SCREWS.

3- "CLOSE CLEARANCE" SIGNS SHALL BE ILLUMINATED DURING THE HOURS OF DARKNESS.

CLOSE CLEARANCE SIGNS

NO SCALE

1
T-22

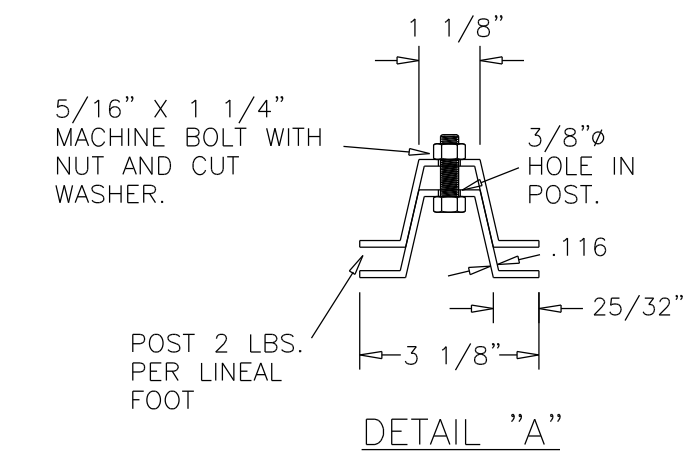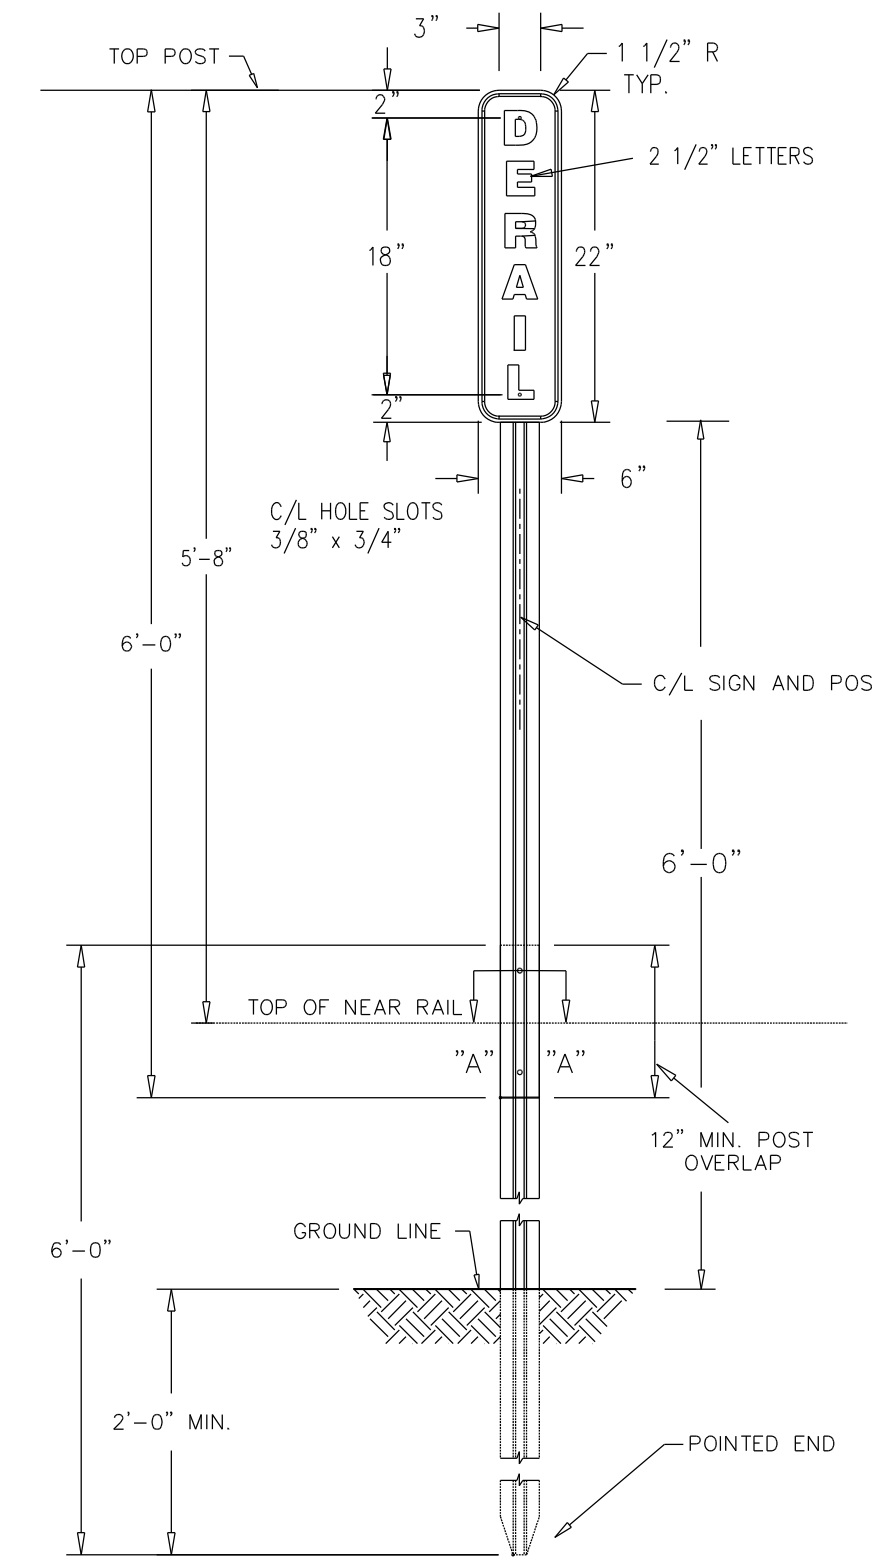

1) THE SIGN SHALL BE 6061-T6 ALUMINUM SHEETING .081" THICK, WITH ONE SIDE COVERED WITH NO.2870 SILVER SCOTCHLITE AND NO. 605 BLACK SCOTCHCAL LETTERS.

2) SIGN AS SHOWN IS ONE SIDE ONLY. FOR BI-DIRECTIONAL VISIBILITY, MOUNT TWO SIGNS BACK TO BACK.

MATERIAL REQUIRED
2 EA. 2 LB./L.F. GALVANIZED FLANGED CHANNEL STEEL POST
6'-0" LONG W/3/8" MOUNTING HOLES AT 1" CENTERS AND POINTED END.

2 EA. 5/16"x2" GALVANIZED CARRIAGE BOLT WITH LOCK NUT AND NYLON WASHER.
2 EA. MOUNTING BOLTS 5/16"x1 1/4" FOR SECURING THE 2 EA. SIGN POSTS.

ALTERNATE MATERIAL
1 EA. 2 LB./L.F. GALVANIZED FLANGED CHANNEL STEEL POST
8'-0" LONG W/3/8" MOUNTING HOLES AT 1" CENTERS AND POINTED END.

2 EA. 5"16"x2" GALVANIZED CARRIAGE BOLT WITH LOCK NUT AND NYLON WASHER.

DERAIL MARKER POST


NO SCALE

1
T-22


ISSUED FOR BID

		URBAN ENGINEERS, INC. 530 Walnut Street Philadelphia, PA 19106 (215) 922-8080 Fax (215) 922-8082
		LOCATION: CAMDEN, N.J. TITLE: S.J.P.C. BALZANO MARINE TERMINAL RAIL INFRASTRUCTURE REHABILITATION TRACK CONSTRUCTION DETAILS
EWN FST CRK	PROJ # DATE	DRAWING NUMBER T-22

REV	BY	DATE	DESCRIPTION

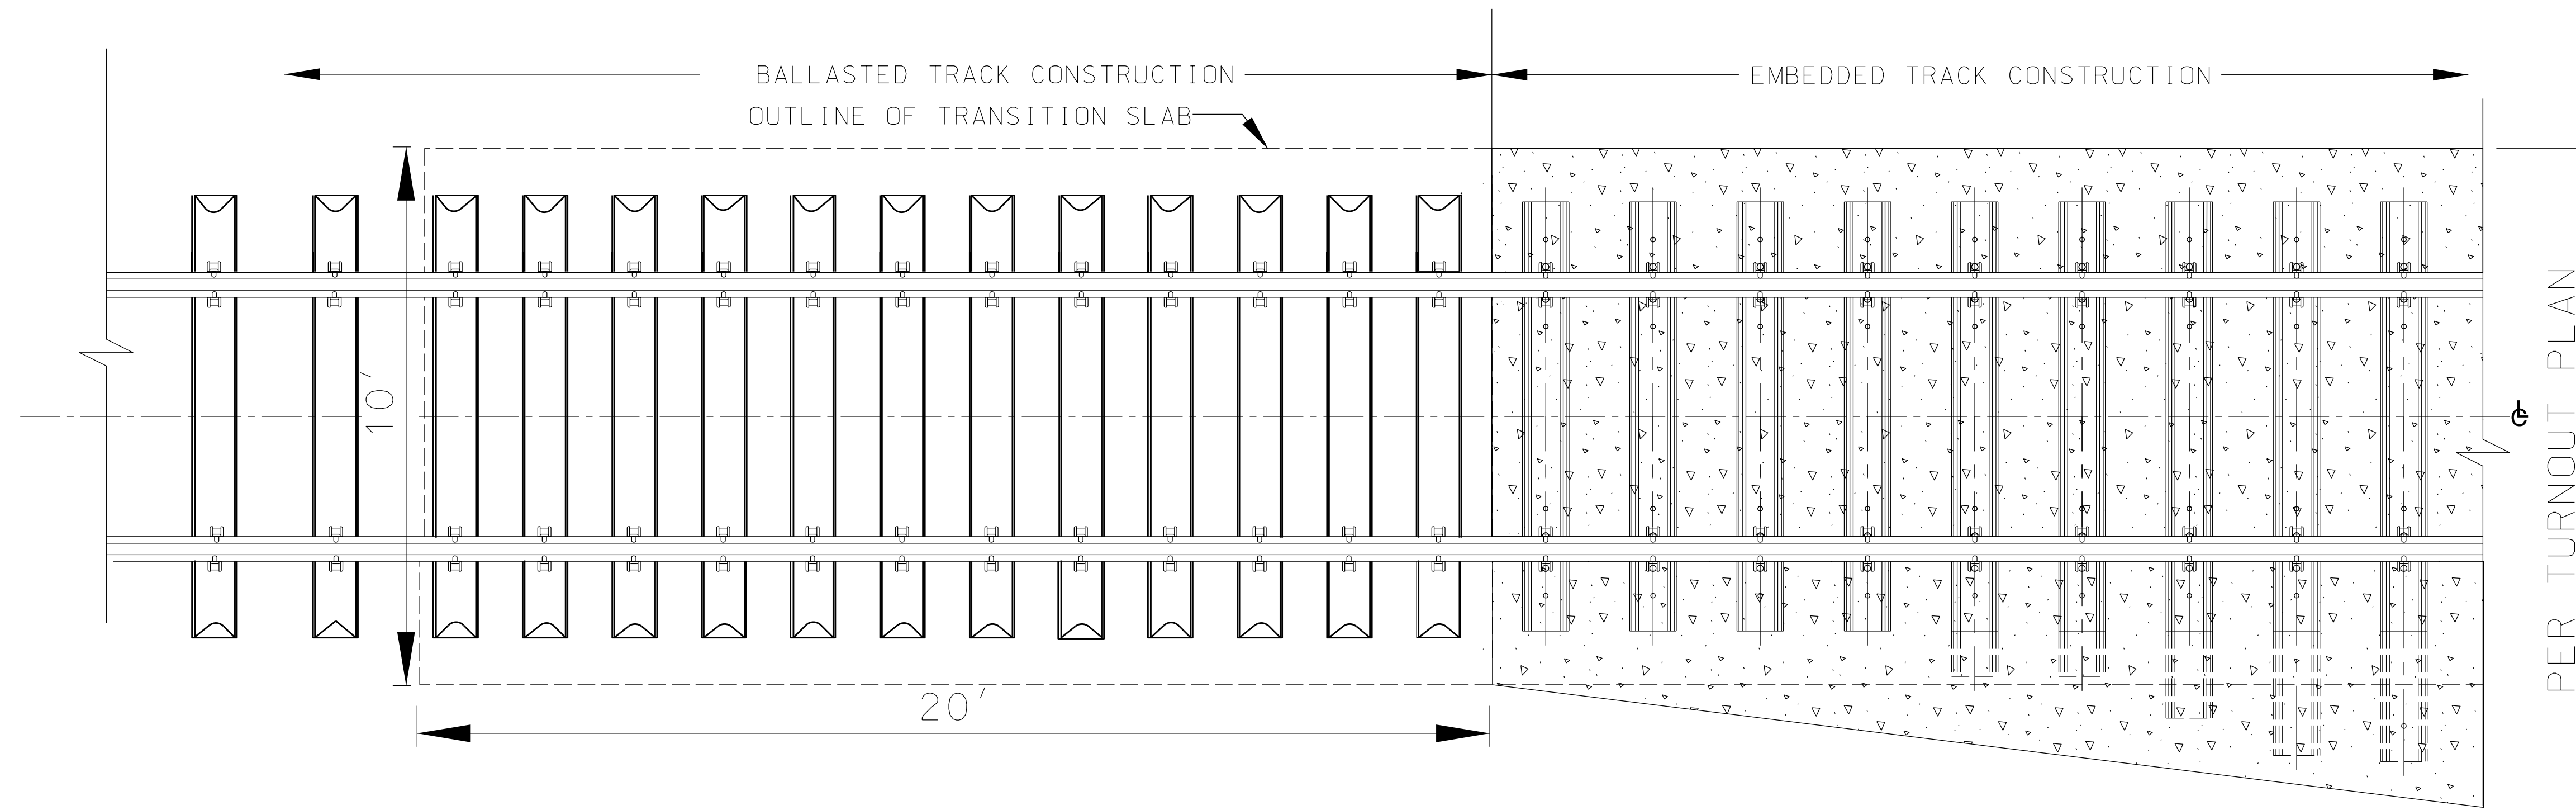


PLAN VIEW 1
NO SCALE T-23

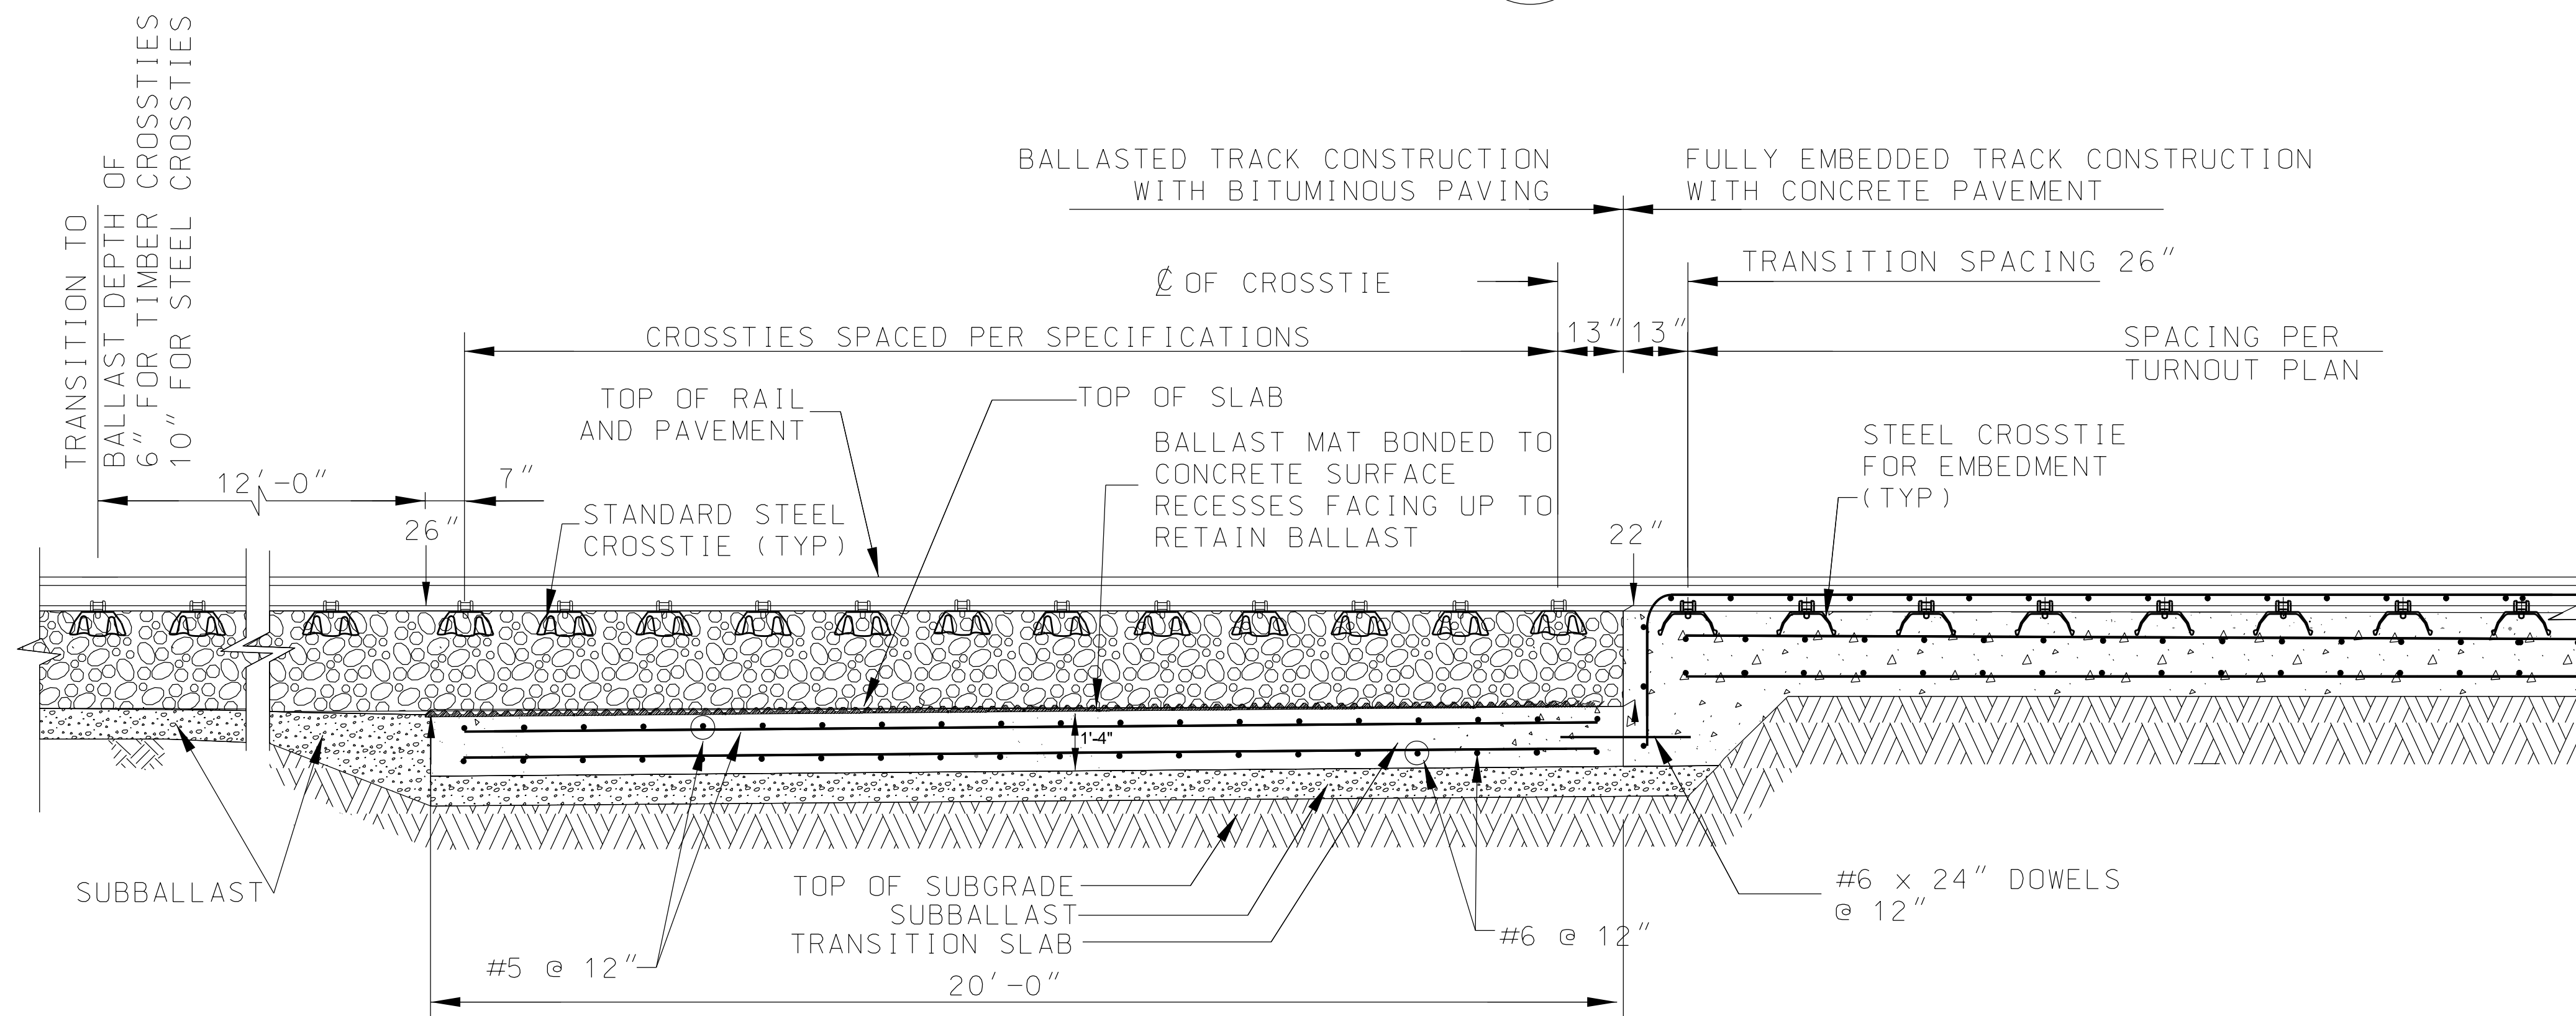

SECTION VIEW 2
NO SCALE T-23

- ARRANGEMENT IS SHOWN FOR INSTALLATION USING STEEL CROSSIES WITH POSITIVE RESTRAINT RAIL FASTENING SYSTEM FOR APPLICATION IN BALLASTED TRACK AND FOR FULL EMBEDMENT IN REINFORCED CONCRETE PAVEMENT SLAB.
- ALTERNATE METHODS OR MATERIALS FOR CONSTRUCTING BALLASTED TRACK OR FOR SETTING ALIGNMENT AND GAUGE OF RAILS FOR INSTALLATION OF FULLY EMBEDDED TRACK MAY BE ACCEPTABLE SUBJECT TO PRIOR SUBMISSION TO, AND RECEIPT OF APPROVAL OF ENGINEER.
- CONTRACTOR TO SUBMIT SHOP DRAWINGS FOR ARRANGEMENT OF CONCRETE REINFORCING THRU ENTIRE TURNOUT TO ENGINEER FOR APPROVAL PRIOR TO INSTALLATION.
- CONCRETE FOR ALL TRACK CONSTRUCTION SHALL HAVE MINIMUM COMPRESSIVE STRENGTH OF 5000 psi @ 28 DAYS.

REV	BY	DATE	DESCRIPTION

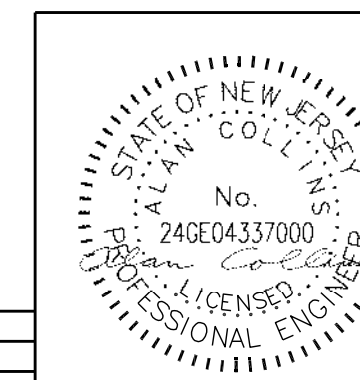


URBAN ENGINEERS, INC.
530 Walnut Street
Philadelphia, PA 19106
(215) 922-8080 Fax (215) 922-8082

LOCATION: CAMDEN, N.J.


TITLE: S.J.P.C. BALZANO MARINE TERMINAL RAIL INFRASTRUCTURE REHABILITATION TRACK CONSTRUCTION DETAIL TRANSITION SLAB

PROJ # :
DATE :
DRAWING NUMBER: T-23



ISSUED FOR BID

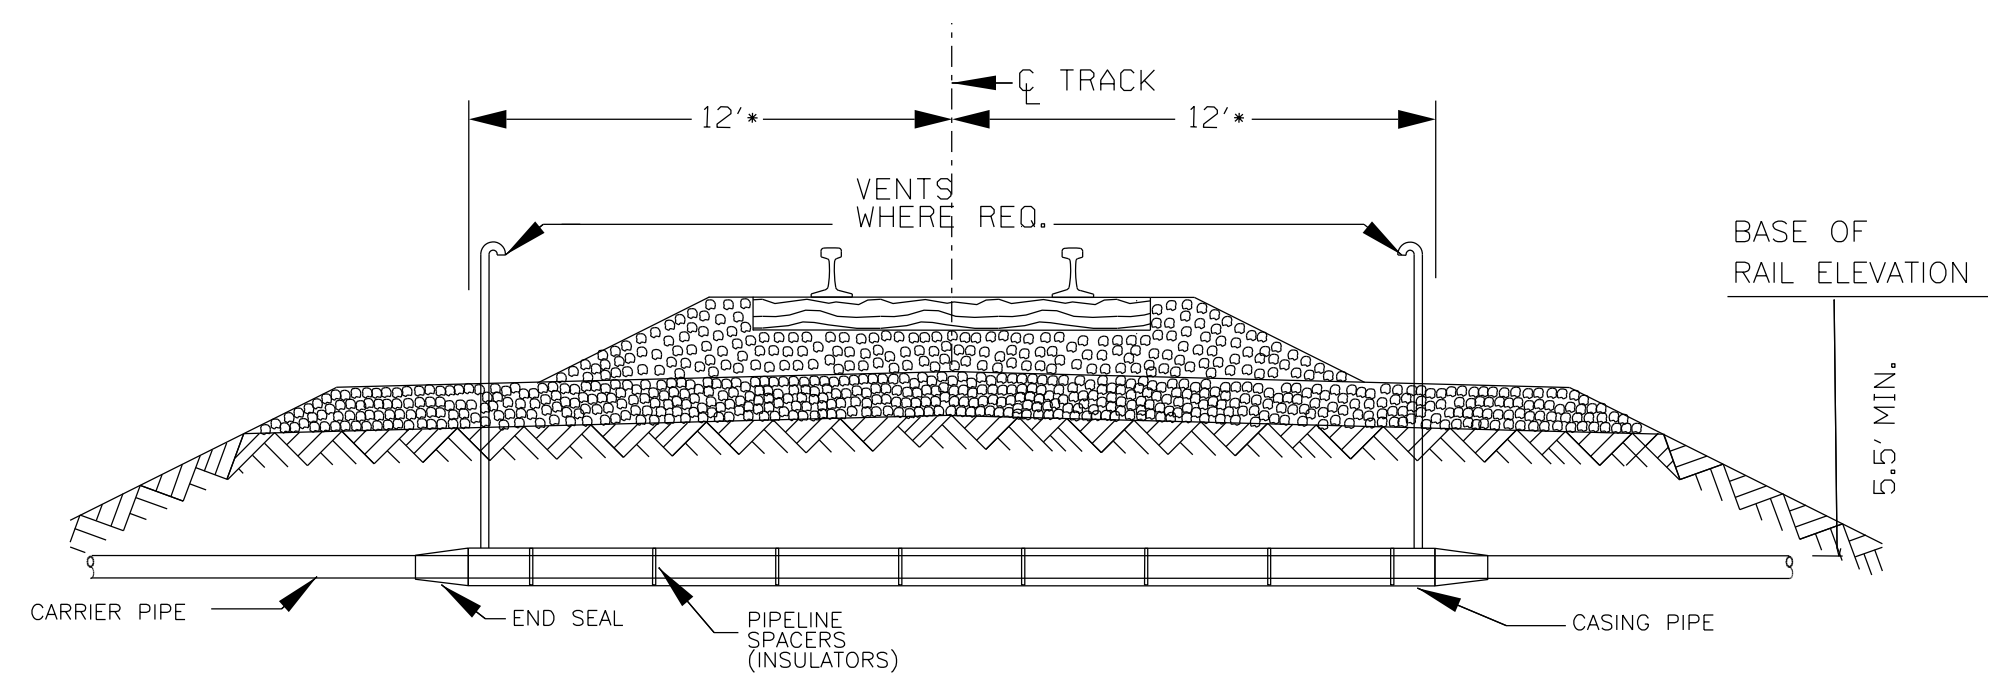




TYPICAL PRESSURIZED PIPELINE TRACK CROSSING
NO SCALE
* MEASURED PERPENDICULAR TO TRACK CENTERLINE OR AS OTHERWISE NOTED ON PLANS

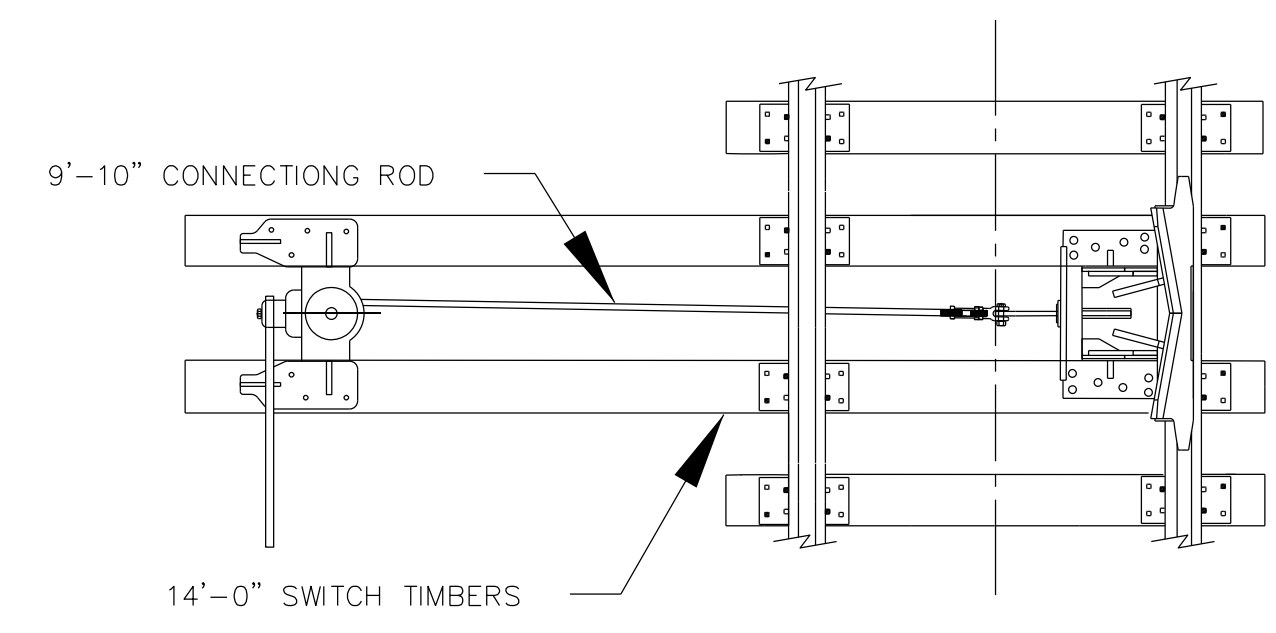

"HAYES" SLIDING DERAIL
NO SCALE

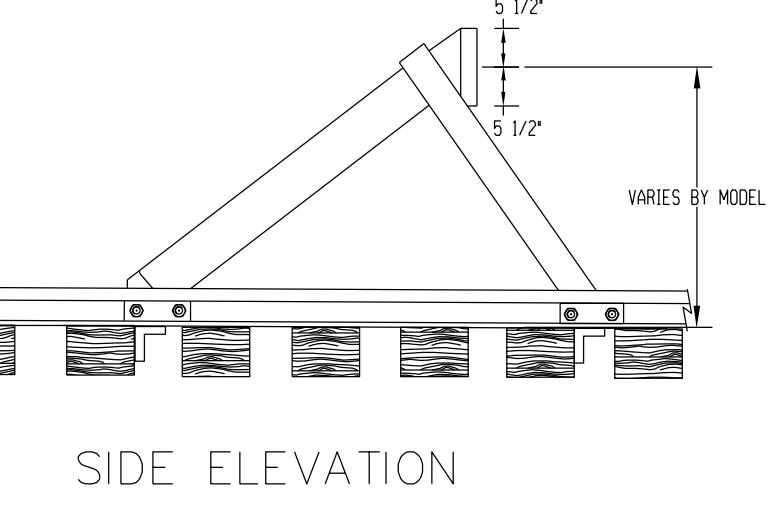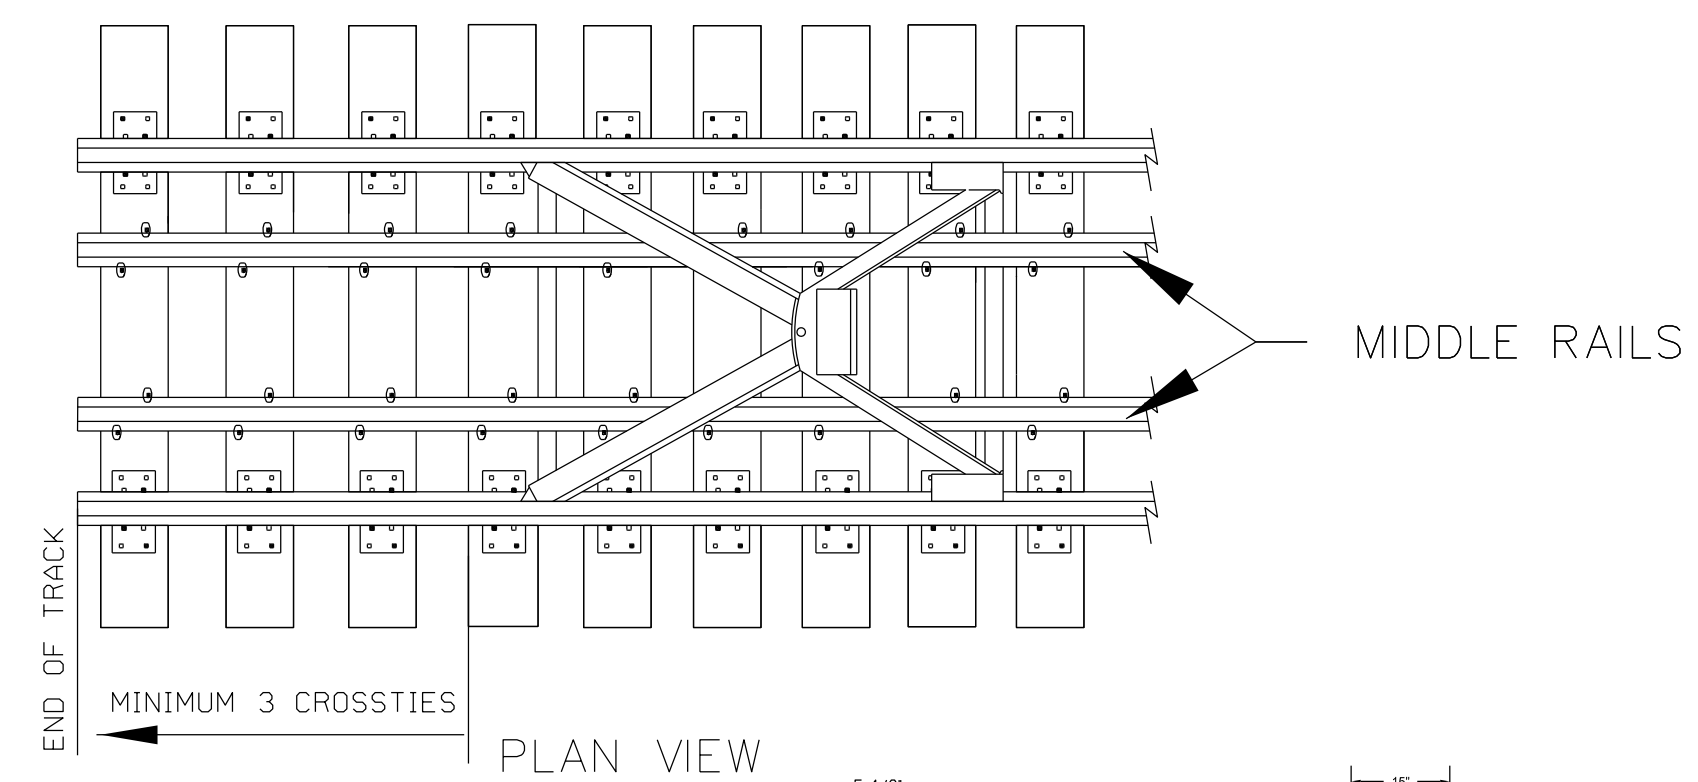


"HAYES" TYPE "WD" BUMPER
NO SCALE

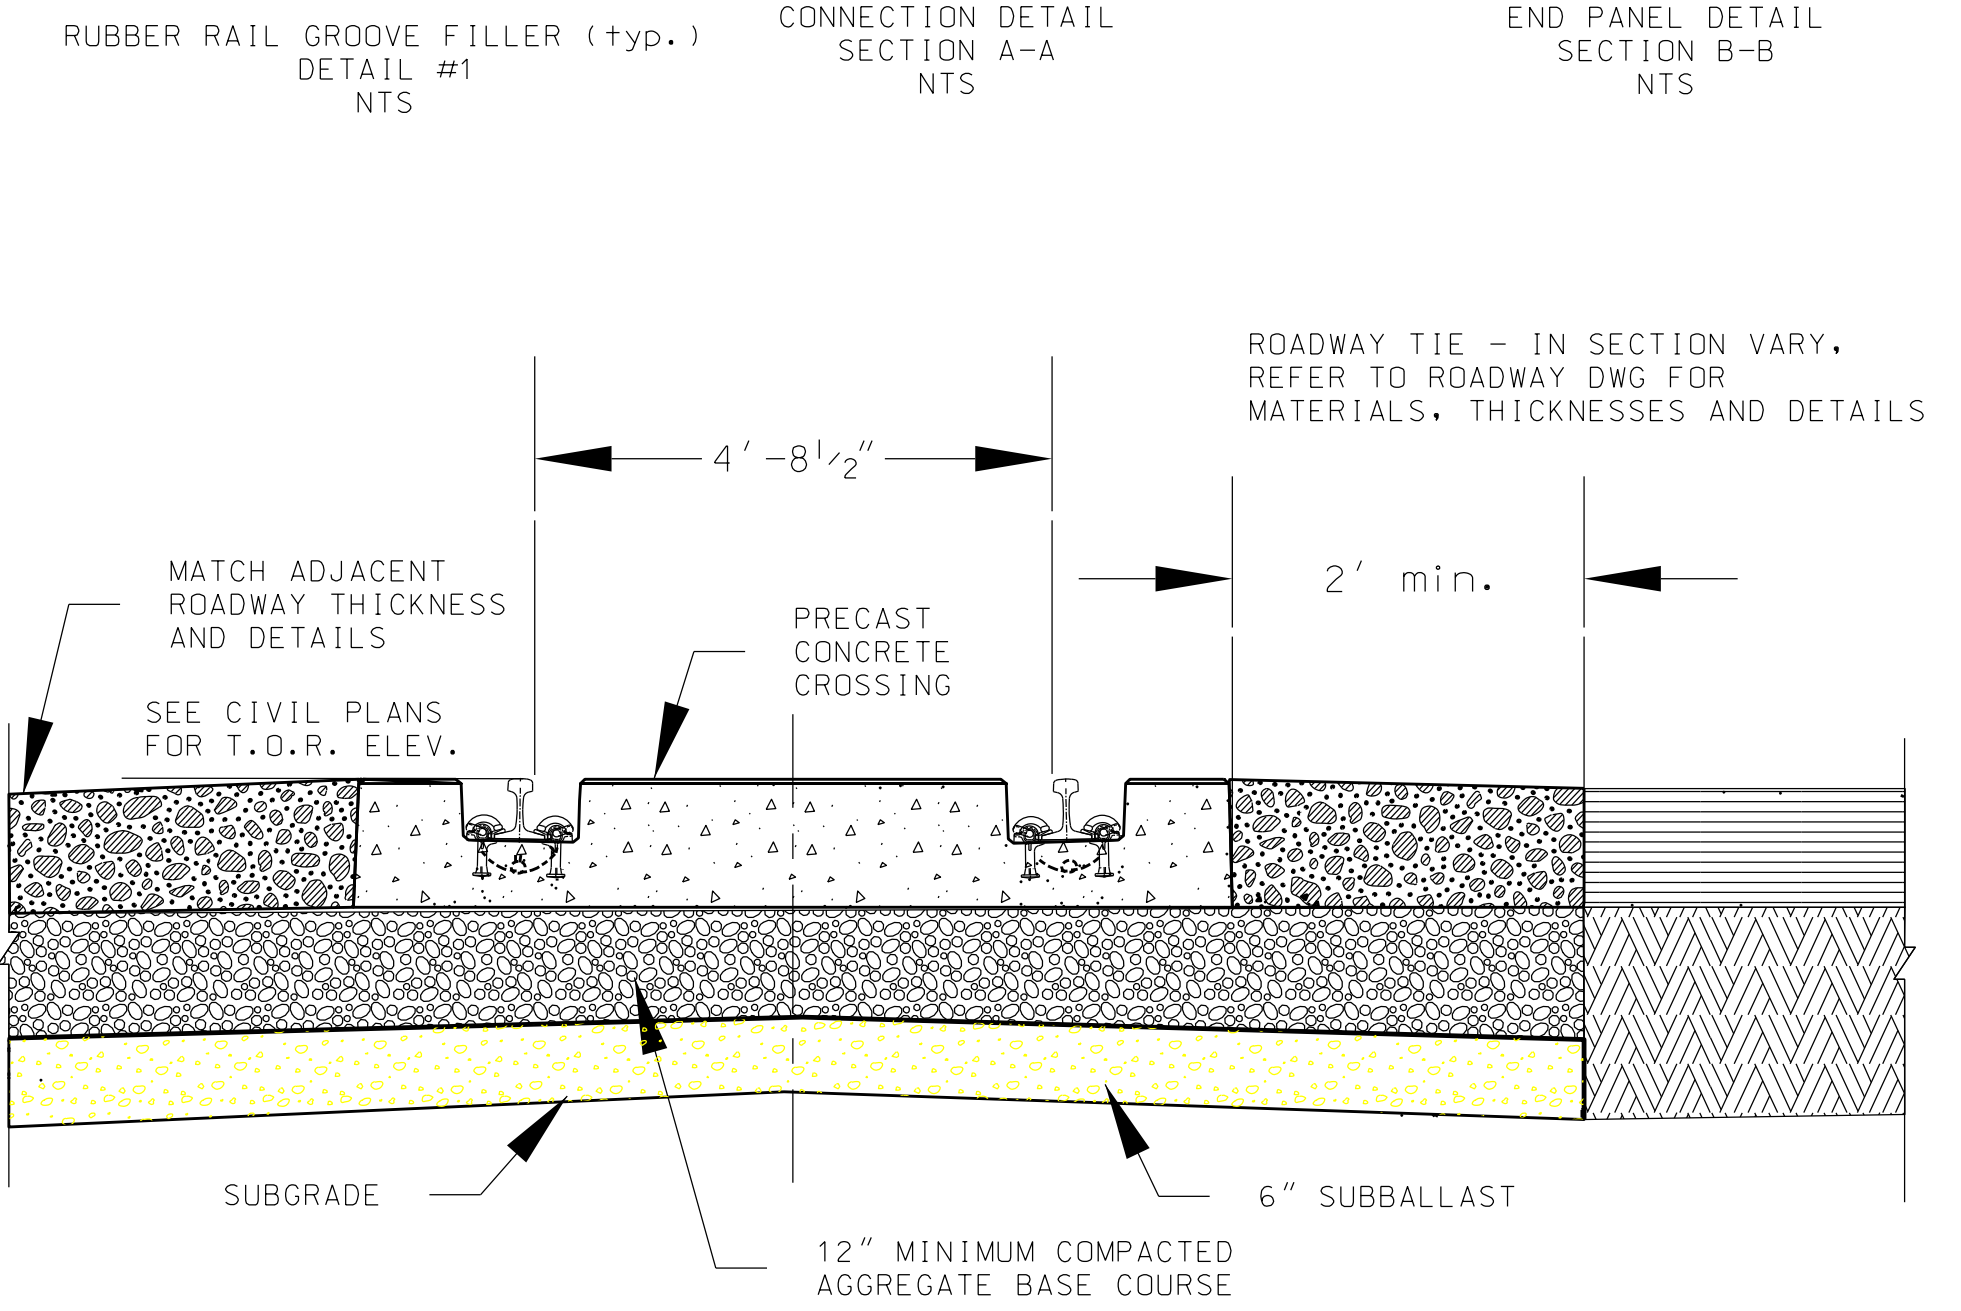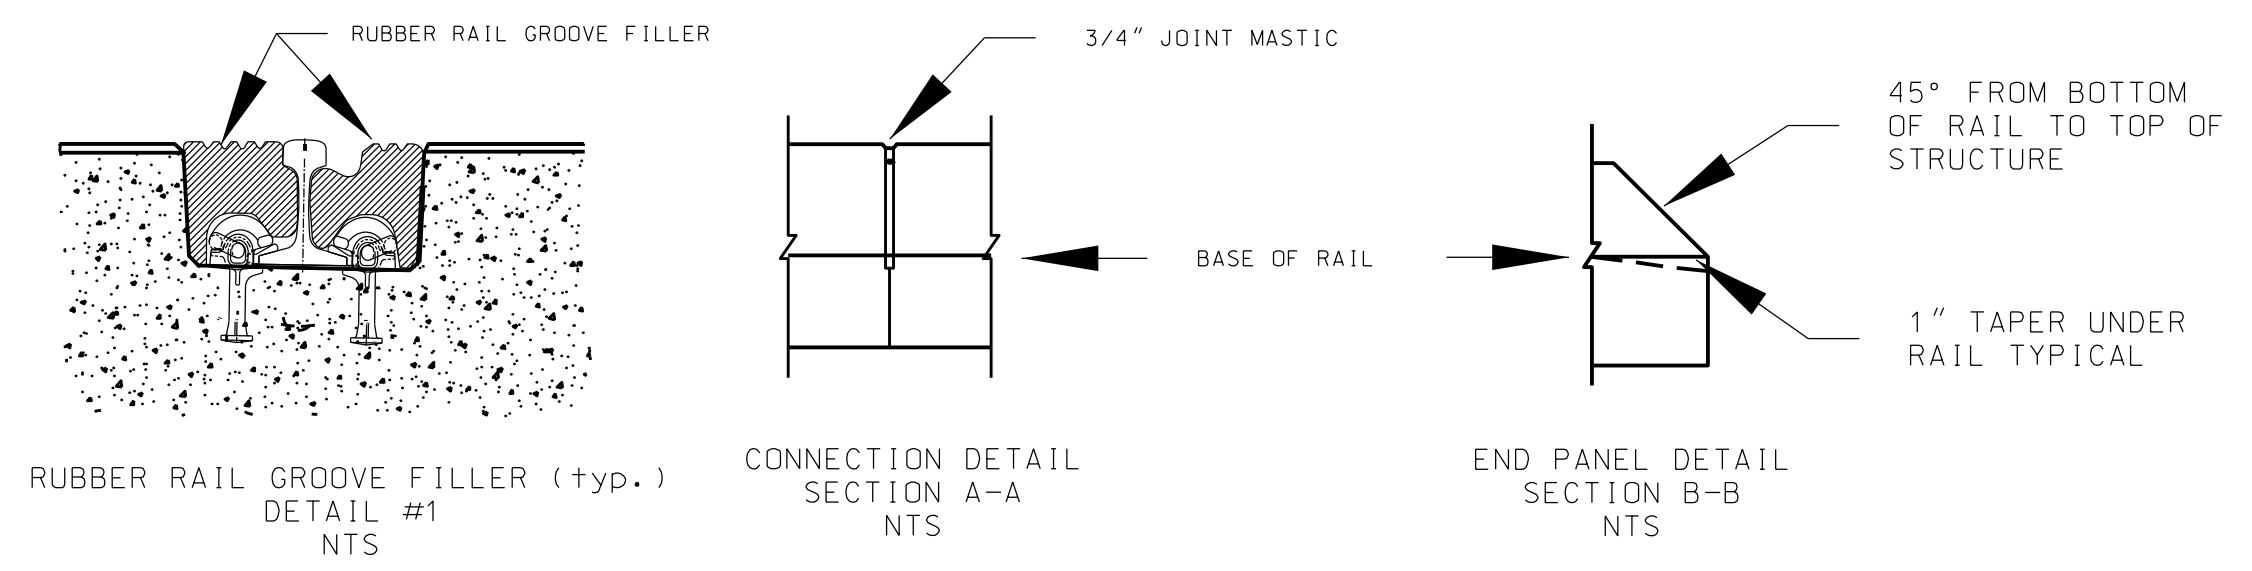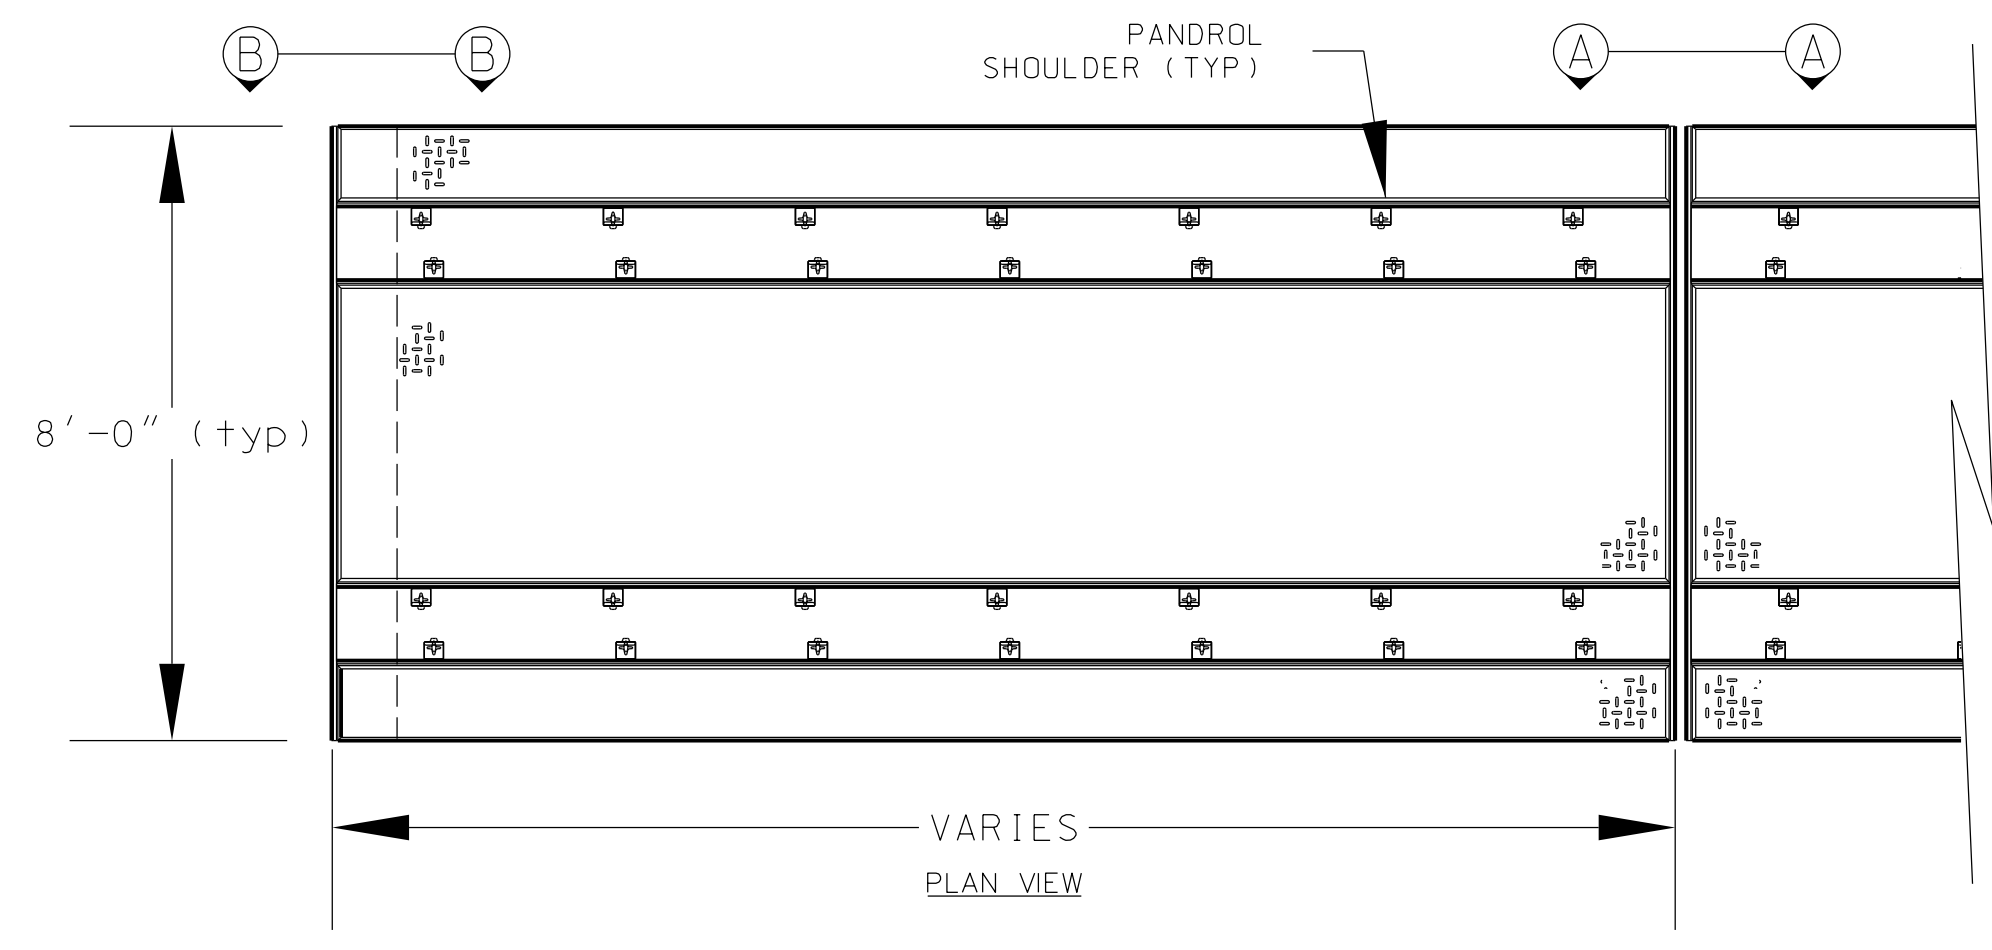


RUBBER RAIL GROOVE INSERTS IN ACCORDANCE WITH DETAIL #1 ABOVE, ARE NOT DEPICTED FOR CLARITY BUT SHALL BE INSTALLED FOLLOWING INSTALLATION AND THERMAL ADJUSTMENT OF CWR. APPLICATION OF RAIL FASTENERS AND FIELD WELDING OF CONNECTIONS TO EXISTING TRACK.

TYPICAL PRECAST FULL DEPTH CONCRETE GRADE CROSSING PANEL
NO SCALE

1. RUBBER INSERTS SHALL BE INSTALLED TO PROVIDE A 2 1/2" FLANGWAY. INSERTS AND RAIL FASTENERS MUST BE REMOVABLE AND REUSABLE TO FACILITATE RAIL ACCESS OR REPLACEMENT.
2. RAIL FASTENING SYSTEM INCORPORATED IN PRECAST CONCRETE CROSSING MODULES SHALL PROVIDE 1:40 RAIL CANT THROUGHOUT.
3. RESILIENT FASTENING SYSTEM RAIL SHOULDERS AND CLIPS SHALL BE HOT DIPPED GALVANIZED IN ACCORDANCE WITH THE SPECIFICATIONS.
4. GRIND BASE OF RAIL WELDS WHICH FALL WITHIN LIMITS OF CROSSING PANEL MODULES SMOOTH.
5. END MODULES TO HAVE 45 DEGREE SLOPE FROM BOTTOM OF RAIL TO TOP OF MODULE AND 1" TAPER UNDER RAIL.
6. ALL REINFORCING STEEL INCORPORATED IN CROSSING PANELS SHALL BE EPOXY COATED IN ACCORDANCE WITH PROJECT SPECIFICATIONS.

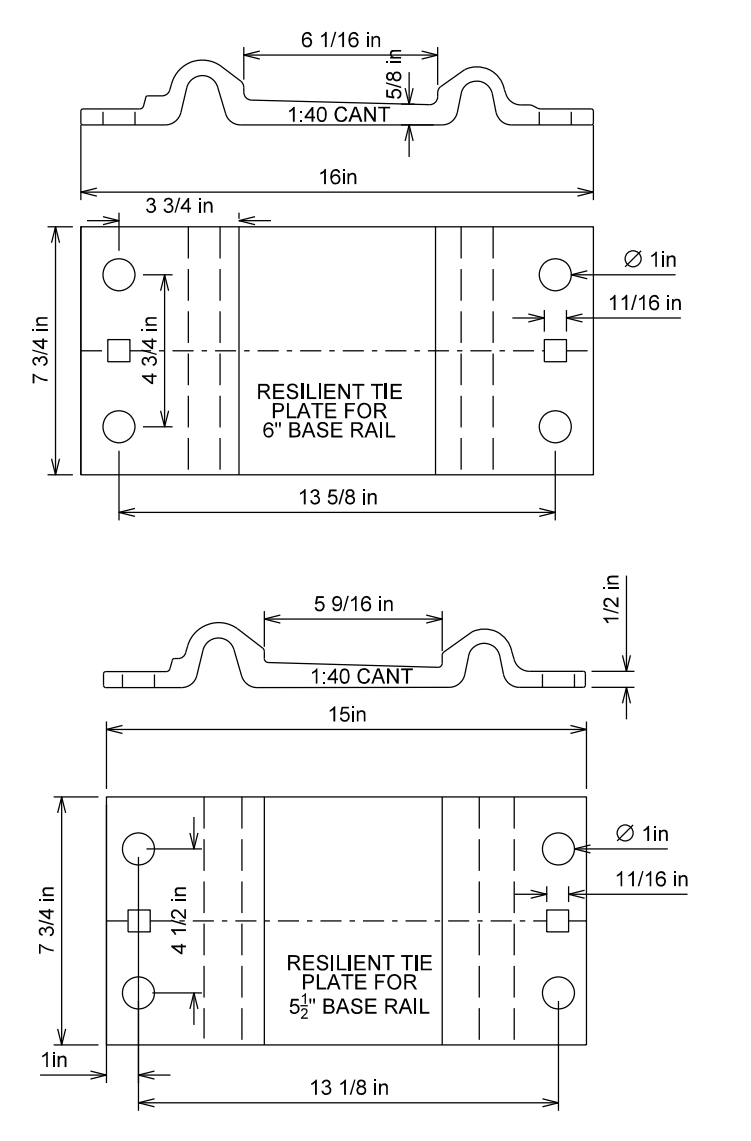

TYPICAL PANDROL TIE PLATE FOR USE WITH TIMBER CROSSTIES
NO SCALE

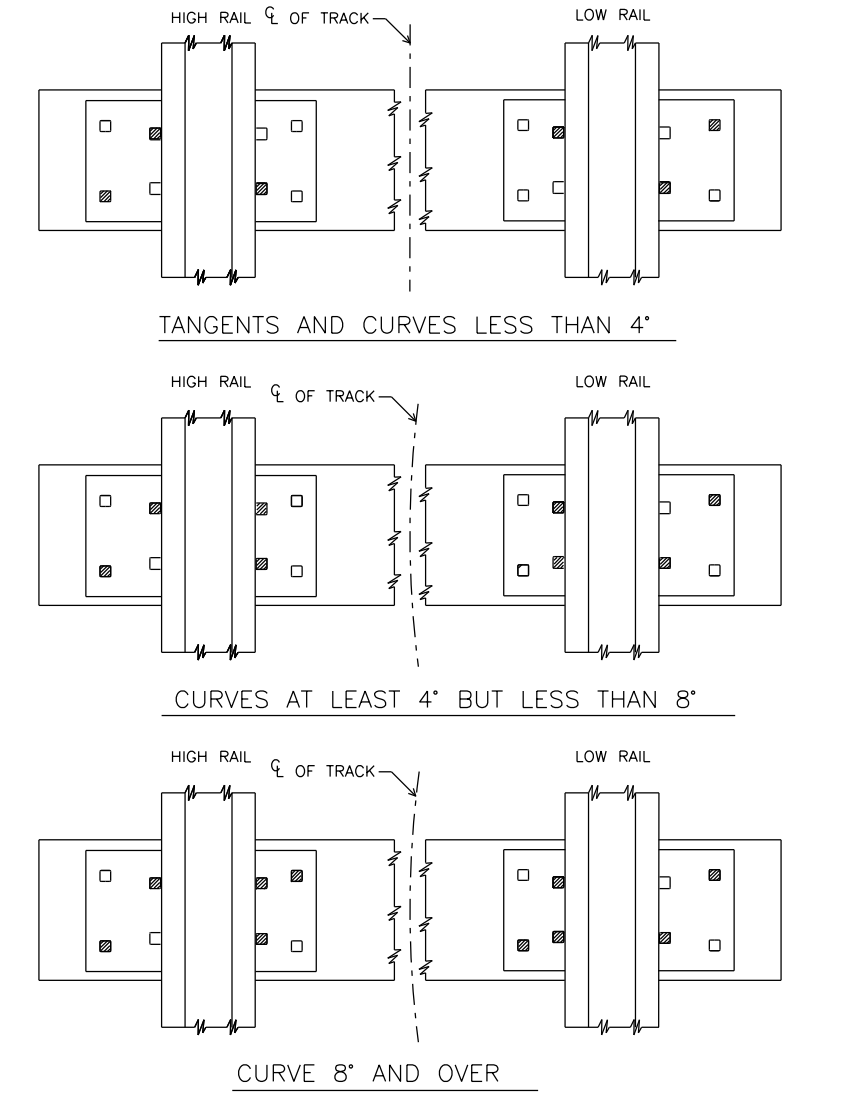

RAIL SPIKING PATTERN FOR 5/8" x 6" CUT SPIKES
NO SCALE

REV	BY	DATE	DESCRIPTION

ISSUED FOR BID

URBAN ENGINEERS URBAN ENGINEERS, INC.
530 Walnut Street
Philadelphia, PA 19106
(215) 922-8080 Fax (215) 922-8082

LOCATION: CAMDEN, N.J.




TITLE: S.J.P.C. BALZANO MARINE TERMINAL RAIL INFRASTRUCTURE REHABILITATION TRACK CONSTRUCTION DETAILS

NO. 24GE04337000

DATE: 08/11/2011

PROJ #


DRAWING NUMBER: T-24

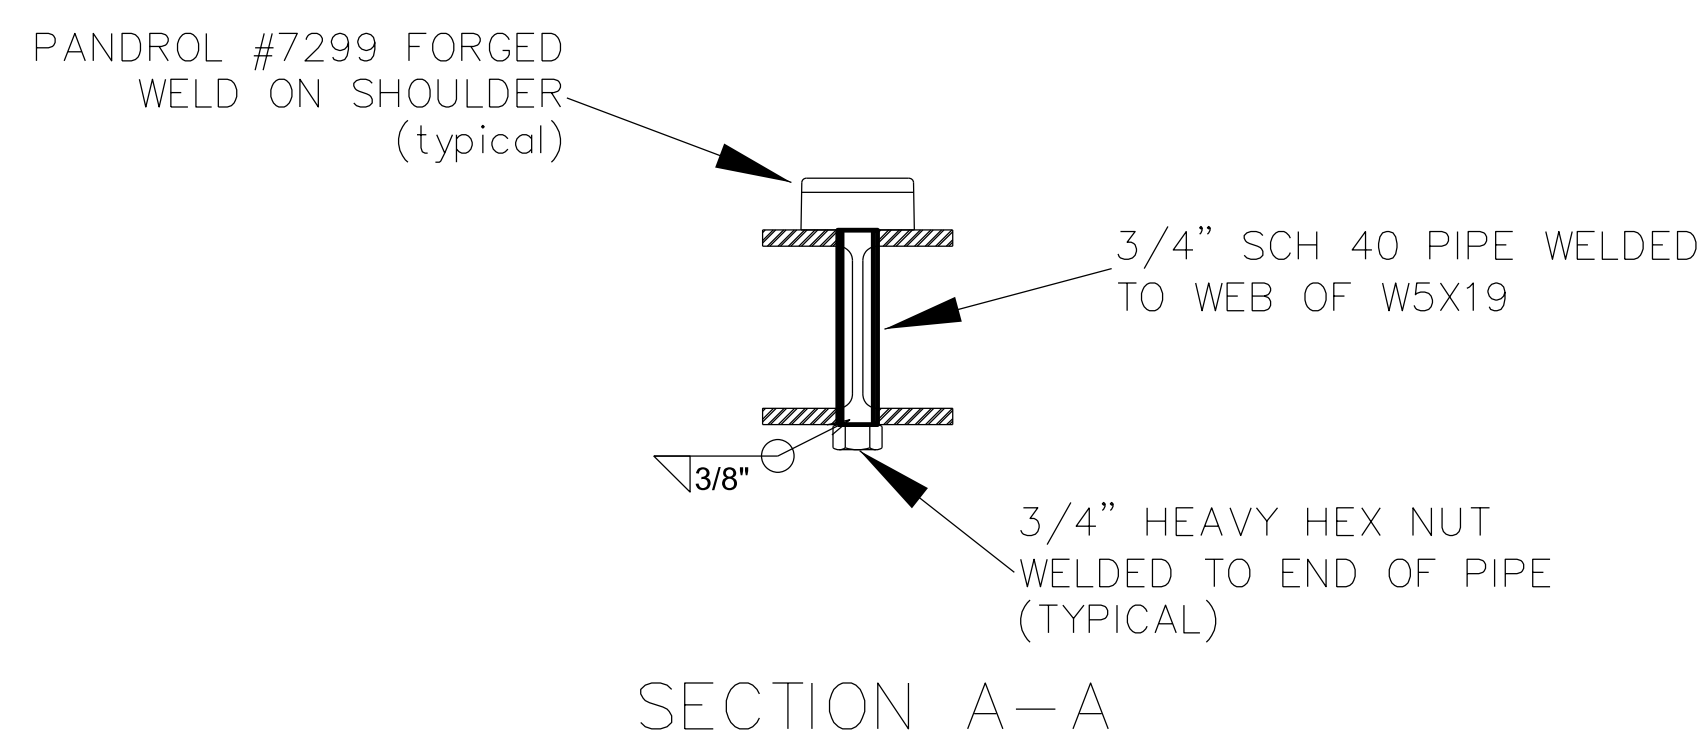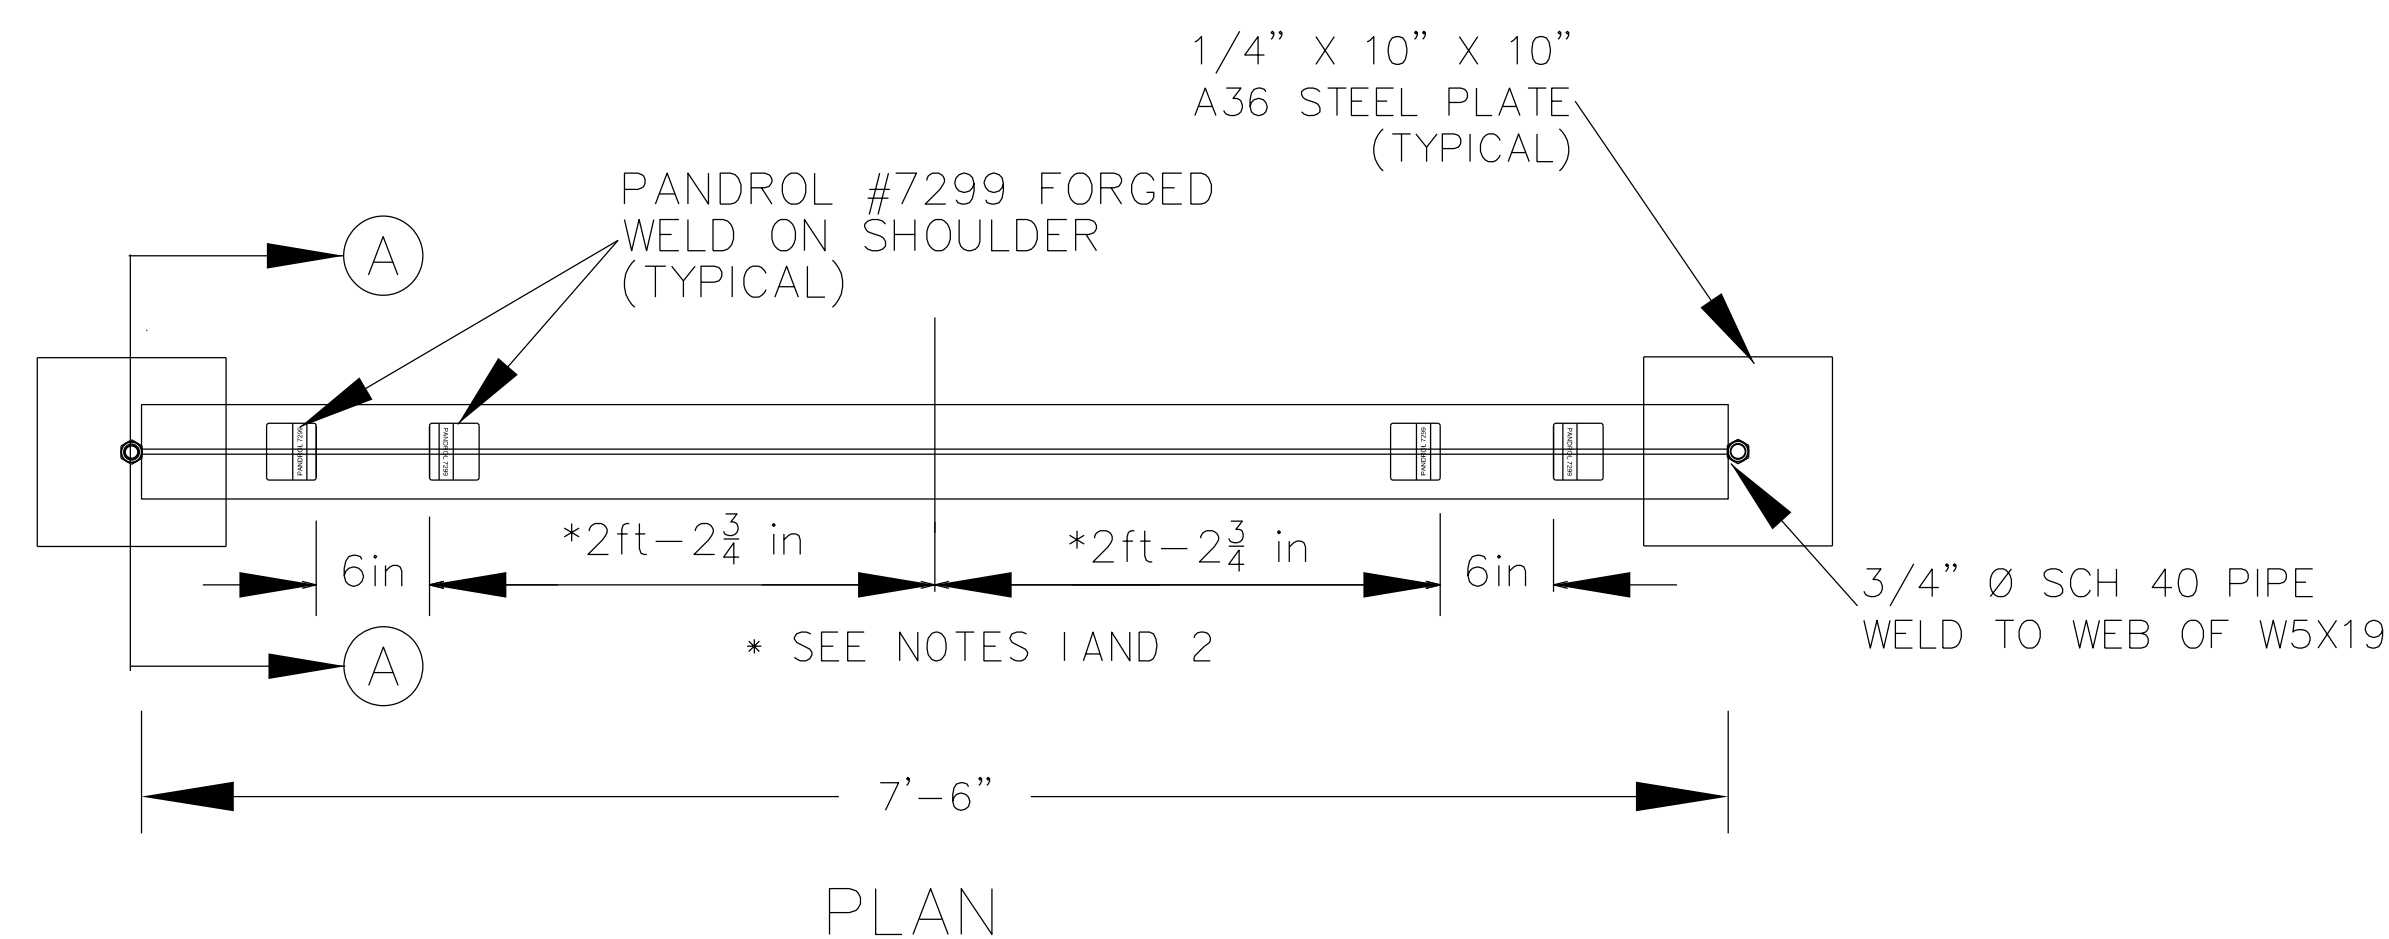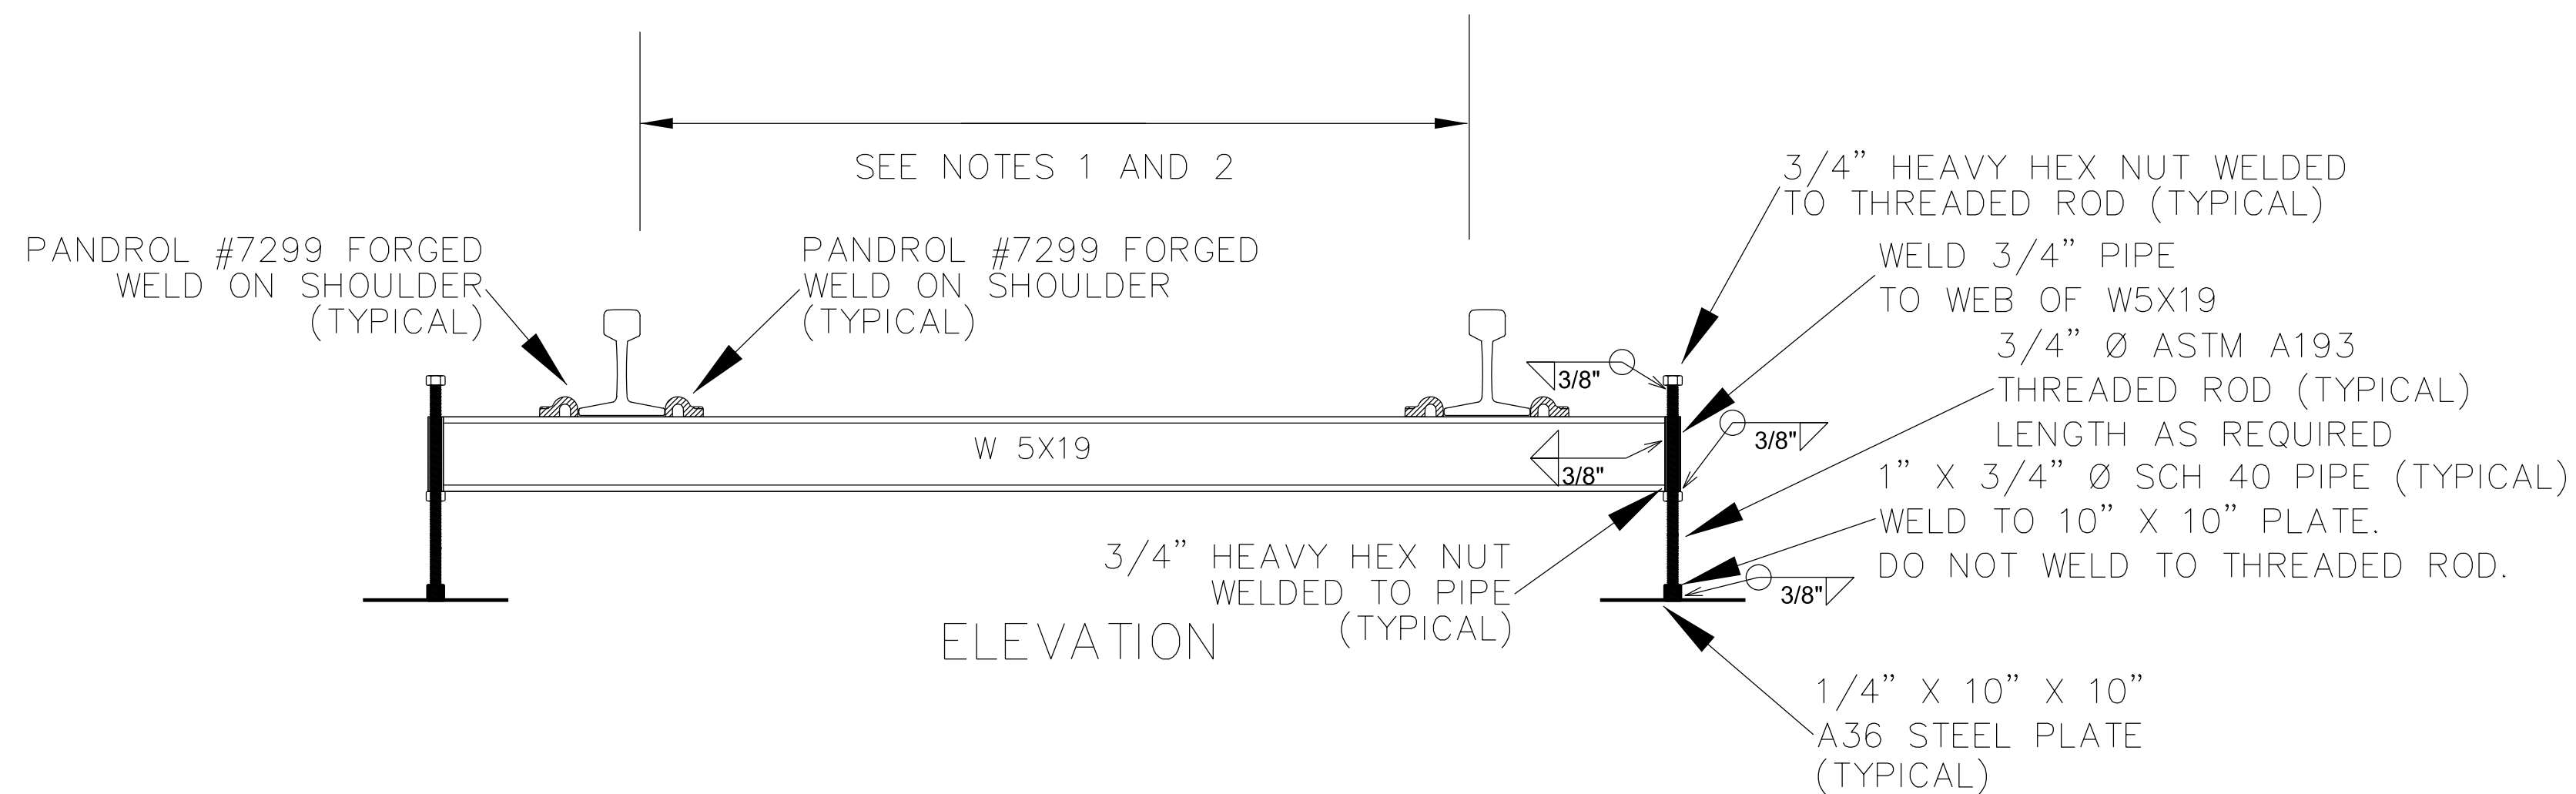


FABRICATED STEEL CROSSTIE FOR FULLY EMBEDDED TRACK
NO SCALE (1) T-25

NOTES


- 1) DIMENSIONS SHOWN FOR 136#RE RAIL. ADJUST TO PROVIDE CORRECT TRACK GAUGE FOR OTHER RAIL SECTIONS.
- 2) GAUGE SHALL BE AS FOLLOWS:
4'-8 1/2" ON TANGENTS AND CURVES < 13°
4'-9" ON CURVES > 13° AND THRU DIVERGING SIDE OF TURNOUTS < 1:8
- 3) FOR DETAILS OF PANDROL SHOULDER ATTACHMENT WELDS, SEE PANDROL DRAWING #USK-II36, SHEET 1 OF 4.

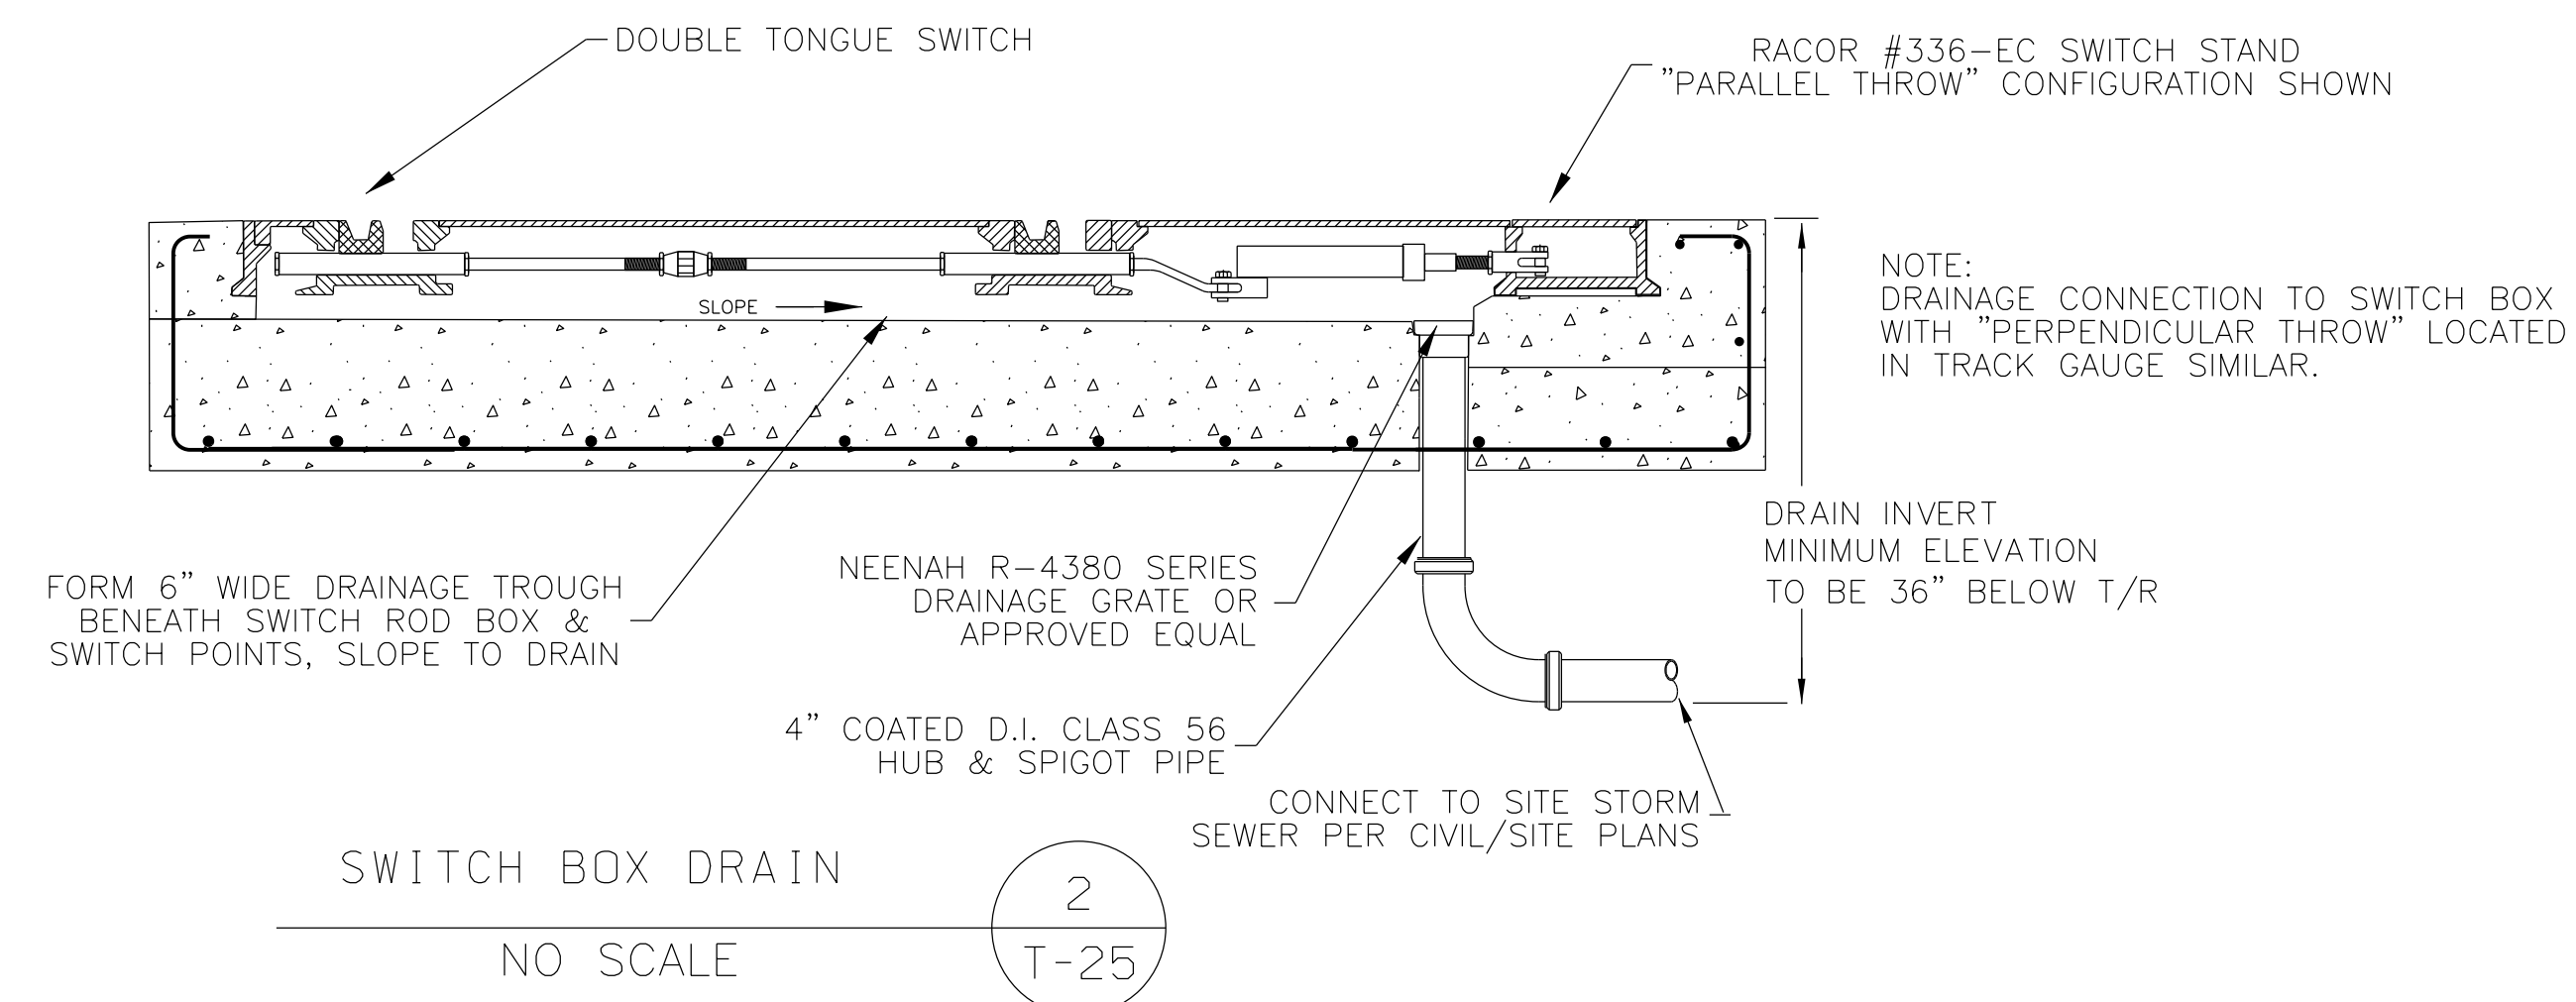

SWITCH BOX DRAIN
NO SCALE (2) T-25

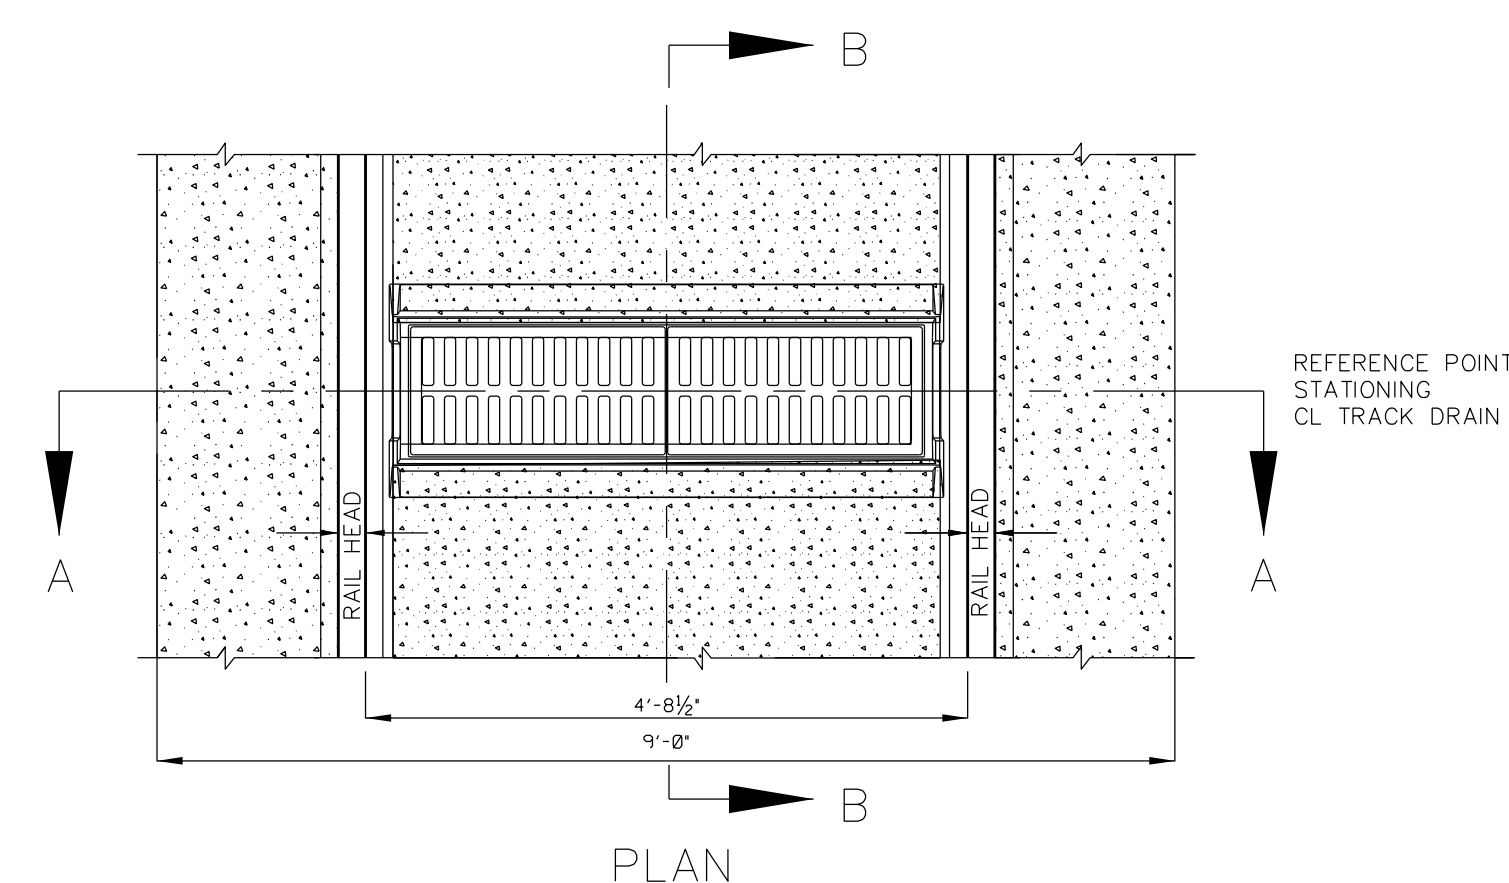

PLAN

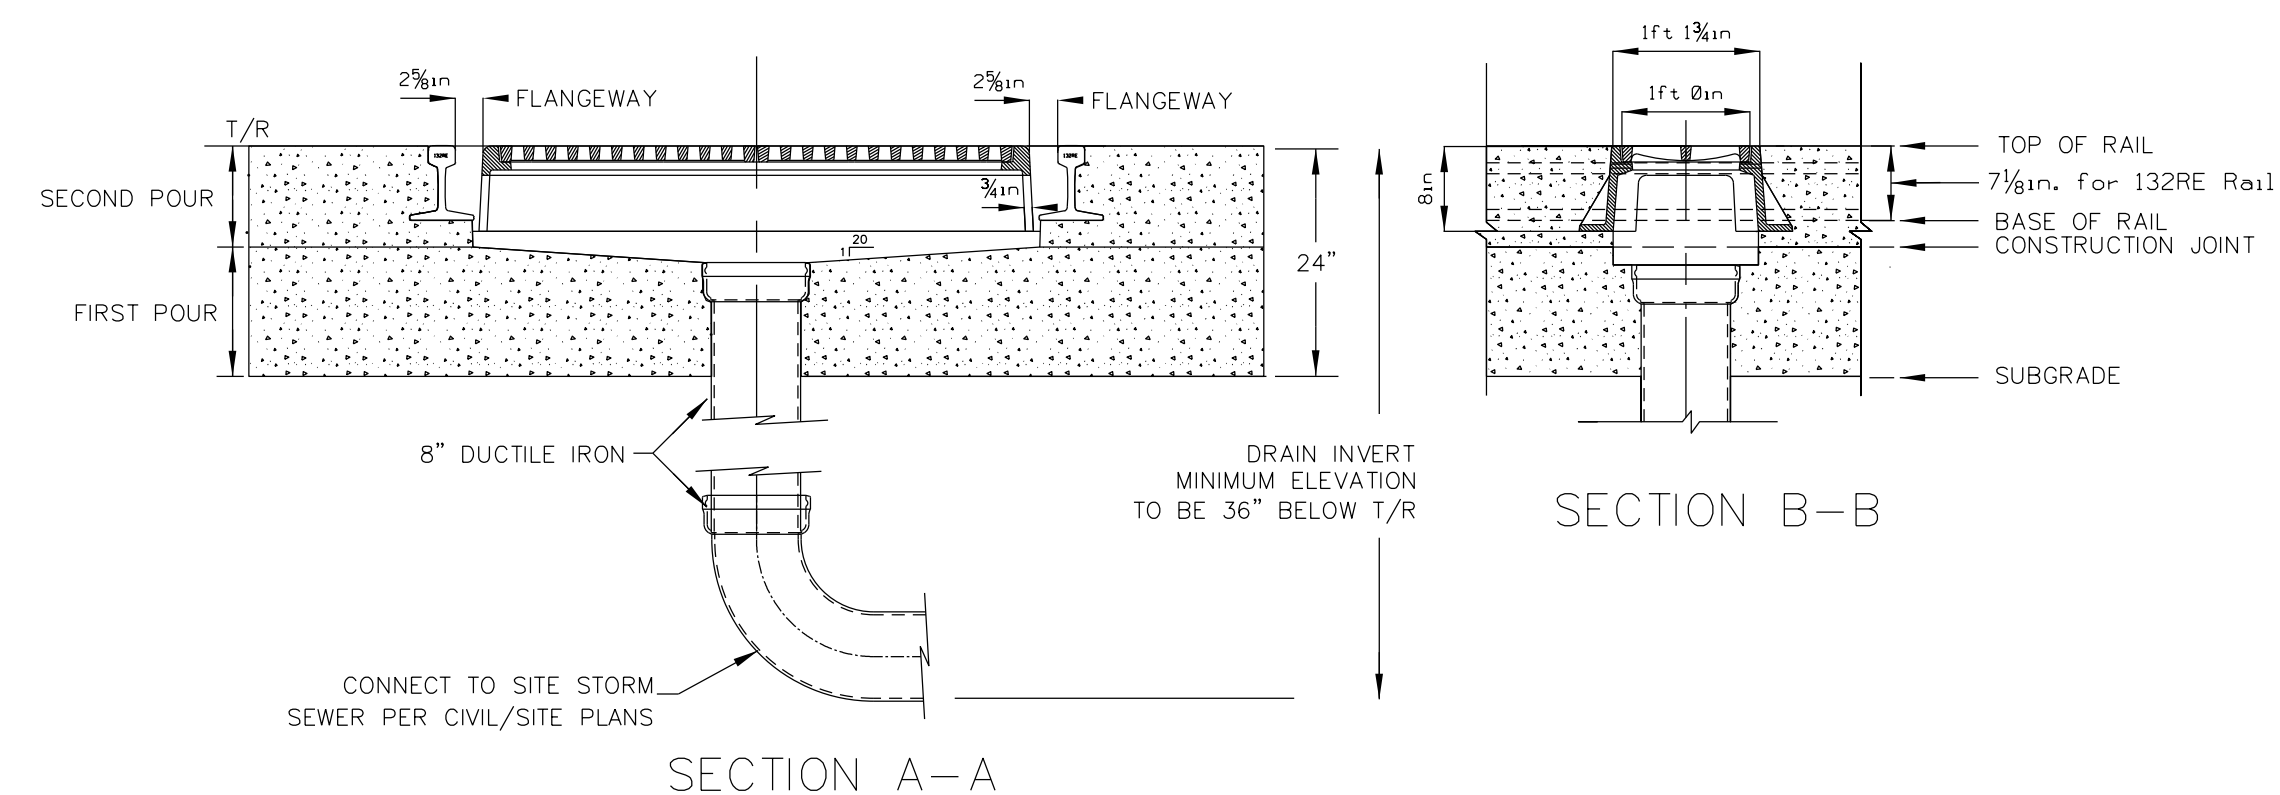

SECTION A-A


SECTION B-B

TRACK GAUGE DRAIN
NO SCALE (3) T-25

NOTE

- 1) DETAIL SHOWS NEENAH FOUNDRY #R-3420 GRATE AND FRAME.

REV	BY	DATE	DESCRIPTION

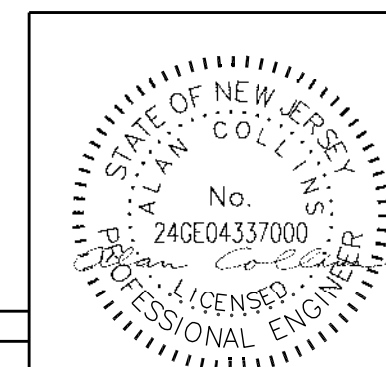

URBAN ENGINEERS, INC.
530 Walnut Street
Philadelphia, PA 19106
(215) 922-8080 Fax (215) 922-8082

LOCATION: **CAMDEN, N.J.**

TITLE: **S.J.P.C. BALZANO MARINE TERMINAL RAIL INFRASTRUCTURE REHABILITATION**


TRACK CONSTRUCTION DETAILS

DWN: FST PROJ #: DRAWING NUMBER: T-25
CRK: DATE:


ISSUED FOR BID

RESTRAINING RAIL INSTALLATION NOTES:


- 1) RESTRAINING RAIL TO BE PRECURVED WITH SPACER BLOCK HOLES DRILLED IN SHOP. HOLES IN RUNNING RAIL TO BE DRILLED IN FIELD TO MATCH LOCATIONS OF HOLES IN RESTRAINING RAIL.
- 2) RESTRAINING RAIL JOINTS SHALL BE FOUR (4) HOLE JOINT BARS MANUFACTURED TO FIT THE RAIL SECTION USED AND IN ACCORDANCE WITH SPECIFICATIONS OF THE A.R.E.M.A. MANUAL, CHAPTER 4, PART 3. IF REQUIRED, THE INSIDE BAR SHALL BE MILLED TO PROVIDE FLANGEWAY DIMENSIONS SHOWN.
- 3) END OF APPROACH RAILS TO BE SHOP MILLED AT FACE ANGLE OF 25° FOR A DISTANCE OF TWELVE (12) INCHES FROM END OF RAIL TAPERING FROM FULL WIDTH OF RAIL HEAD TO ZERO AS SHOWN.
- 4) END BLOCK TO BE ATTACHED WITH TWO (2) ONE (1) INCH DIAMETER SQUARE HEAD HIGH STRENGTH BOLTS, NUTS & NUTLOCKS AND AT FOUR (4) INCH CENTERS.
5. REFER TO AREMA PLAN #791 FOR FLANGEWAY WIDTHS REQUIRED AS APPLICABLE TO TRACK CENTERLINE DESIGN DEGREE OF CURVATURE.
6. RAIL CROSSTIE OR FASTENER SPACING SHALL BE ADJUSTED FOR TRACK CURVATURE AS DEFINED IN THE SPECIFICATIONS.

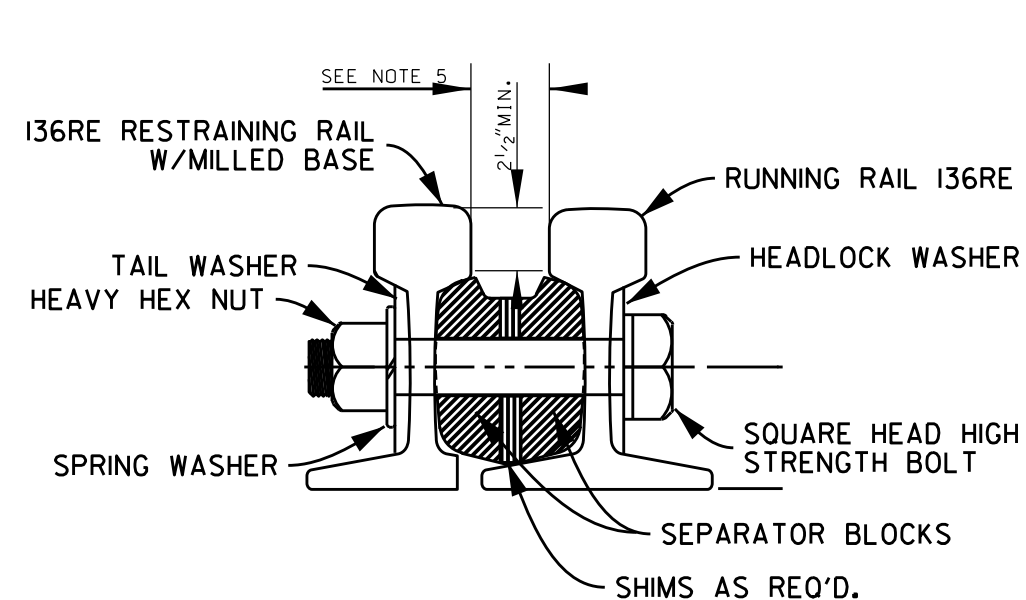


RESTRAINING RAIL SPACER BLOCK DETAIL SECTION A-A

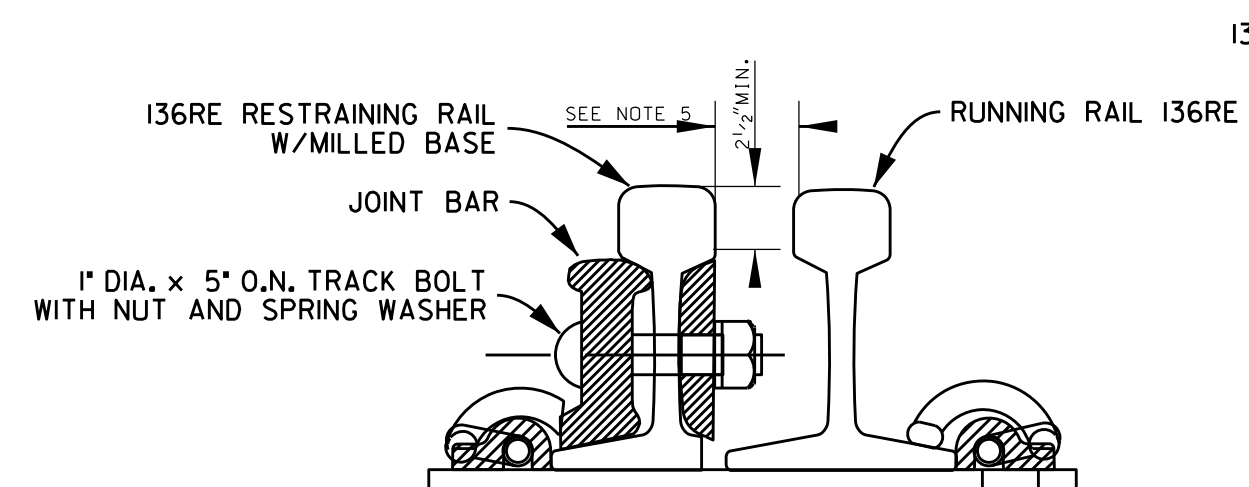


RESTRAINING RAIL JOINT ASSEMBLY SECTION B-B

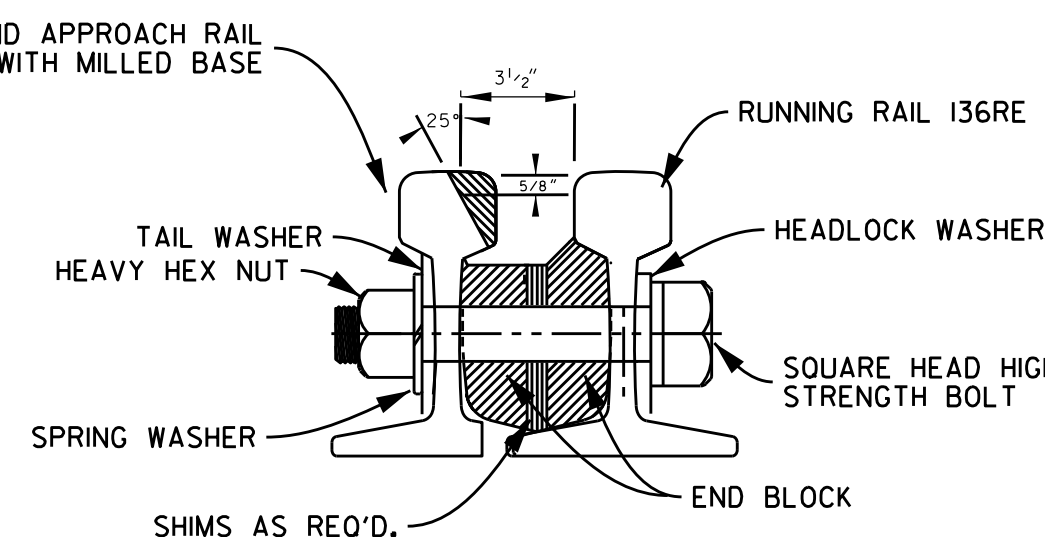



END BLOCK DETAIL SECTION C-C

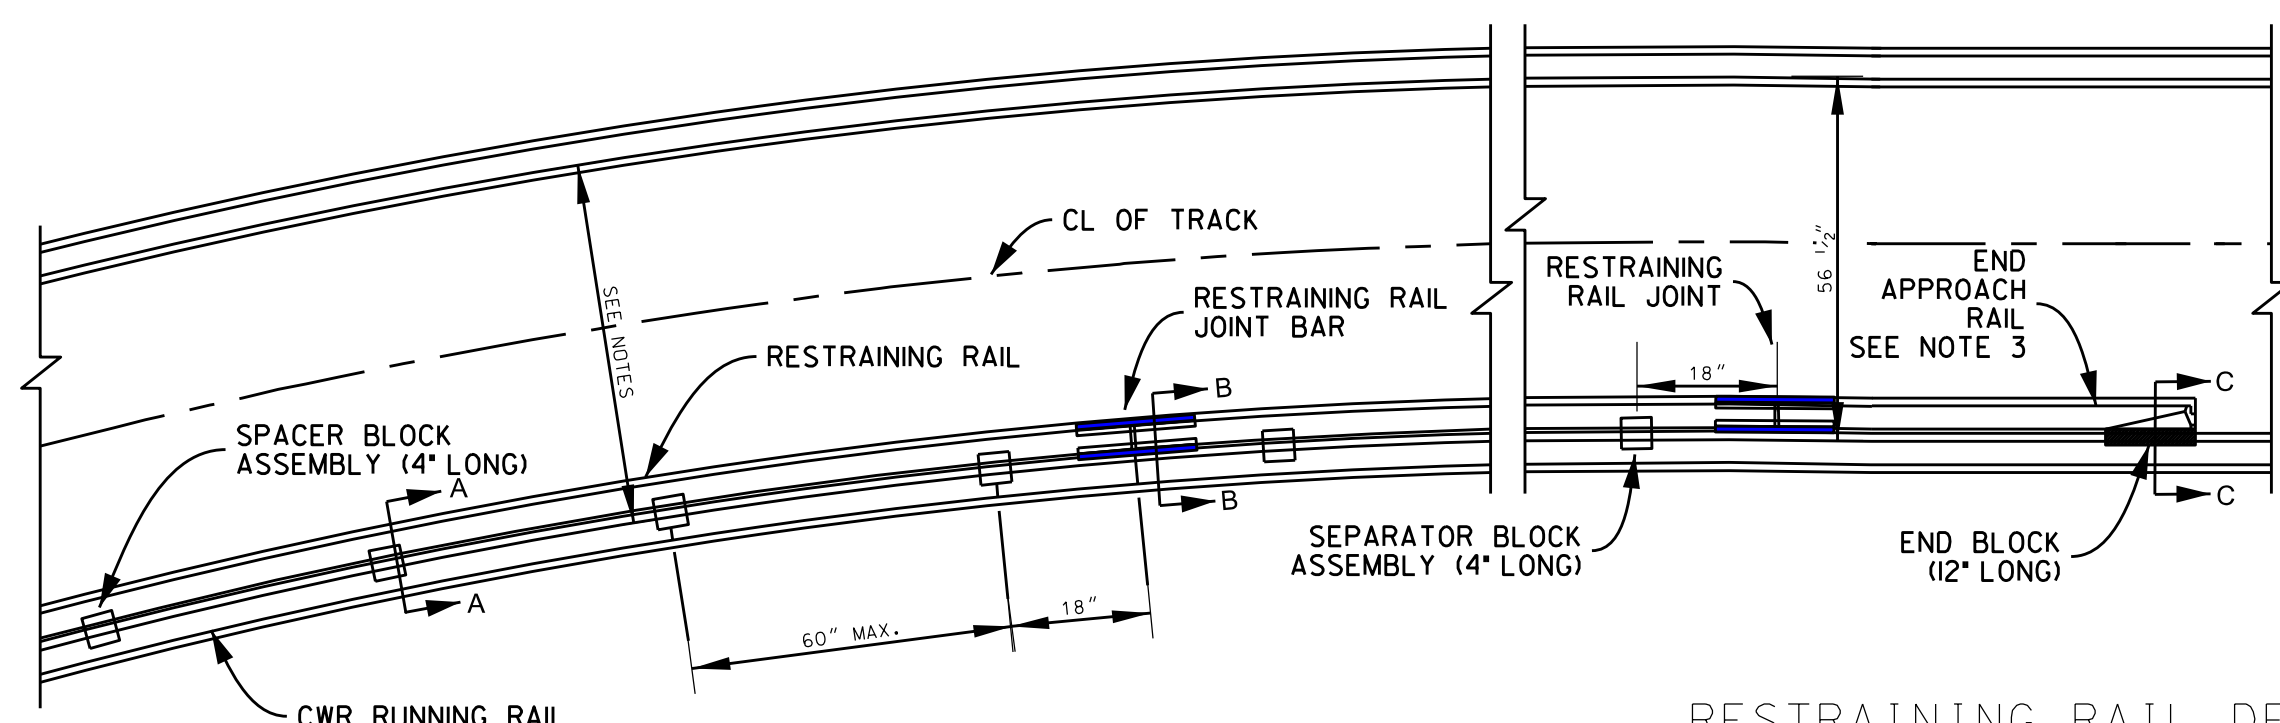


RESTRAINING RAIL DETAILS 1 NO SCALE T-26

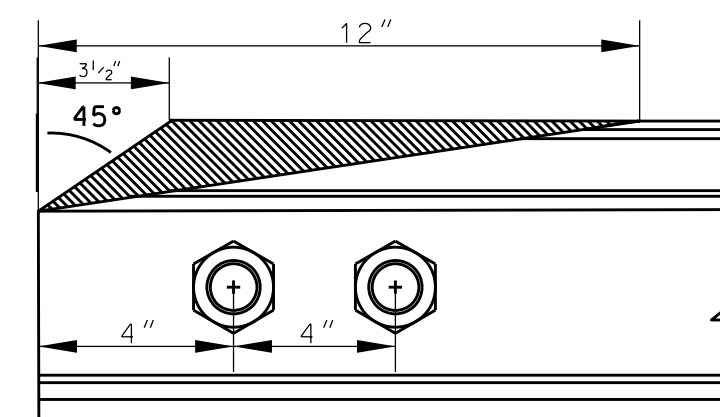


END APPROACH RAIL MILLING DETAIL

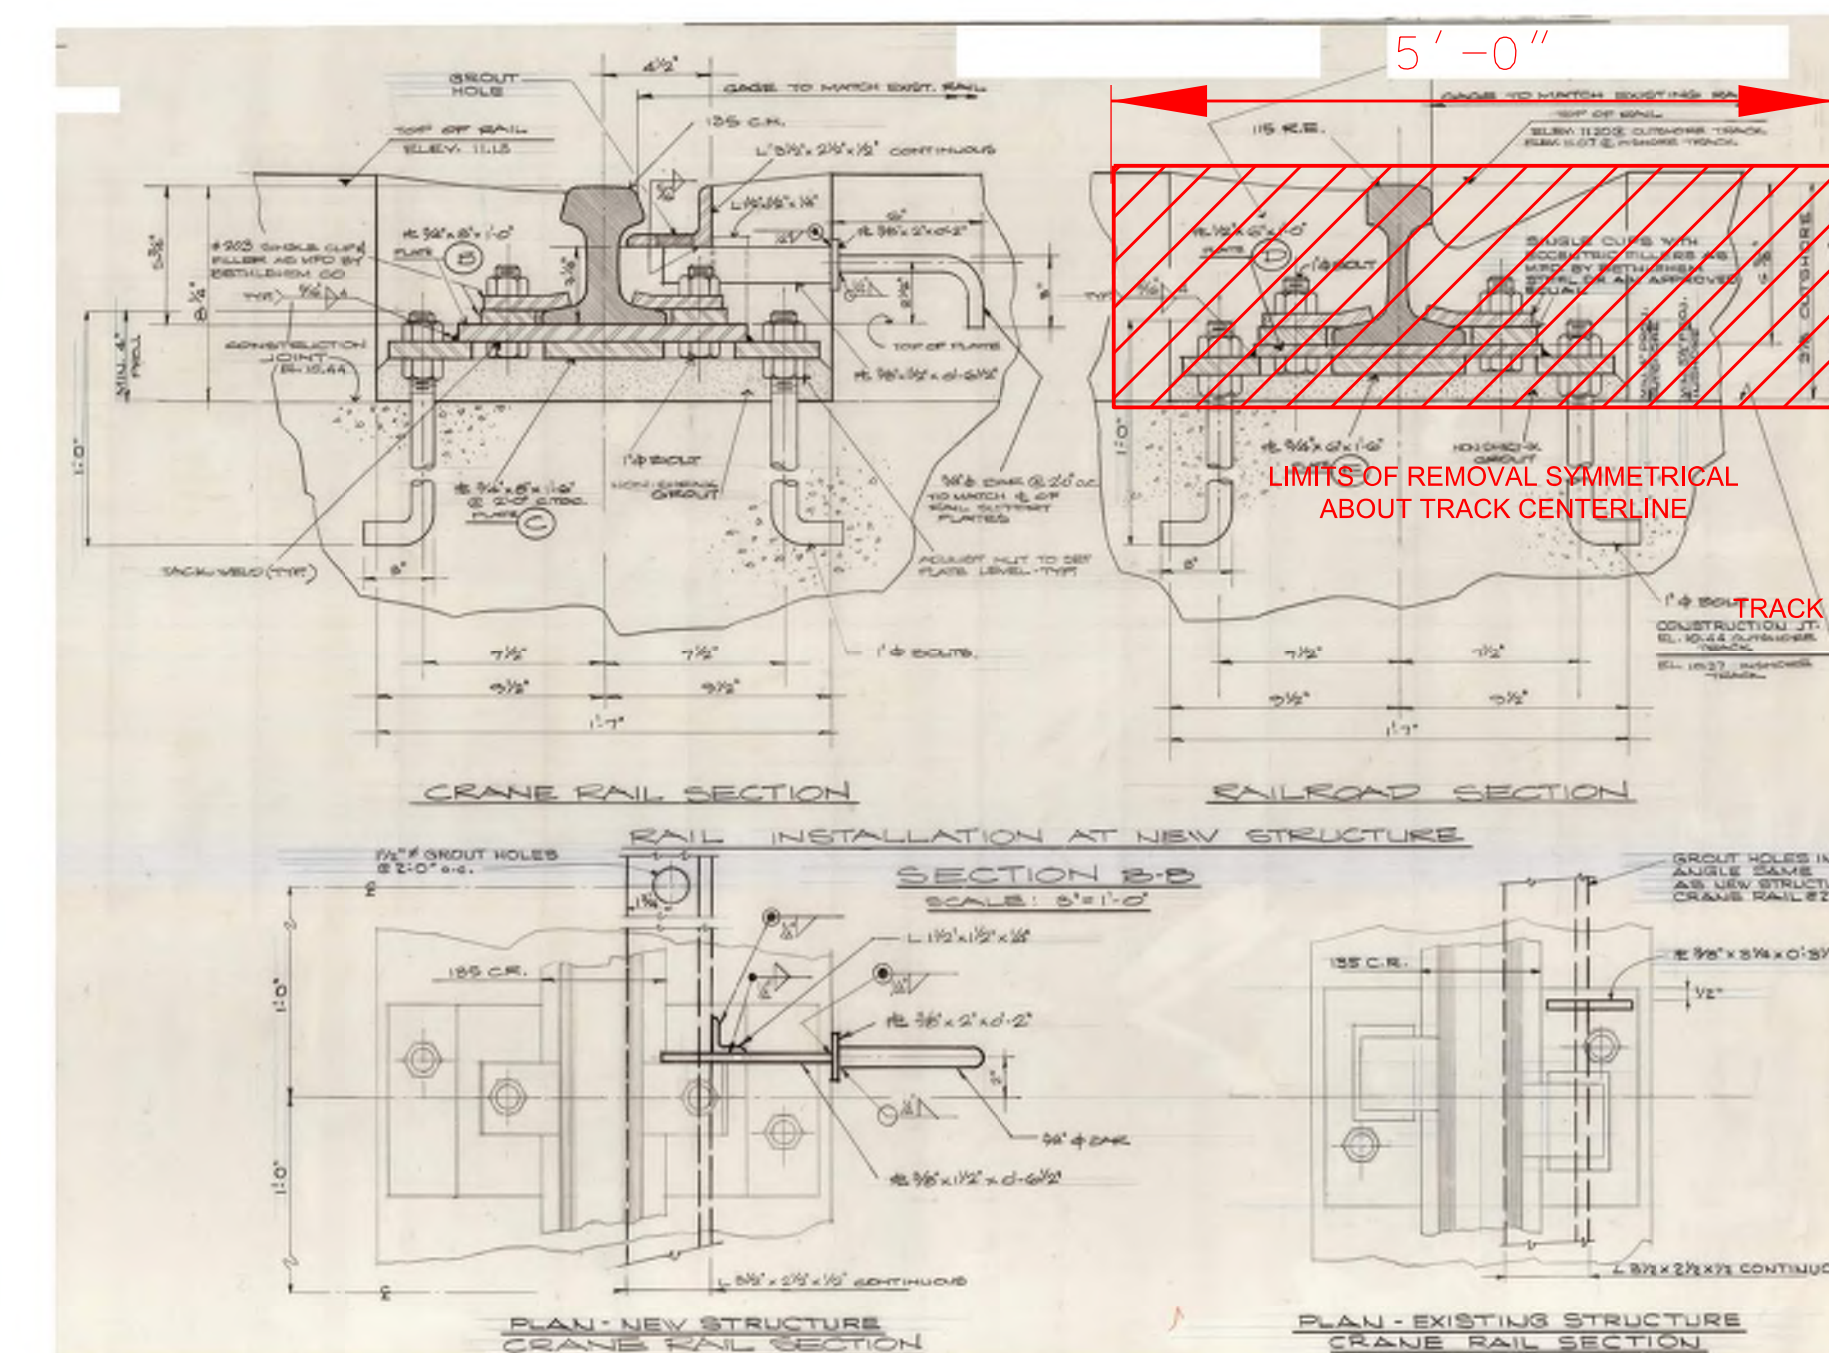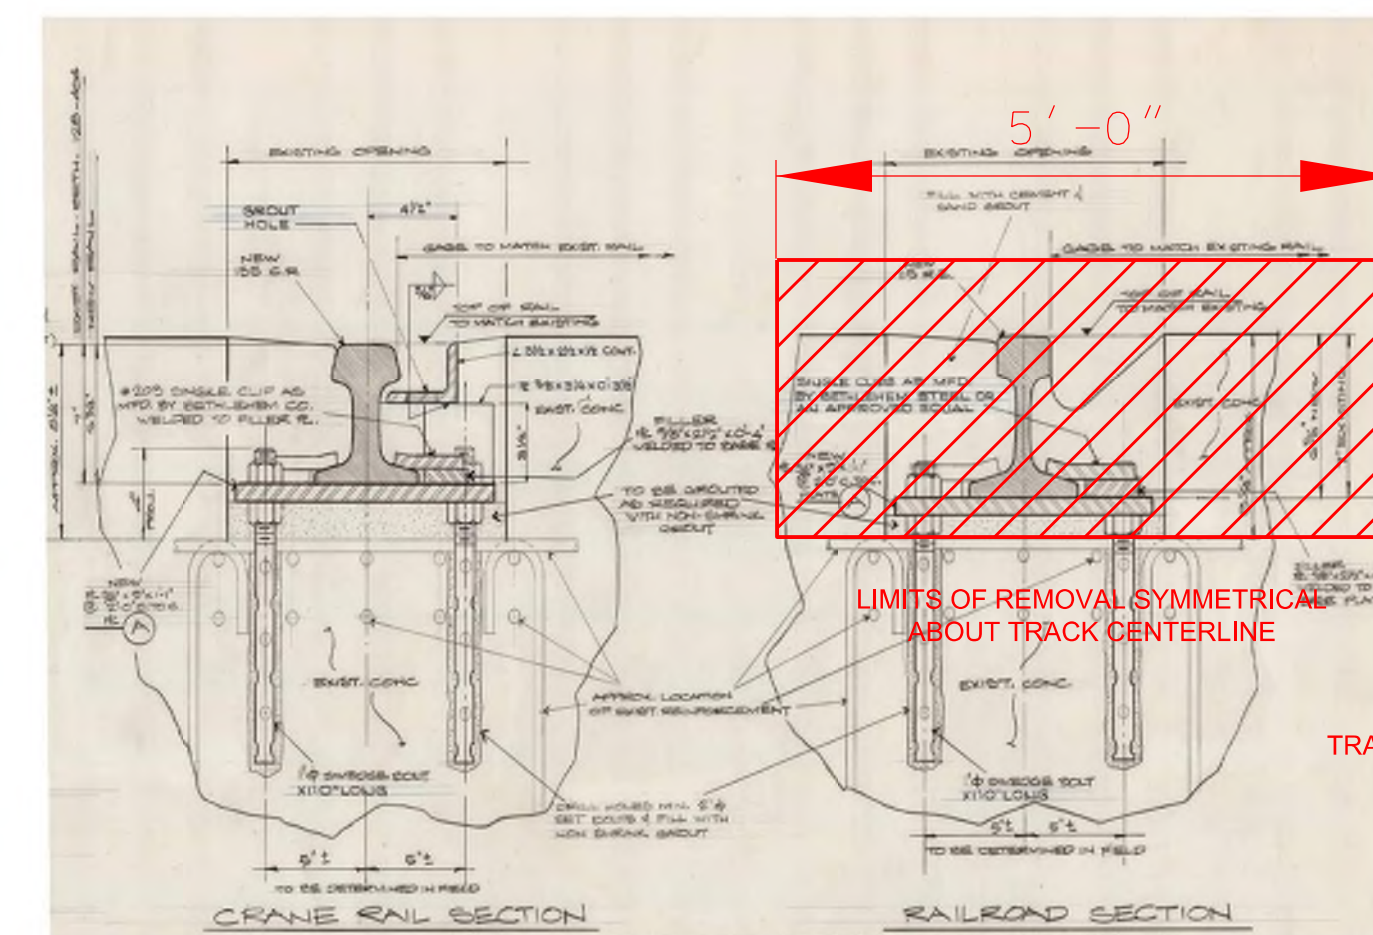


SELECTIVE DEMOLITION DETAIL FOR RAILS ON BERTH DECK 2 NO SCALE T-26

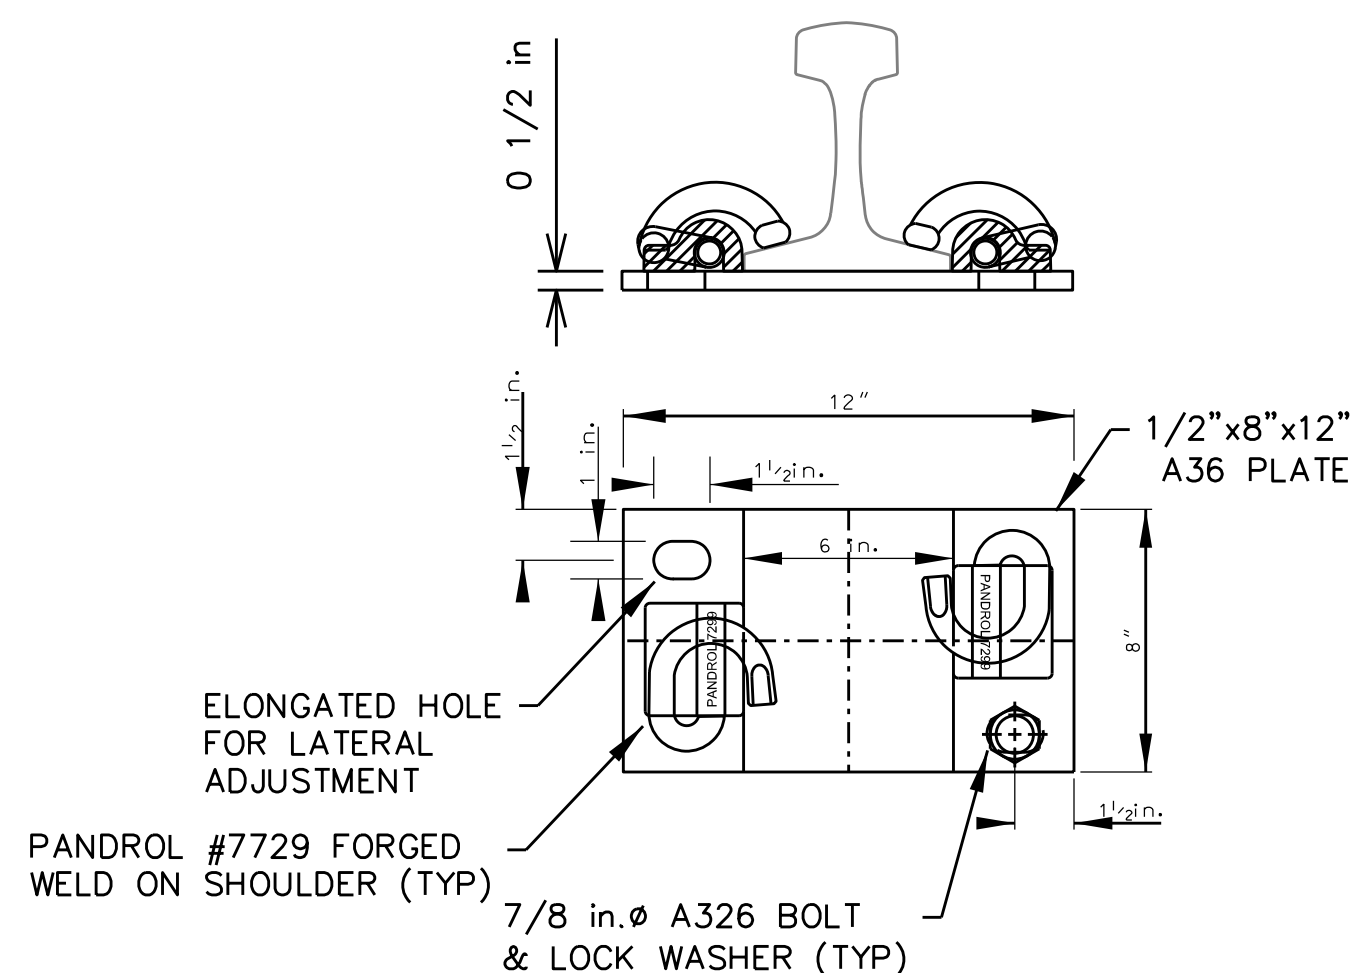

PANDROL #7729 FORGED WELD ON SHOULDER (TYP)

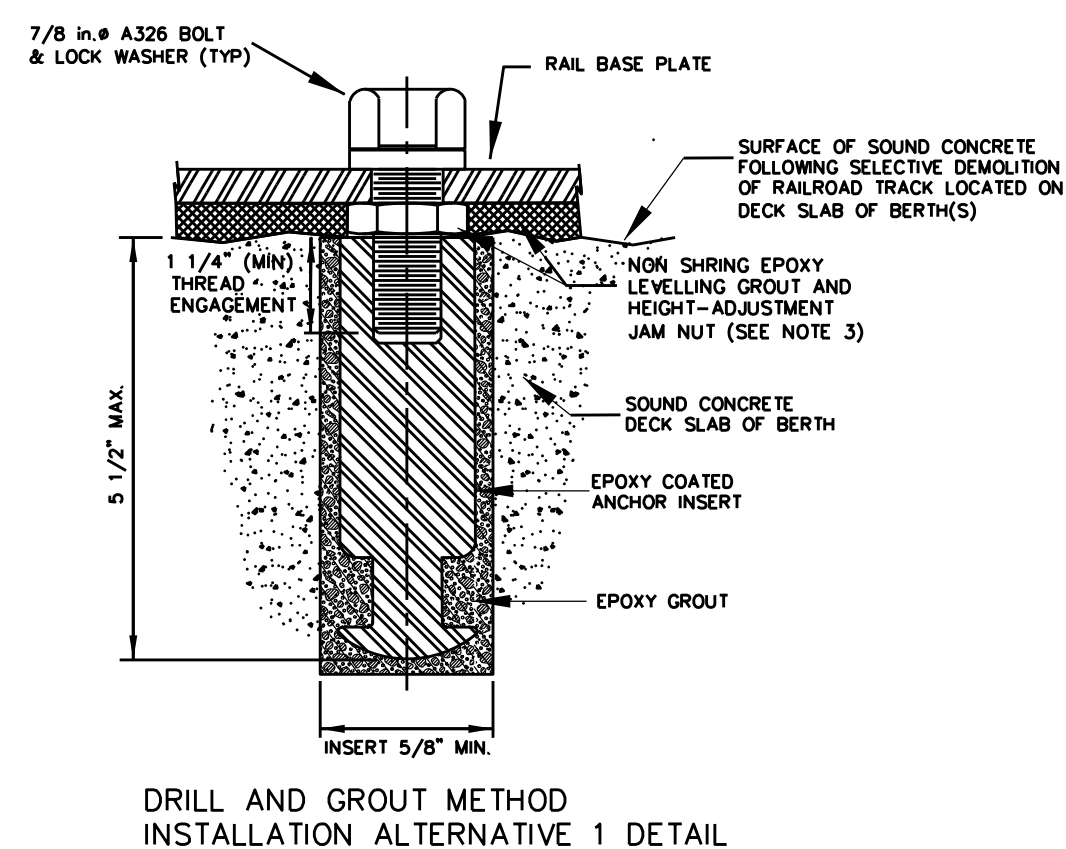

RAIL BASE PLATE INSTALLATION DETAIL FOR EMBEDDED TRACK LOCATED ON CONCRETE DECK PORTIONS OF BERTHS #3, #4 AND 4 EXTENSION 3 NO SCALE T-26

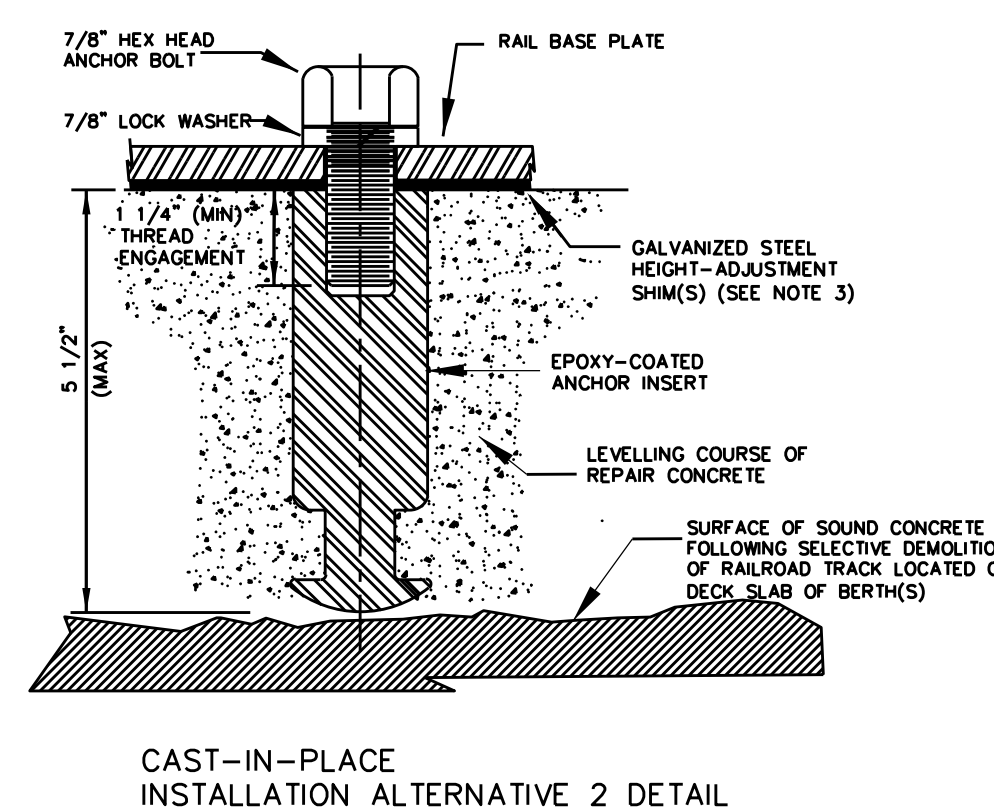

CAST-IN-PLACE INSTALLATION ALTERNATIVE 2 DETAIL


RAIL ATTACHEMENT AND BASE PLATE HARDWARE DETAILS FOR TRACK LOCATED ON DECK OF BERTHS:

- 1) AT THE OPTION OF THE INSTALLATION CONTRACTOR, AND AS POST DEMOLITION SITE CONDITIONS WARRANT, FOR THE FULLY EMBEDDED PORTION OF TRACK STRUCTURE, ANCHOR INSERTS SHALL BE INSTALLED BY EITHER THE "DRILL AND GROUT" METHOD OR, "CAST-IN-PLACE" METHOD, DURING THE PLACEMENT OF THE FINAL POUR OF CONCRETE, WHEN UTILIZING THE "TOP DOWN" METHOD OF TRACK CONSTRUCTION.
- 2) THE HEIGHT-ADJUSTMENT SHIMS SHALL PROVIDE 1/4 INCH MINIMUM HORIZONTAL PROJECTION BEYOND ALL SIDES OF THE FASTENER AT ANY INSTALLED POSITION.
- 3) TOTAL NUMBER OF SHIMS PLACED UNDER RAIL BASE PLATES FOR HEIGHT ADJUSTMENT SHALL BE LIMITED TO A MAXIMUM OF TWO SHIMS OR A MAXIMUM TOTAL THICKNESS OF 1/2". THICKNESS OF NON SHRINK GROUT SHALL BE NO MORE THAN RECOMMENDED FOR INSTALLATION BY THE MANUFACTURER OR 2 INCHES, WHICHEVER IS LESS. CONTRACTOR SHALL PLACE REMOVABLE PLASTIC PLUGS IN THE THREADED SOCKET OF ANCHORS TO PREVENT GROUT OR OTHER FOREIGN MATERIALS FROM ENTERING THREADED SOCKETS OF ANCHORS DURING PLACEMENT OF EPOXY GROUT OR LEVELLING COURSE OF CONCRETE.
- 4) WHERE DF RAIL FASTENERS ARE LOCATED UNDER RAIL JOINTS, INSTALL PANDROL TYPE "E-2063" RAIL CLIPS OR APPROVED EQUALS.
- 5) RAIL PLATE AND FASTENER SPACING SHALL BE NO MORE THAN 24 INCHES CENTER TO CENTER ALONG CENTERLINE LINE OF TRACK.
- 6) CONTRACTOR MAY UTILIZE NARSTCO #1599 STEEL CROSSTIES OR OTHER MANUFACTURERS PROPRIETARY DESIGN OF APPLICABLE BASE PLATES AND RAIL FASTENING SYSTEM. USE OF SUCH PRODUCTS SHALL BE SUBJECT TO PRIOR APPROVAL OF ENGINEER IN LIEU OF THE DETAILS SHOWN. 7
- 7) TRACK GAUGE SHALL BE ADJUSTED FOR CURVES AND THRU TURNOUTS IN ACCORDANCE WITH NOTES ON SHEET T-25.

SELECTIVE TRACK DEMOLITION NOTES:

- 1) REFER TO SHEETS EX-0, EX-1, EX-2 & EX-3 FOR APPLICABLE LIMITS AND CONSTRUCTION DETAILS OF EXISTING PORTIONS OF TRACK LOCATED ON PILE SUPPORTED REINFORCED CONCRETE DECK OF BERTHS #3, #4 AND #4 EXTENSION.
- 2) CONTRACTOR SHALL SUBMIT TO ENGINEER, THE PROPOSED MEANS AND METHODS TO BE EMPLOYED DURING SELECTIVE DEMOLITION WORK REQUIRED FOR THE REMOVAL OF TRACK LOCATED ON THE REINFORCED CONCRETE DECK OF BERTHS #3, #4 AND #4 EXTENSION FOR PRIOR APPROVAL AND IN ACCORDANCE WITH THE PROJECT SPECIFICATIONS BEFORE COMMENCING ANY SUCH DEMOLITION WORK.
- 3) CONTRACTOR TO UTILIZE METHODS TO CUT EXPOSED PORTION OF EXISTING RAIL-BASE PLATE ANCHOR BOLTS THAT DO NOT RESULT IN COLLATERAL DAMAGE TO SOUND CONCRETE OF THE DECK OF BERTHS. CONTRACTOR SHALL TAKE CARE TO AVOID DAMAGE TO EXISTING CONCRETE REINFORCING STEEL WHEN PERFORMING ALL SELECTIVE DEMOLITION WORK.
- 4) INSPECT CONDITION OF EXISTING CONCRETE AND STEEL REINFORCING OF PILE SUPPORTED CONCRETE BERTH DECKS FOR SOUNDNESS. IF DETERIORATION OR EXCESSIVE CORROSION IS DISCOVERED, IMMEDIATELY STOP SELECTIVE DEMOLITION WORK AND REQUEST INSPECTION AND FURTHER DIRECTION FROM ENGINEER.

REV	BY	DATE	DESCRIPTION

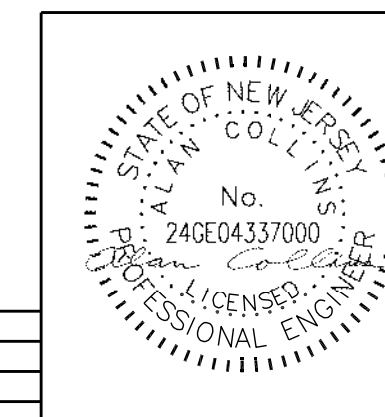



ISSUED FOR BID

URBAN ENGINEERS, INC.
530 Walnut Street
Philadelphia, PA 19106
(215) 922-8080 Fax (215) 922-8082

LOCATION: **CAMDEN, N.J.**

TITLE: **S.J.P.C. BALZANO MARINE TERMINAL RAIL INFRASTRUCTURE REHABILITATION MISC. TRACKWORK DETAILS**


DATE: **FST** PROJ # DRAWING NUMBER **T-26**

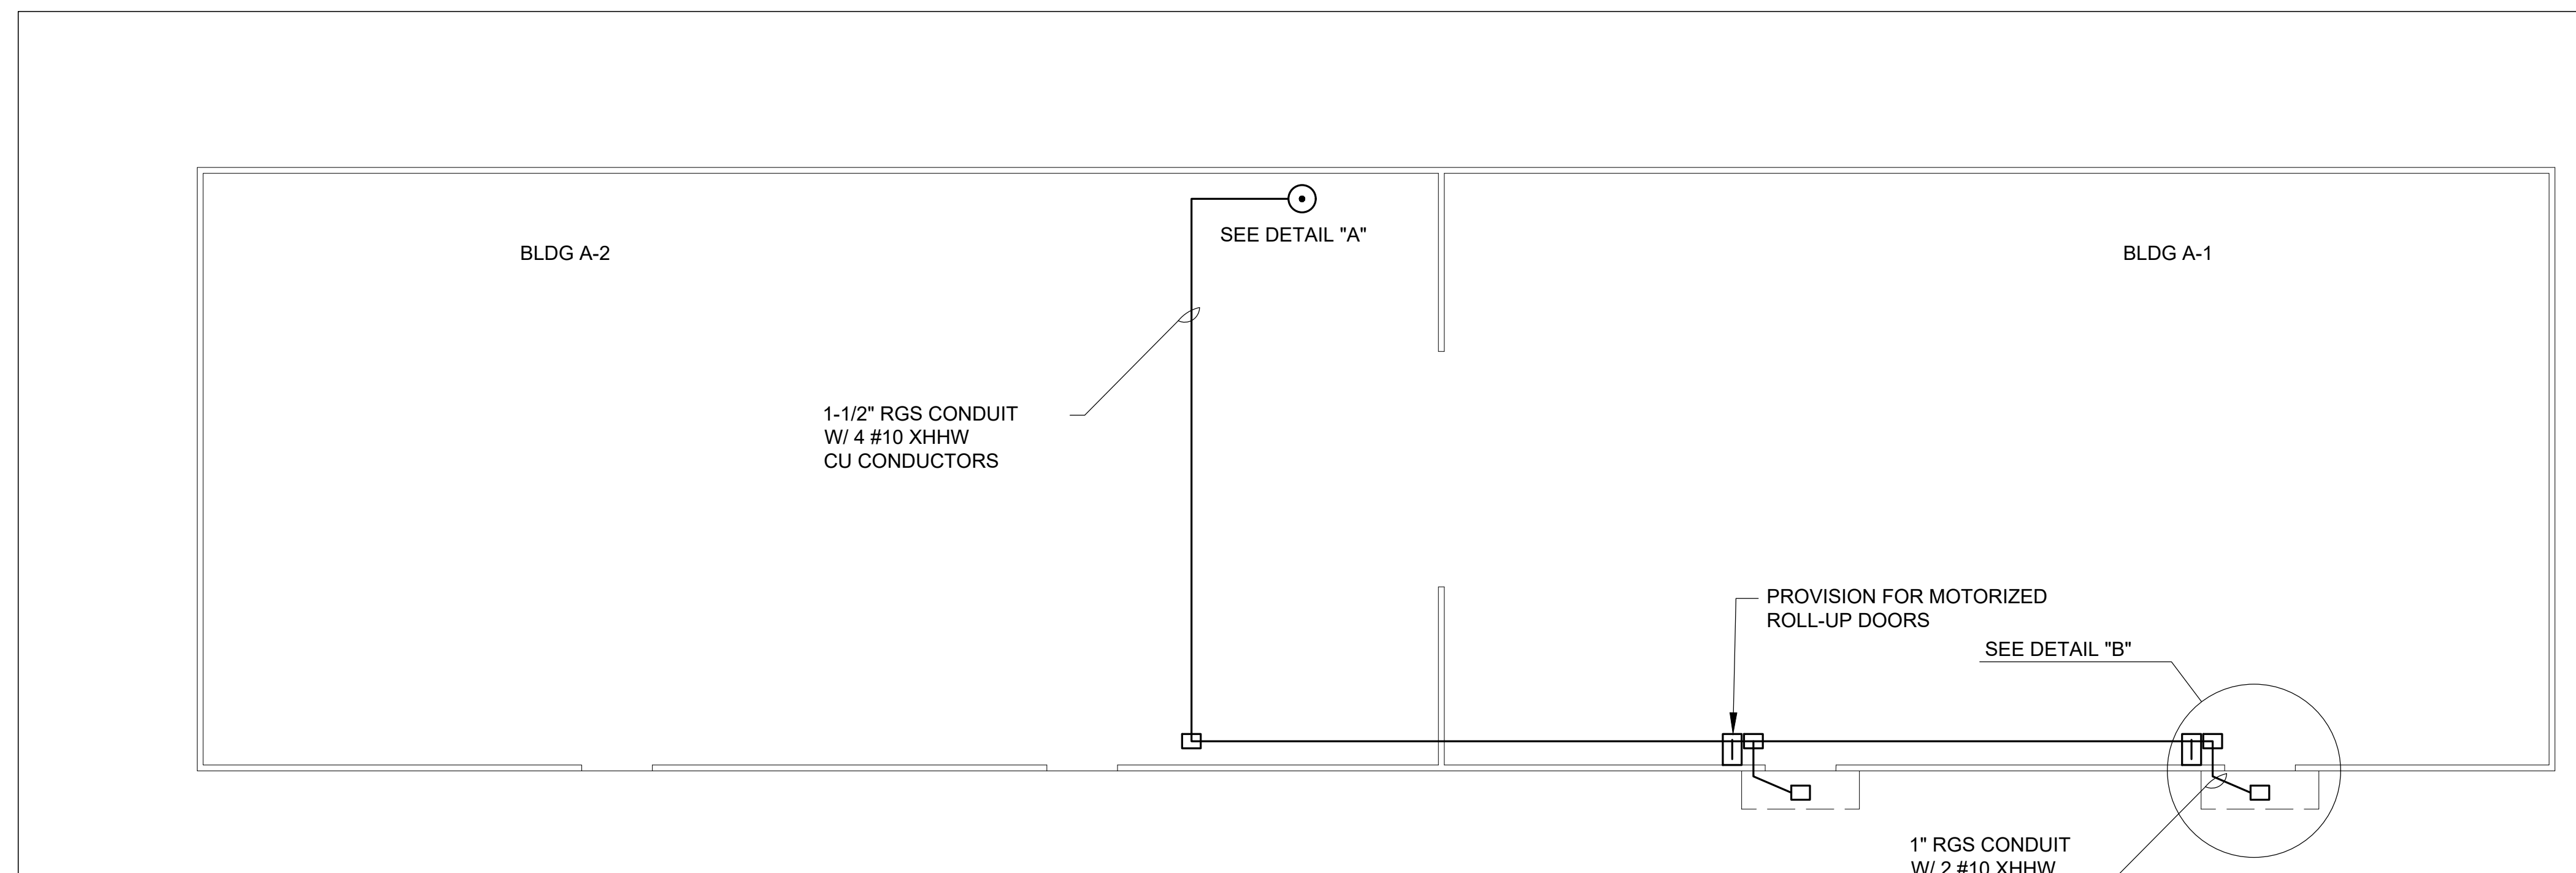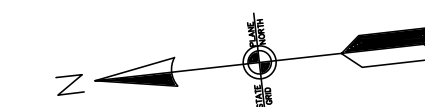


1 BUILDING A CONDUIT SCHEMATIC
 Scale: 1" = 20'-0"
 GRAPHIC SCALE

NOTES:

1. ALL WORK ON THIS SHEET ASSOCIATED WITH ADD ALTERNATE #1.
2. ALL WIRING IS DIAGRAMMATIC. EXACT DIMENSIONS, LENGTH OF CONDUIT RUNS, ETC TO BE DETERMINED IN FIELD.
3. LIGHT FIXTURE SPECIFIED (TOTAL OF 4) ARE LITHONIA CNYLEDP240KMVOLTDDBM4. THIS SPECIFIED LIGHT FIXTURE INCLUDES A QUICK-MOUNT MECHANISM FOR MOUNTING TO THE RECESSED JUNCTION BOX NOTED IN DETAIL B.
4. 1-1/2" RGS CONDUITS ARE TO BE RUN ON, AND ATTACHED TO, THE BOTTOM CHORDS OF EXISTING ROOF TRUSSES. IF ADDITIONAL INTERMEDIATE SUPPORT IS REQUIRED, IT IS TO BE IN ACCORDANCE WITH TABLE 344.30(B)(2) OF THE NEC, LATEST EDITION.
5. DISABLE POWER TO LIGHTS ON EXISTING FLAGPOLE. TURN OFF CKT. BKR. IN TRANSIT SHED NO. 2 & CUT WIRES AT WEATHERHEAD. FOR LOCATION OF FLAGPOLE, SEE DRAWING T-3. THE WIRING AT THE WEATHER HEAD SHOULD HAVE 12 " PIGTAILS THAT ARE CAPPED AND TAPED. IF THE REPLACEMENT LIGHT IS NOT ADDED IN A TIMELY MANNER, THEN THE CIRCUIT BREAKER SHOULD BE REMOVED, OR TAGGED WITH A NOTE STATING THAT IT SHOULD NOT BE MOVED TO THE CLOSED POSITION.
6. PROVIDE SIMILAR ELECTRICAL CONDUIT AT TWO NEW DOORS AND OVERHEAD LIGHT FIXTURES AT TRANSIT SHED 1.

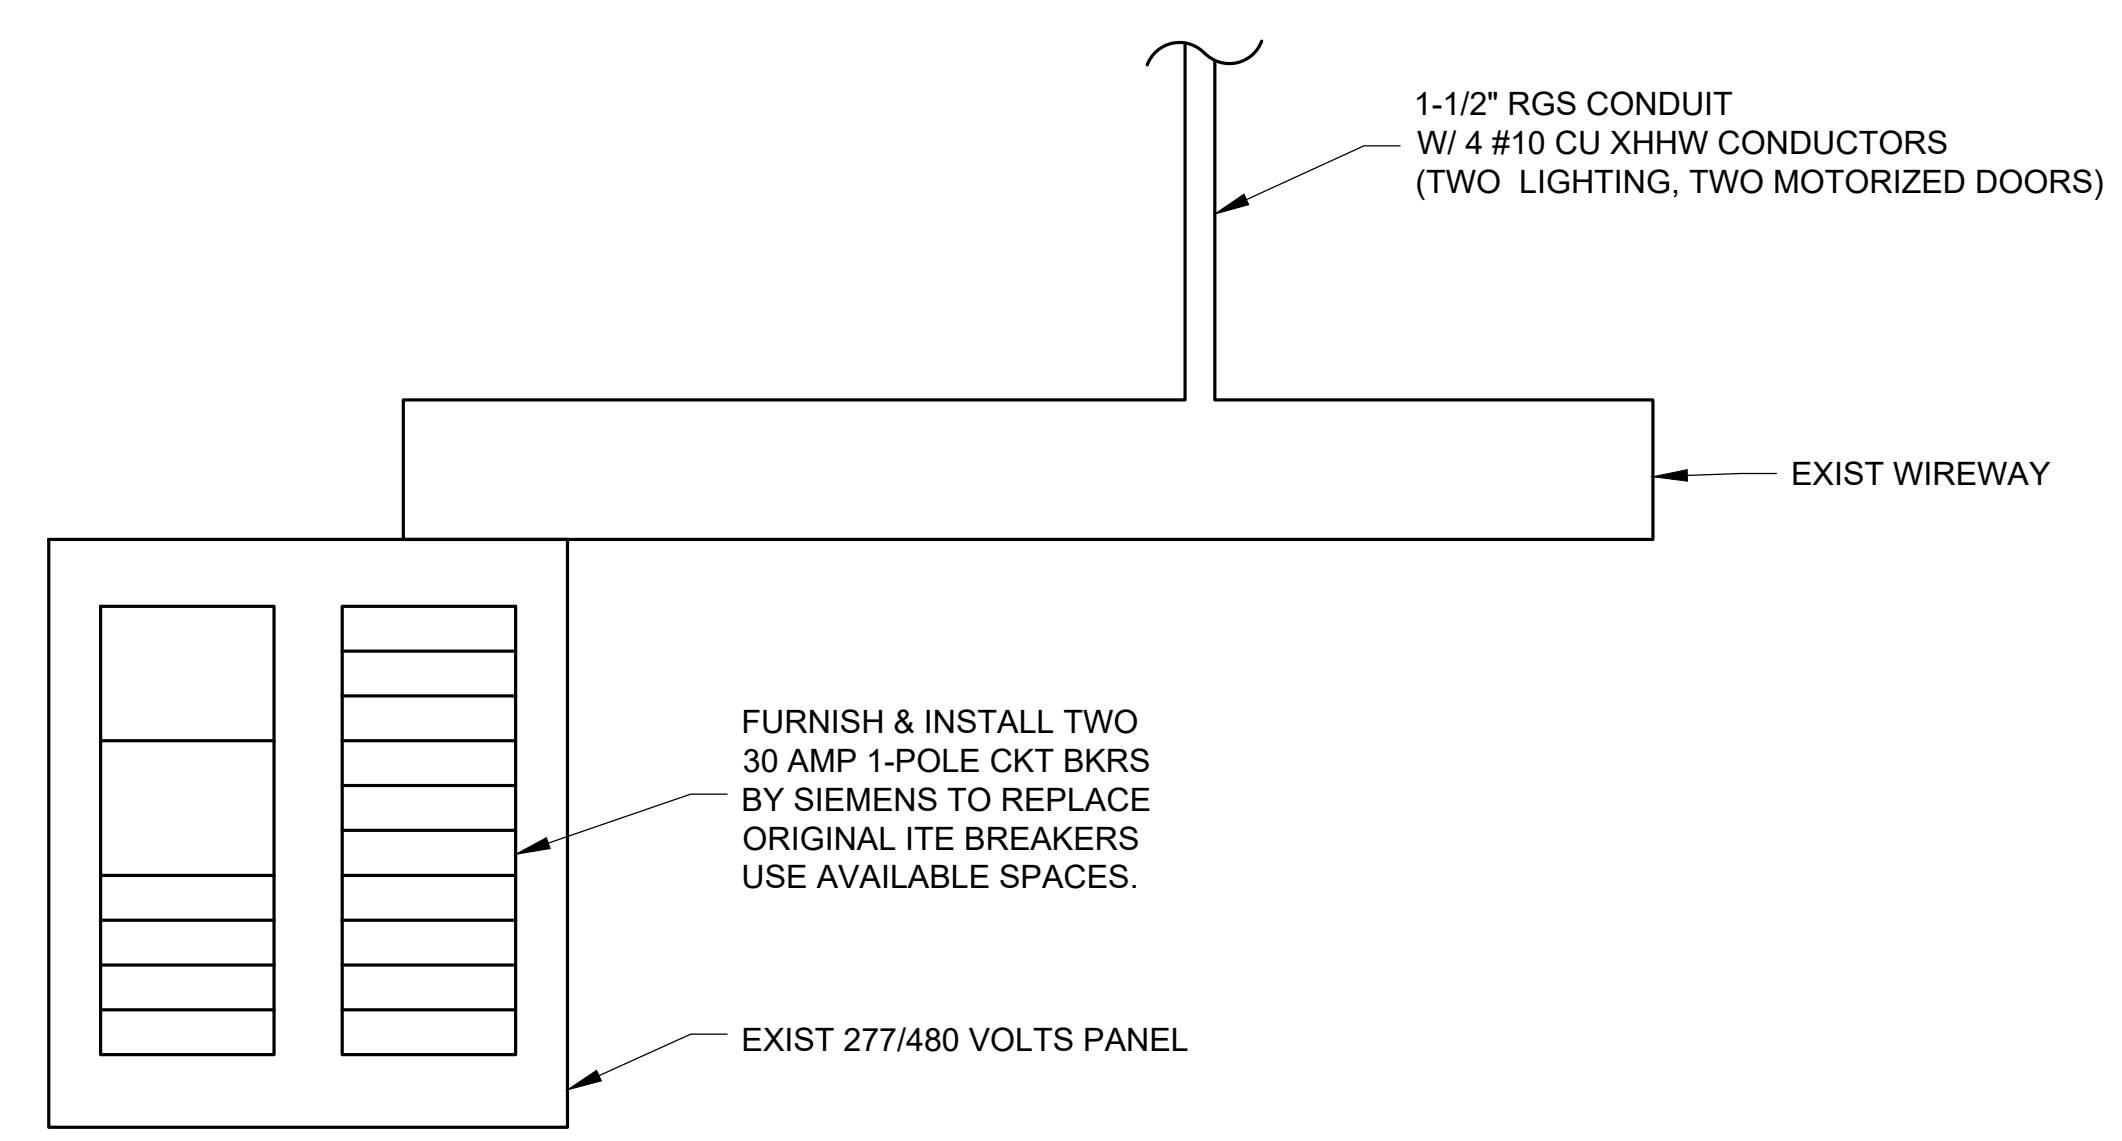


2 DETAIL "A"
 NOT TO SCALE

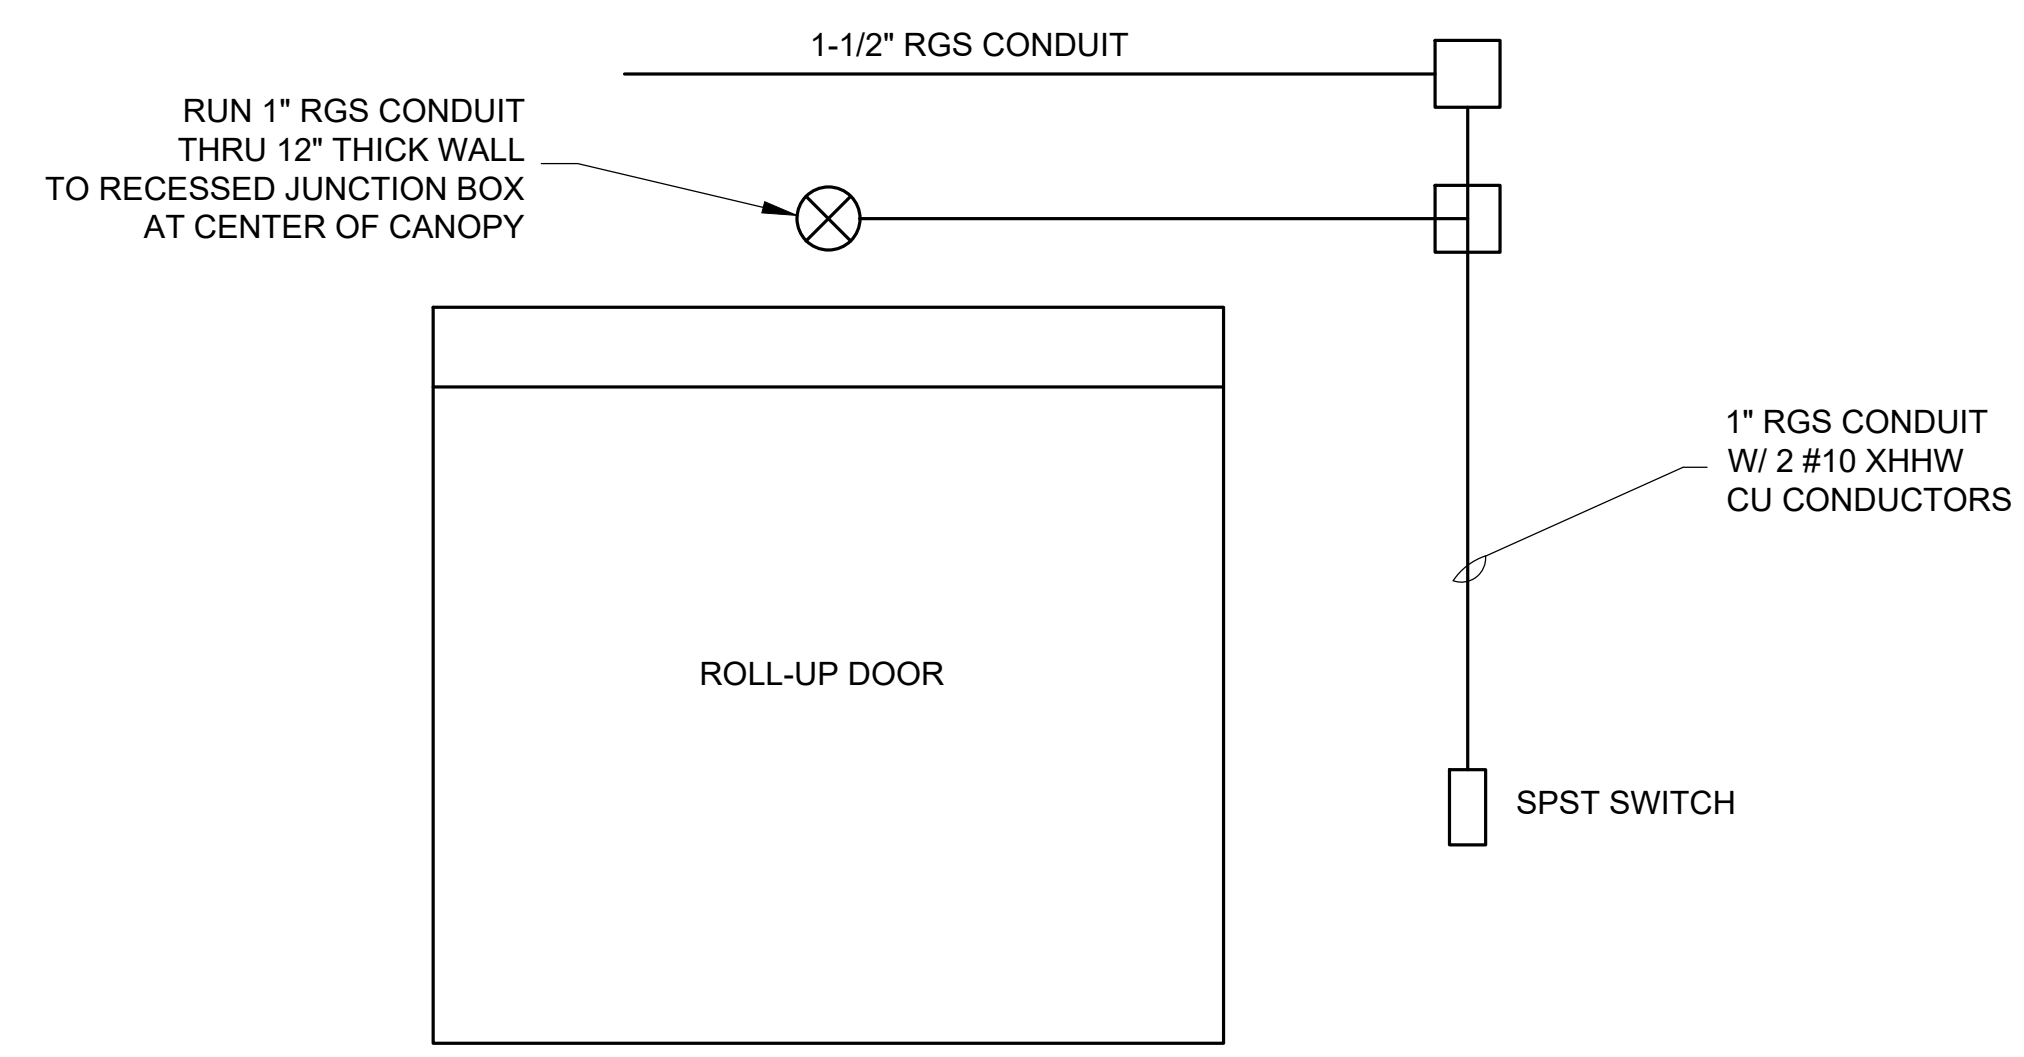

3 DETAIL "B"
 NOT TO SCALE

REV	BY	DATE	DESCRIPTION

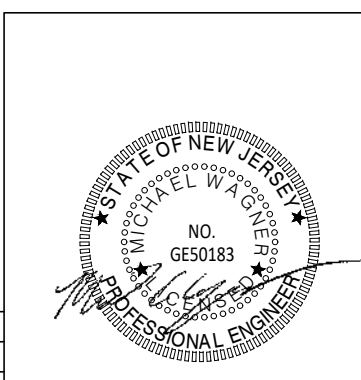






ISSUED FOR BID

URBAN ENGINEERS, INC.
 530 Walnut Street
 Philadelphia, PA 19106
 (215) 922-8080 Fax (215) 922-8082

LOCATION: **CAMDEN, NJ**

TITLE: **SJPC BALZANO MARINE TERMINAL RAIL INFRASTRUCTURE REHABILITATION CONDUIT SCHEMATIC & ELECTRICAL DETAILS**

DWN: FYC PROJ # 2021500064.000 DRAWING NUMBER: **E-001**
 CRK: JJO DATE: 06/24/2022

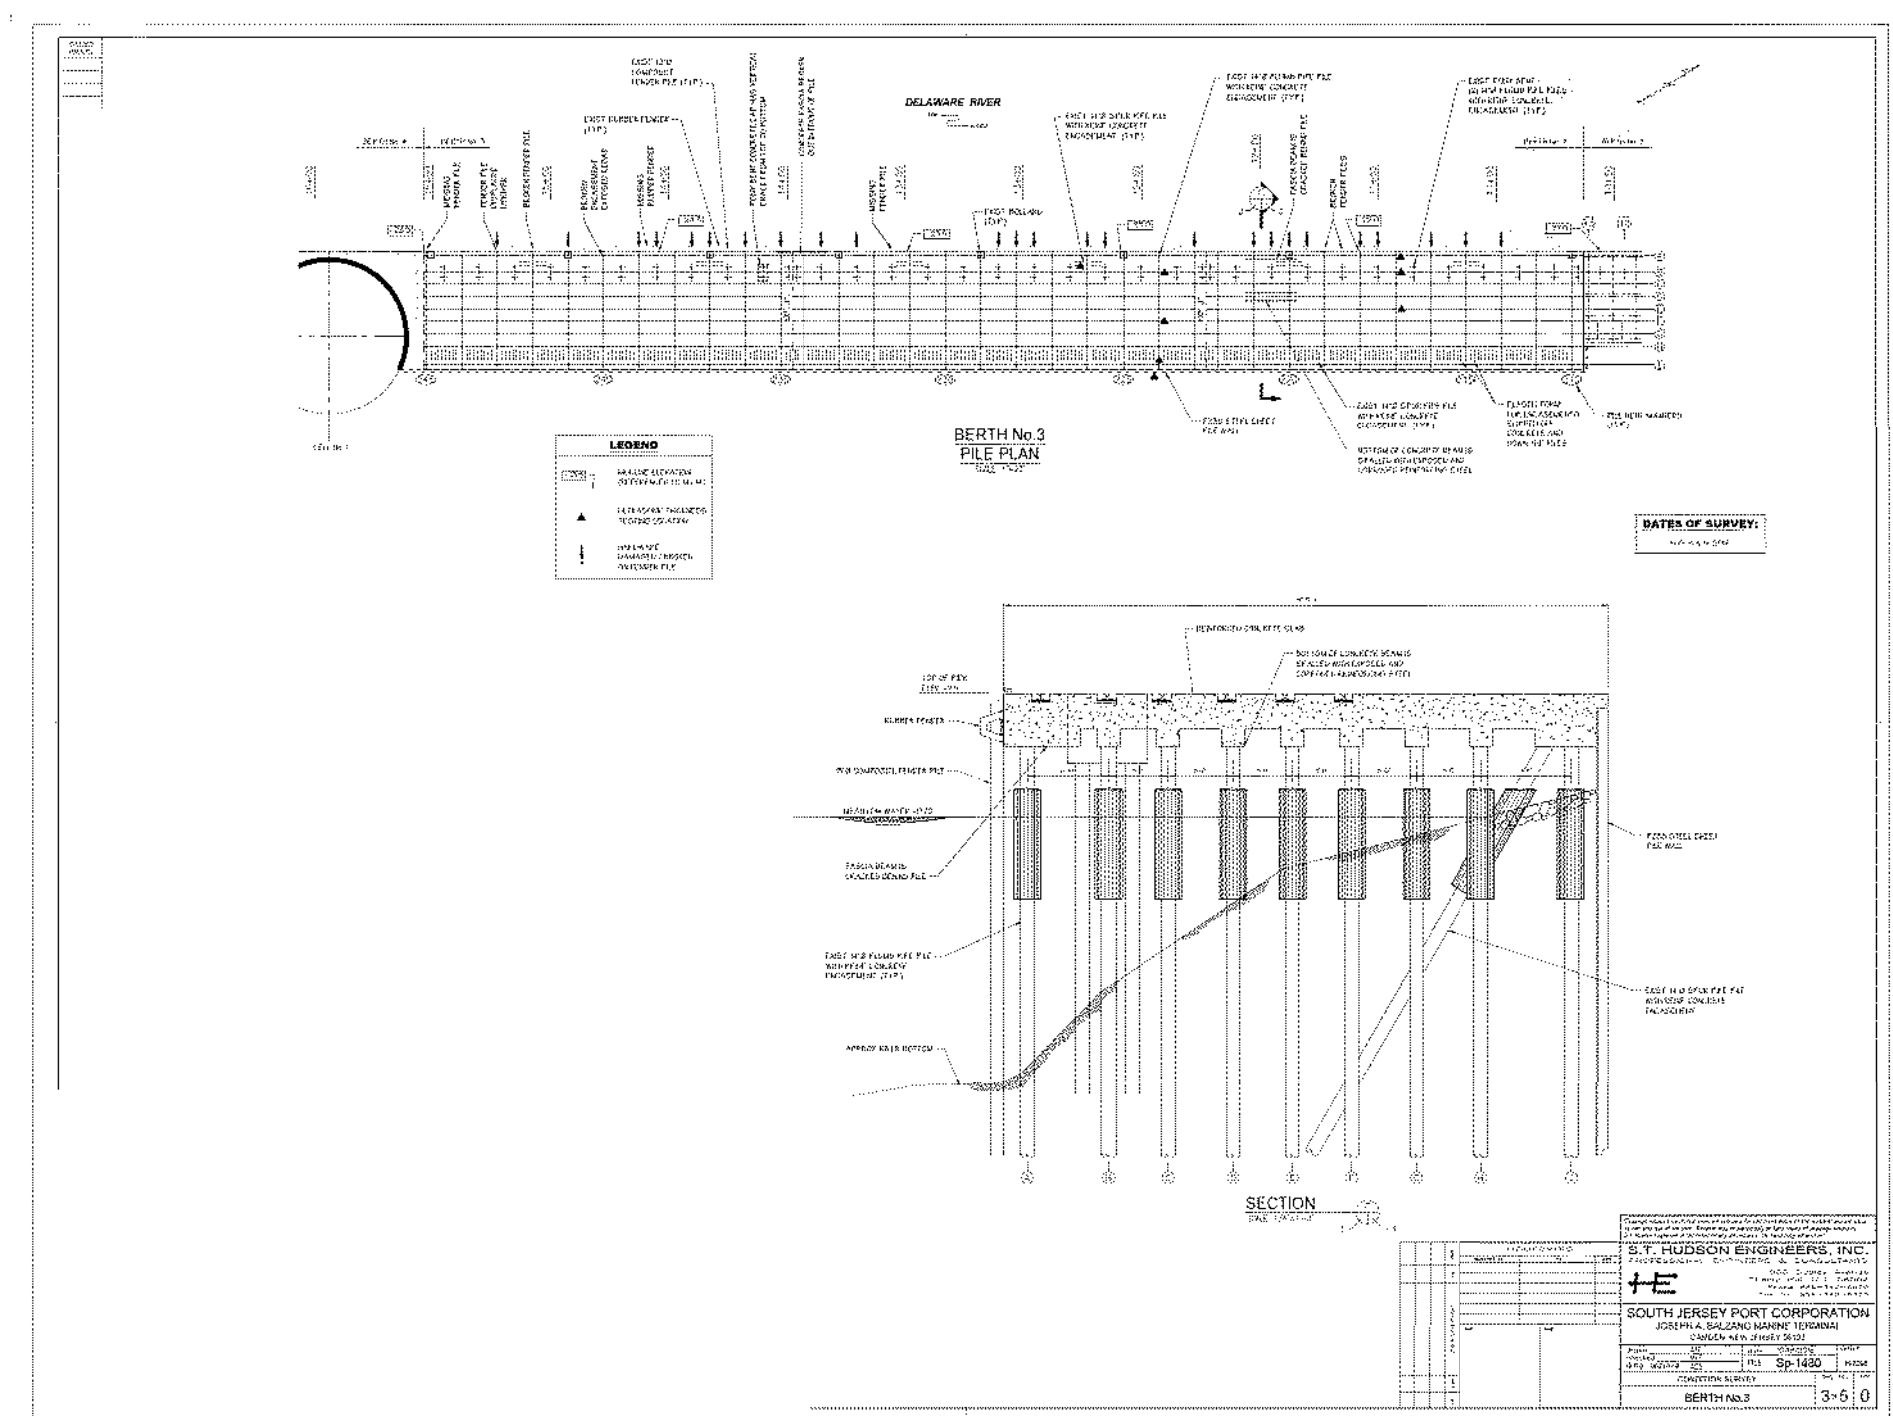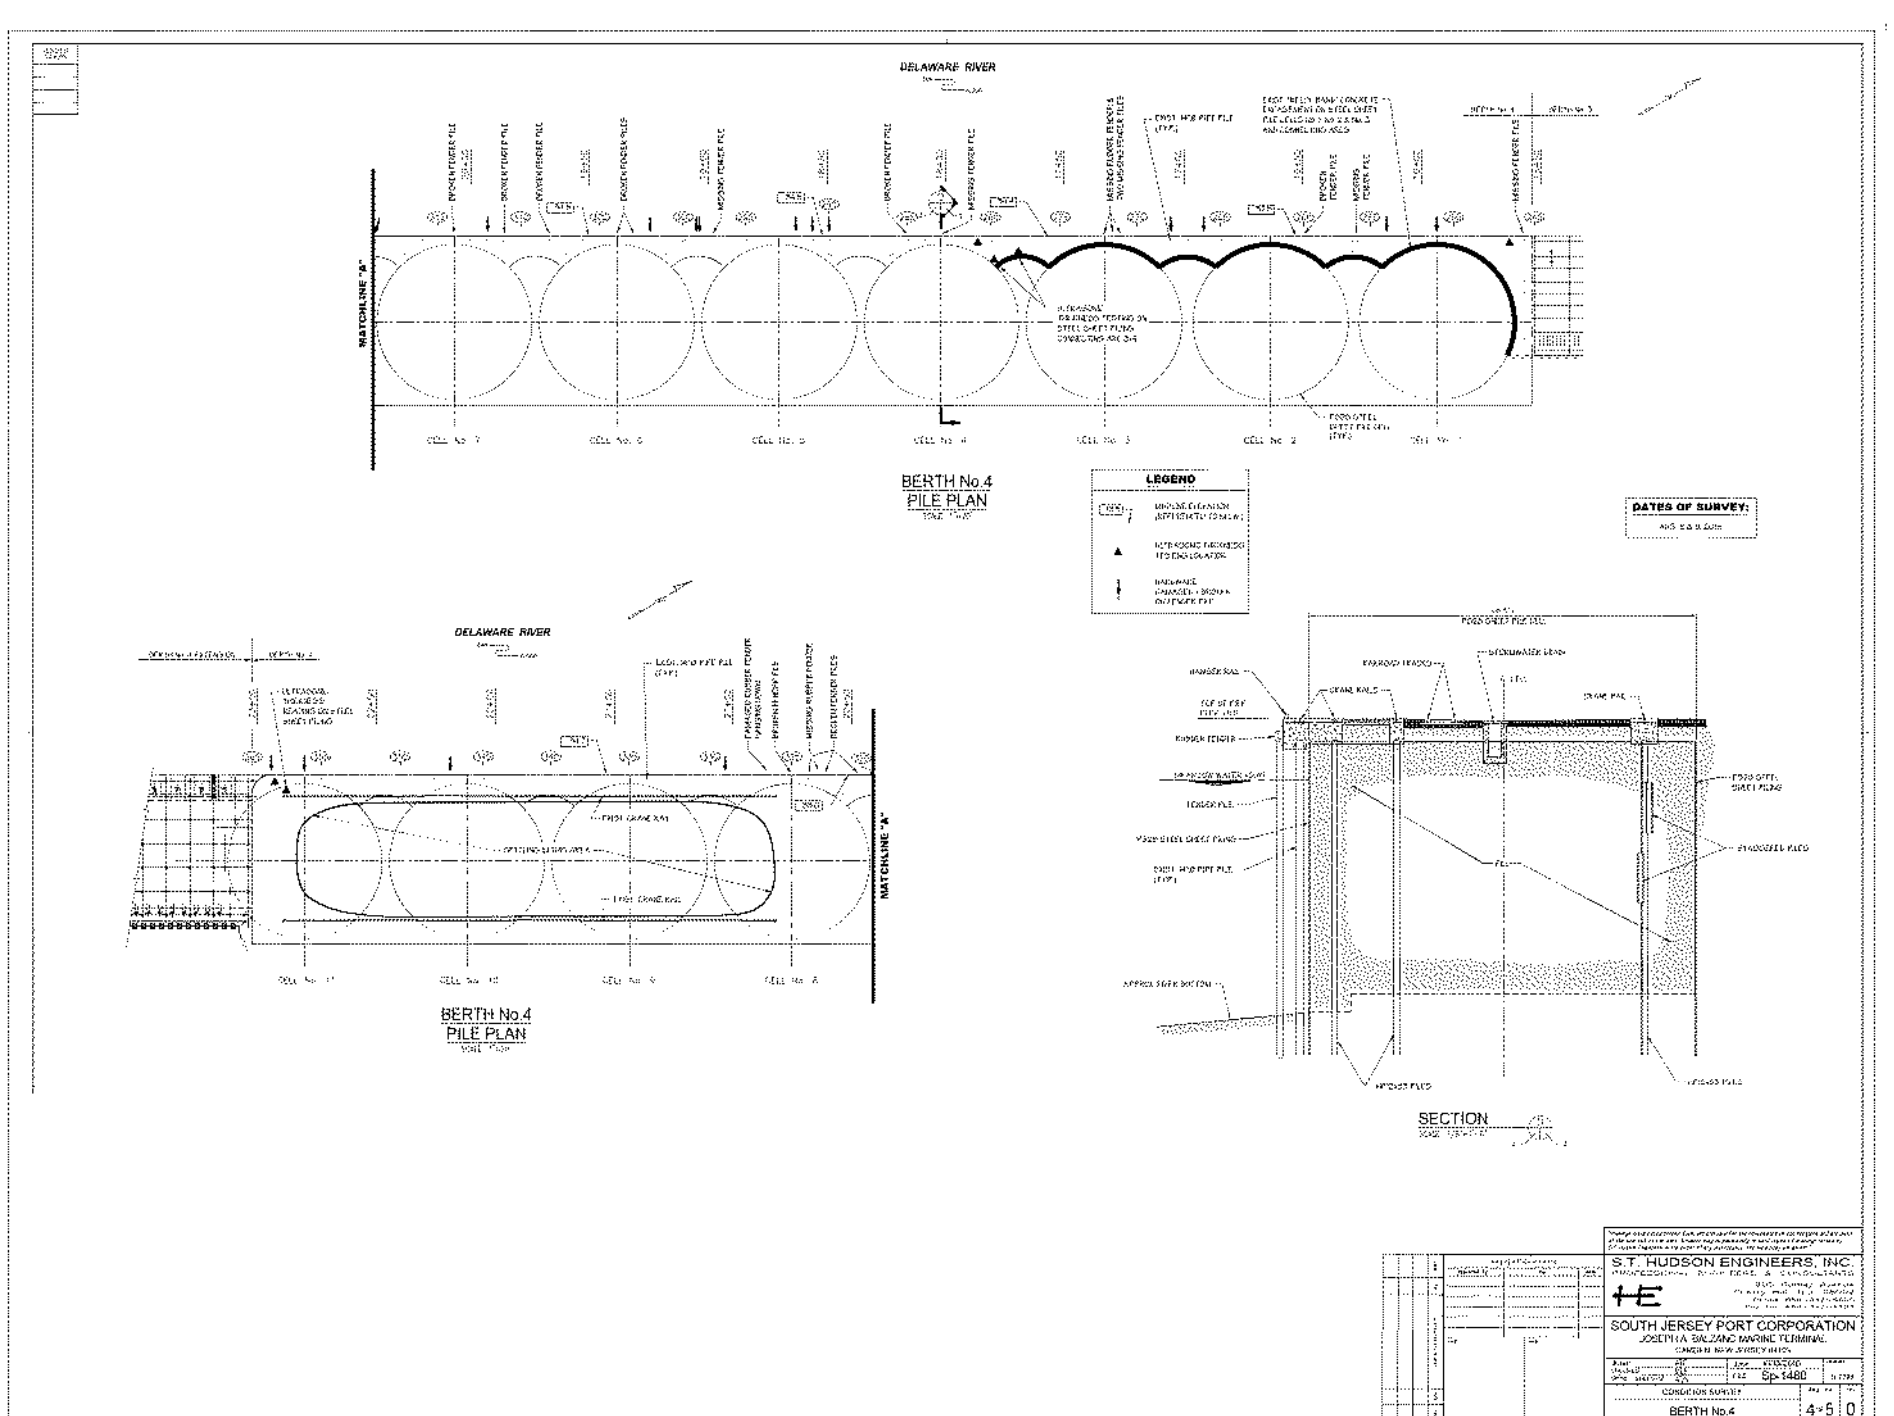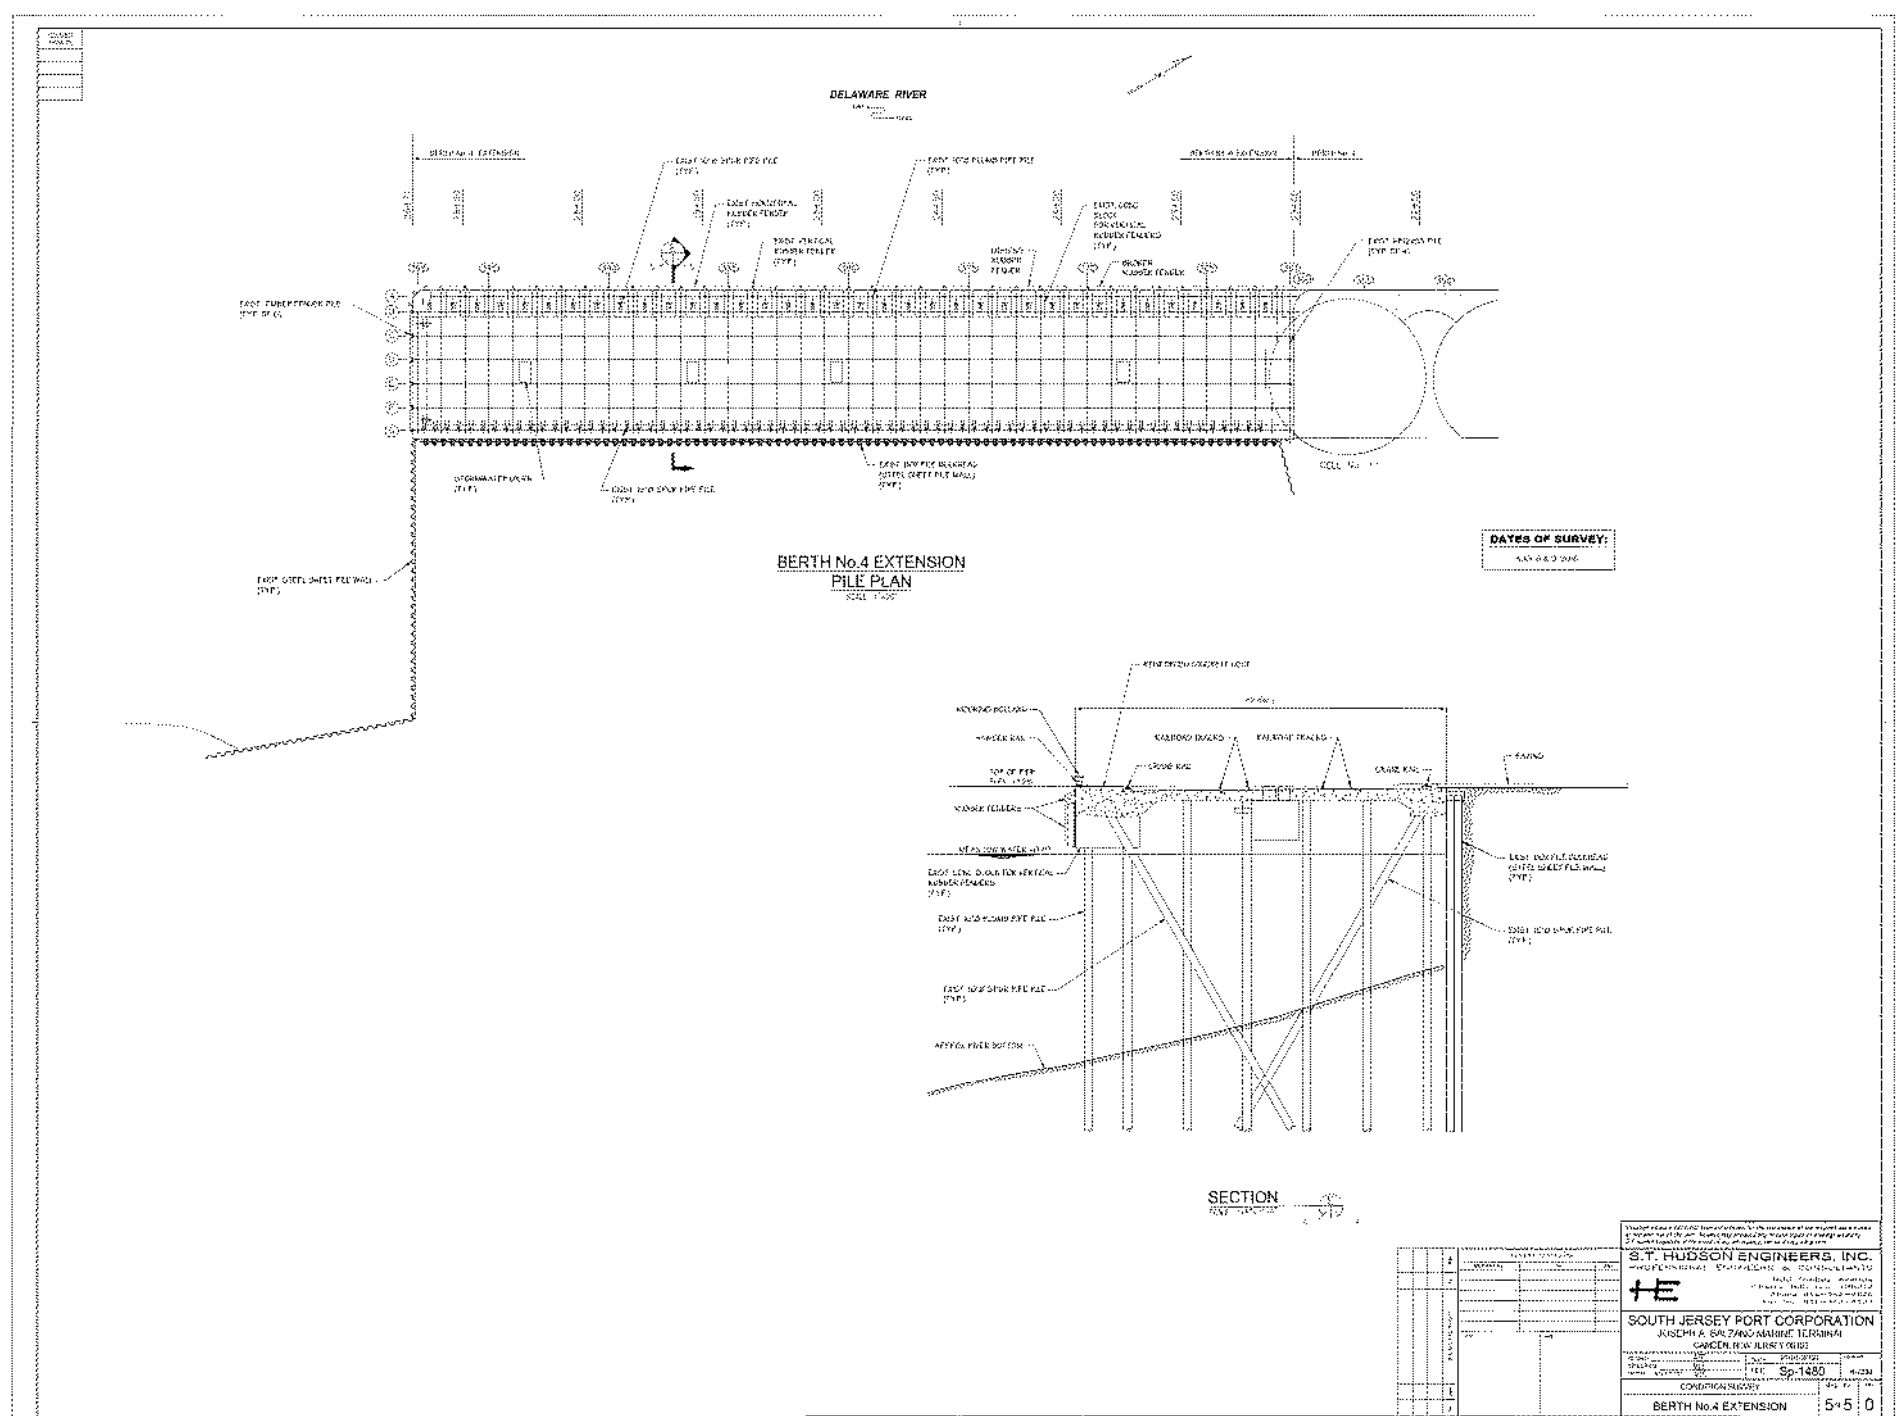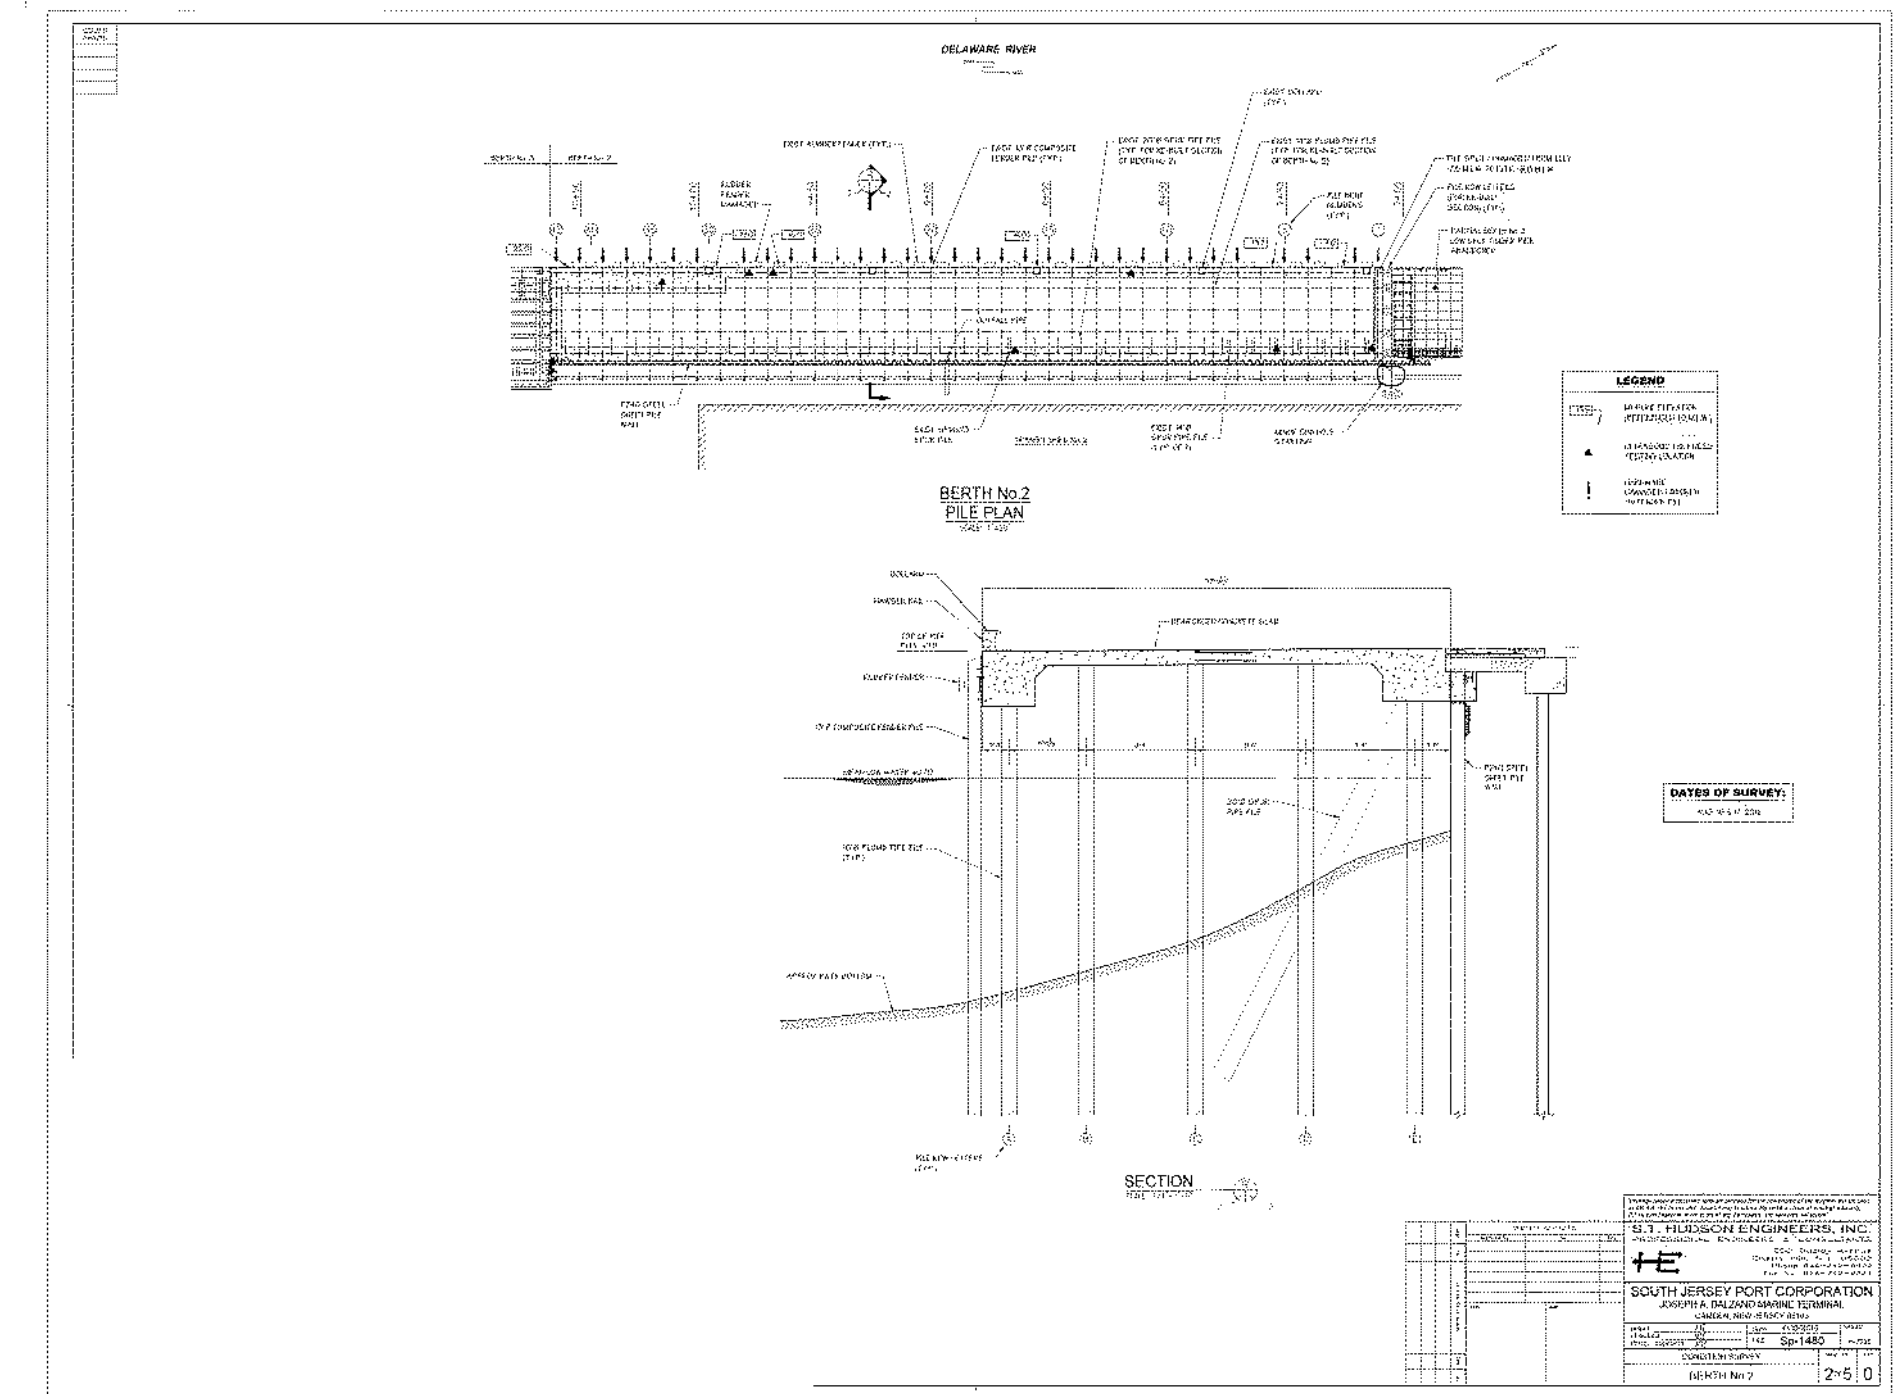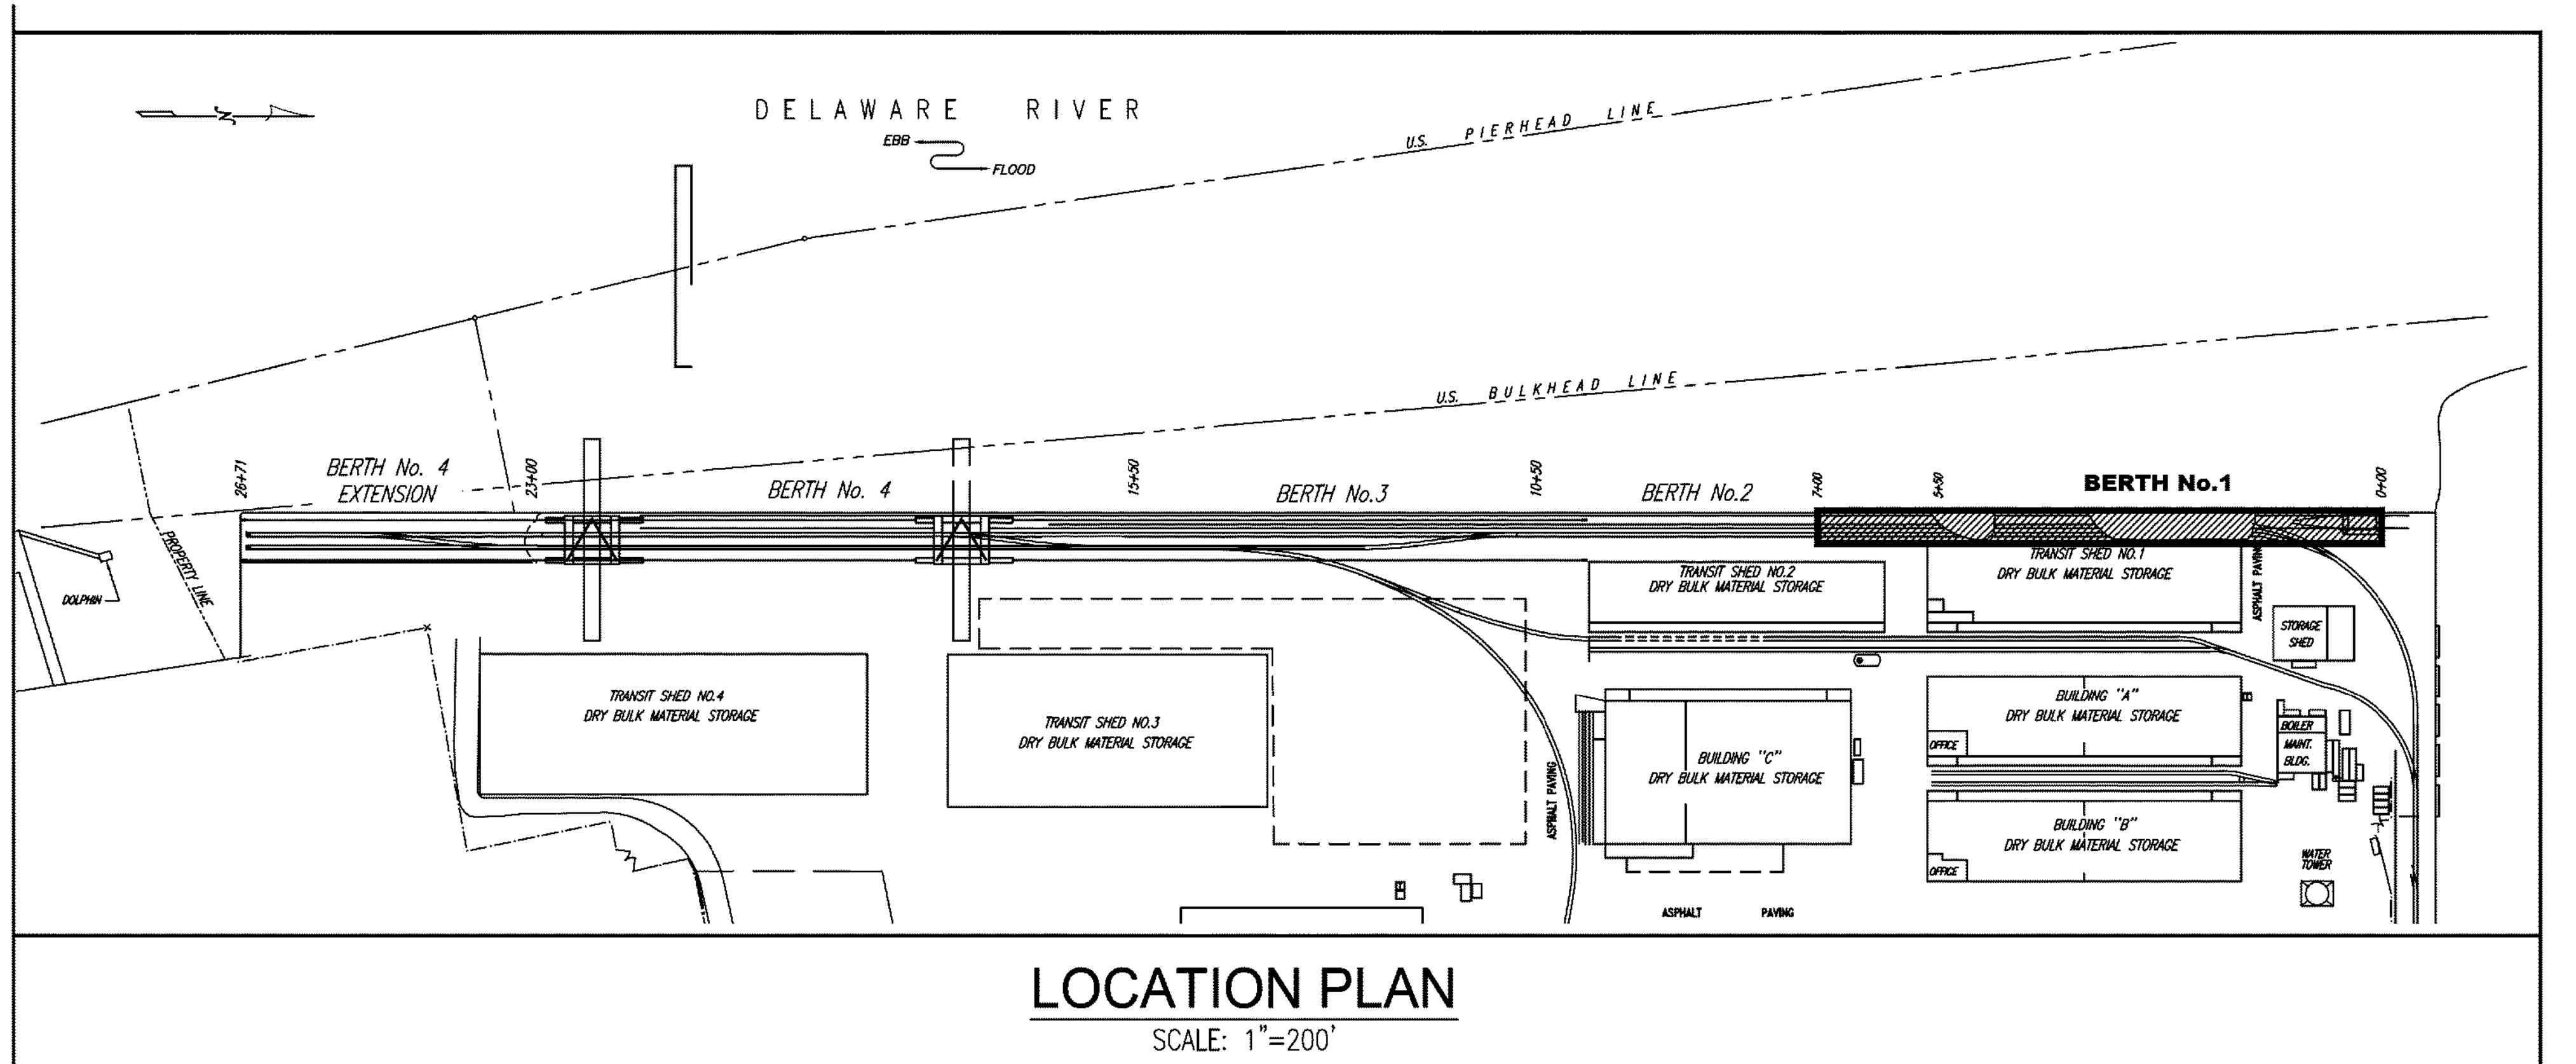

ISSUED FOR BID

URBAN ENGINEERS, INC.
 530 Walnut Street
 Philadelphia, PA 19106
 (215) 922-8080 Fax (215) 922-8082

URBAN ENGINEERS

LOCATION: **CAMDEN, N.J.**

TITLE: **S.J.P.C. BALZANO MARINE TERMINAL RAIL INFRASTRUCTURE REHABILITATION EXISTING BERTH NUMBERING & CROSS SECTIONS RECORD DRAWINGS**

NO. 650183


DATE: 11/11/11

PROJ. # FST




DRAWING NUMBER: **EX-0**

REV	BY	DATE	DESCRIPTION

ISSUE PRINTS

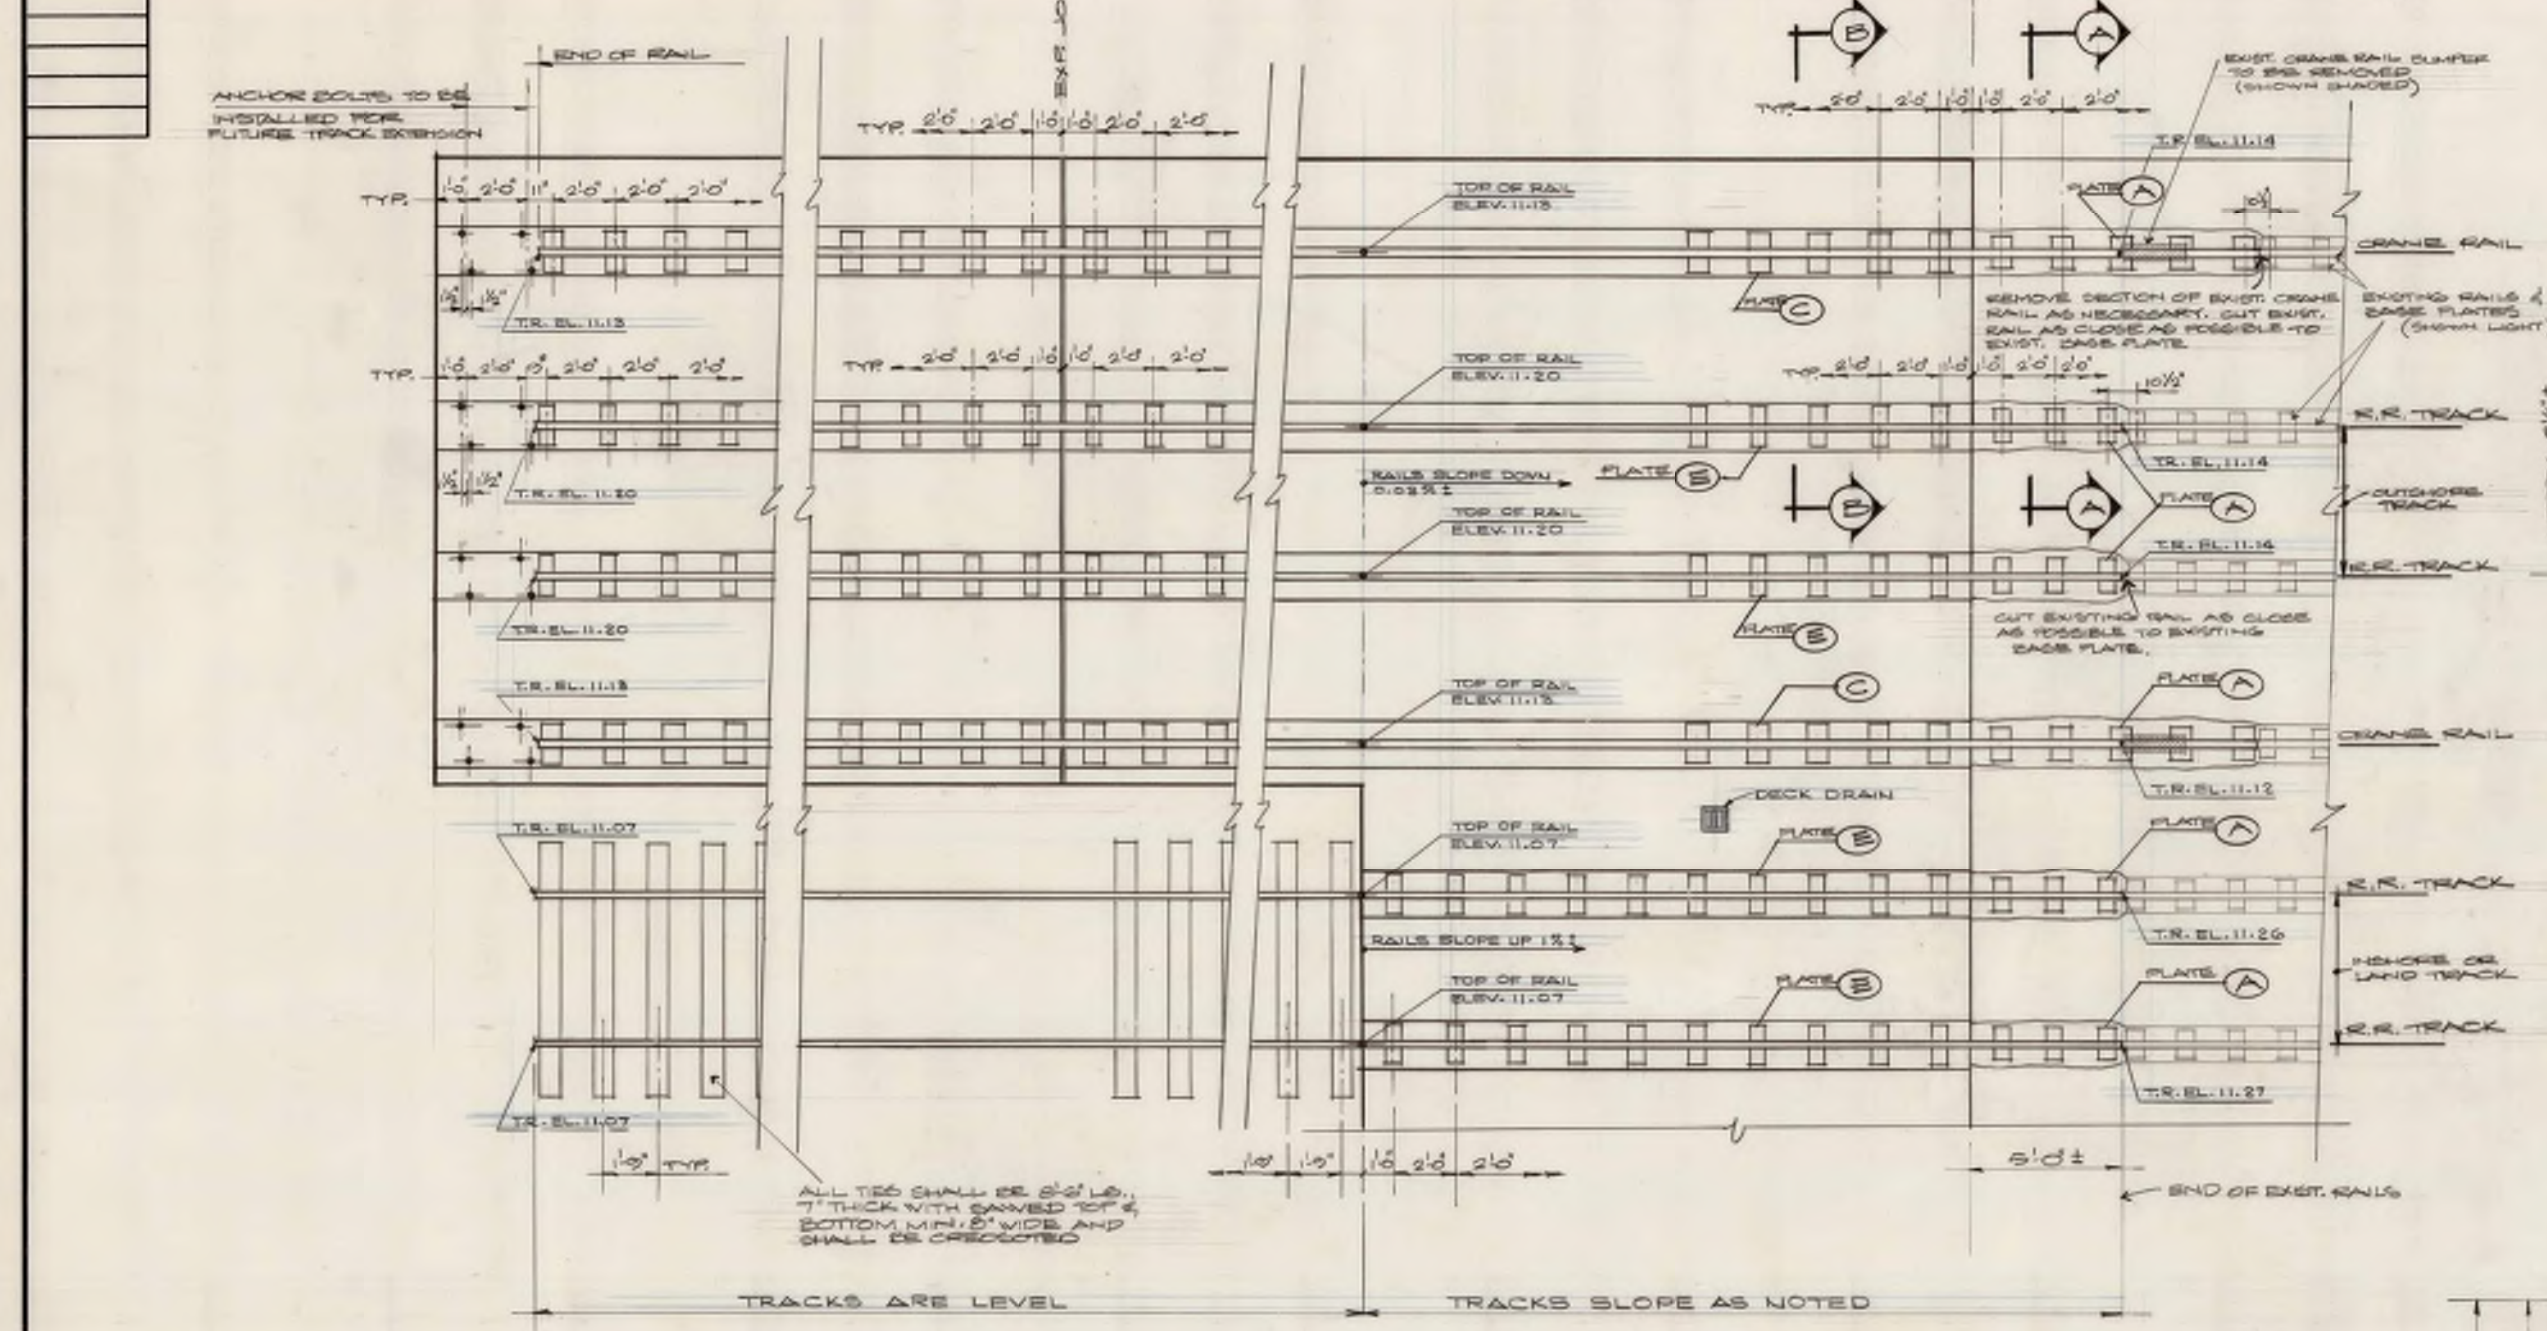

PLAN SCALE: 1/4" = 1'-0"

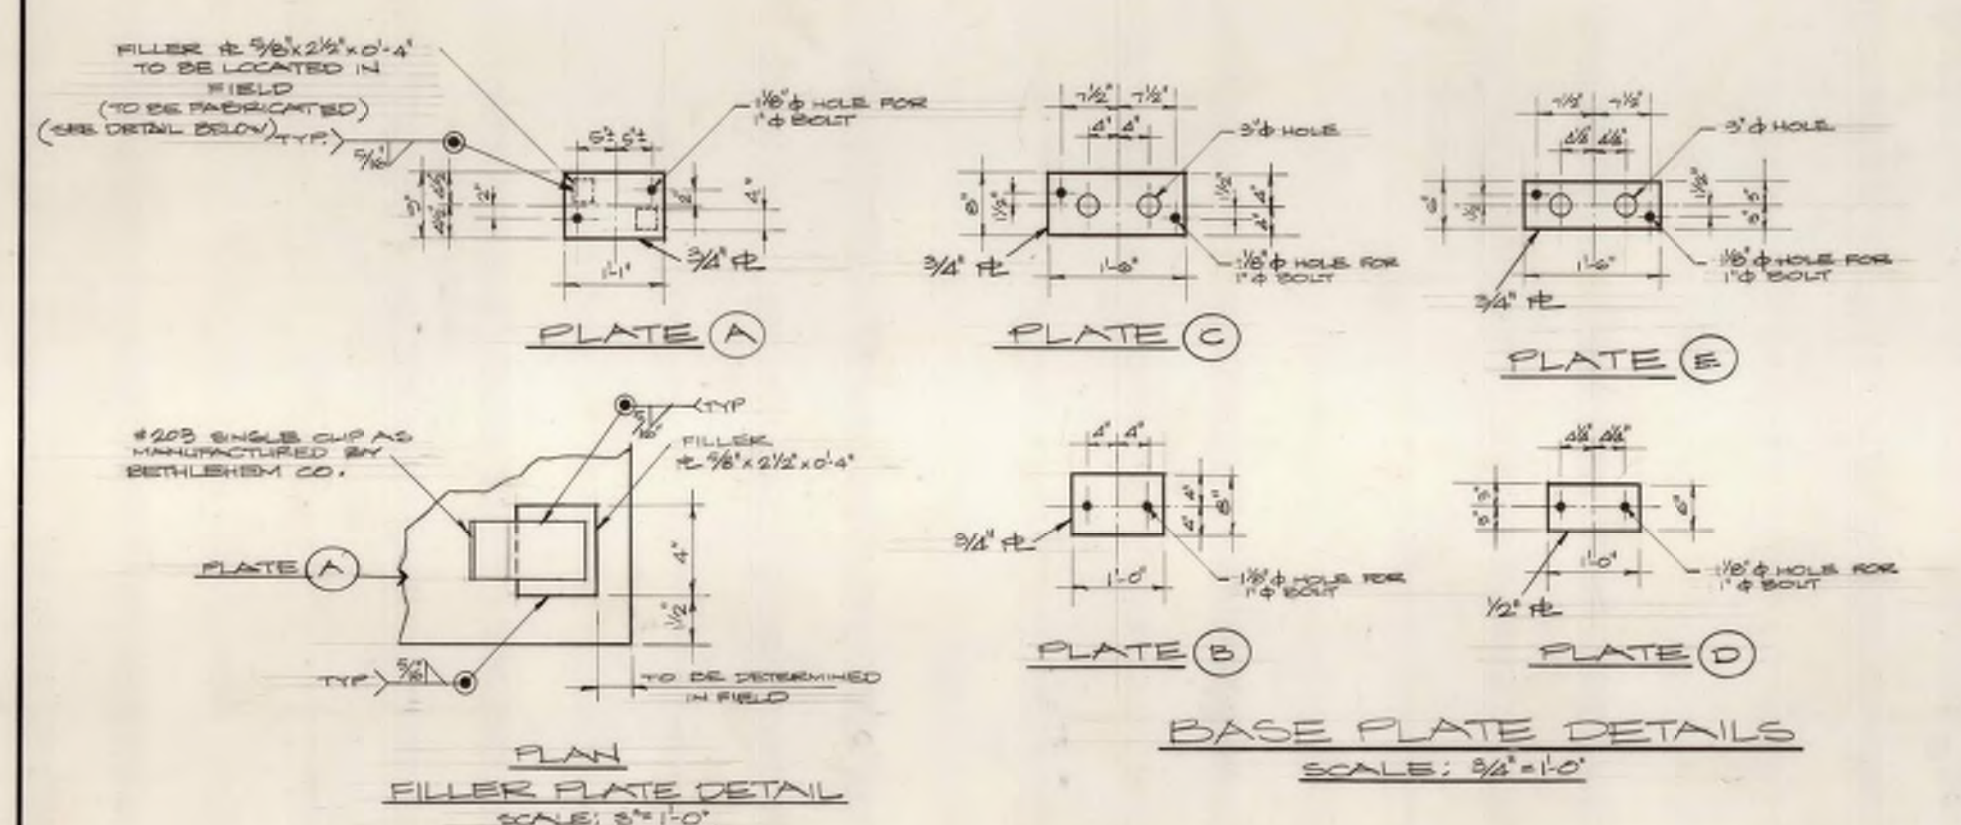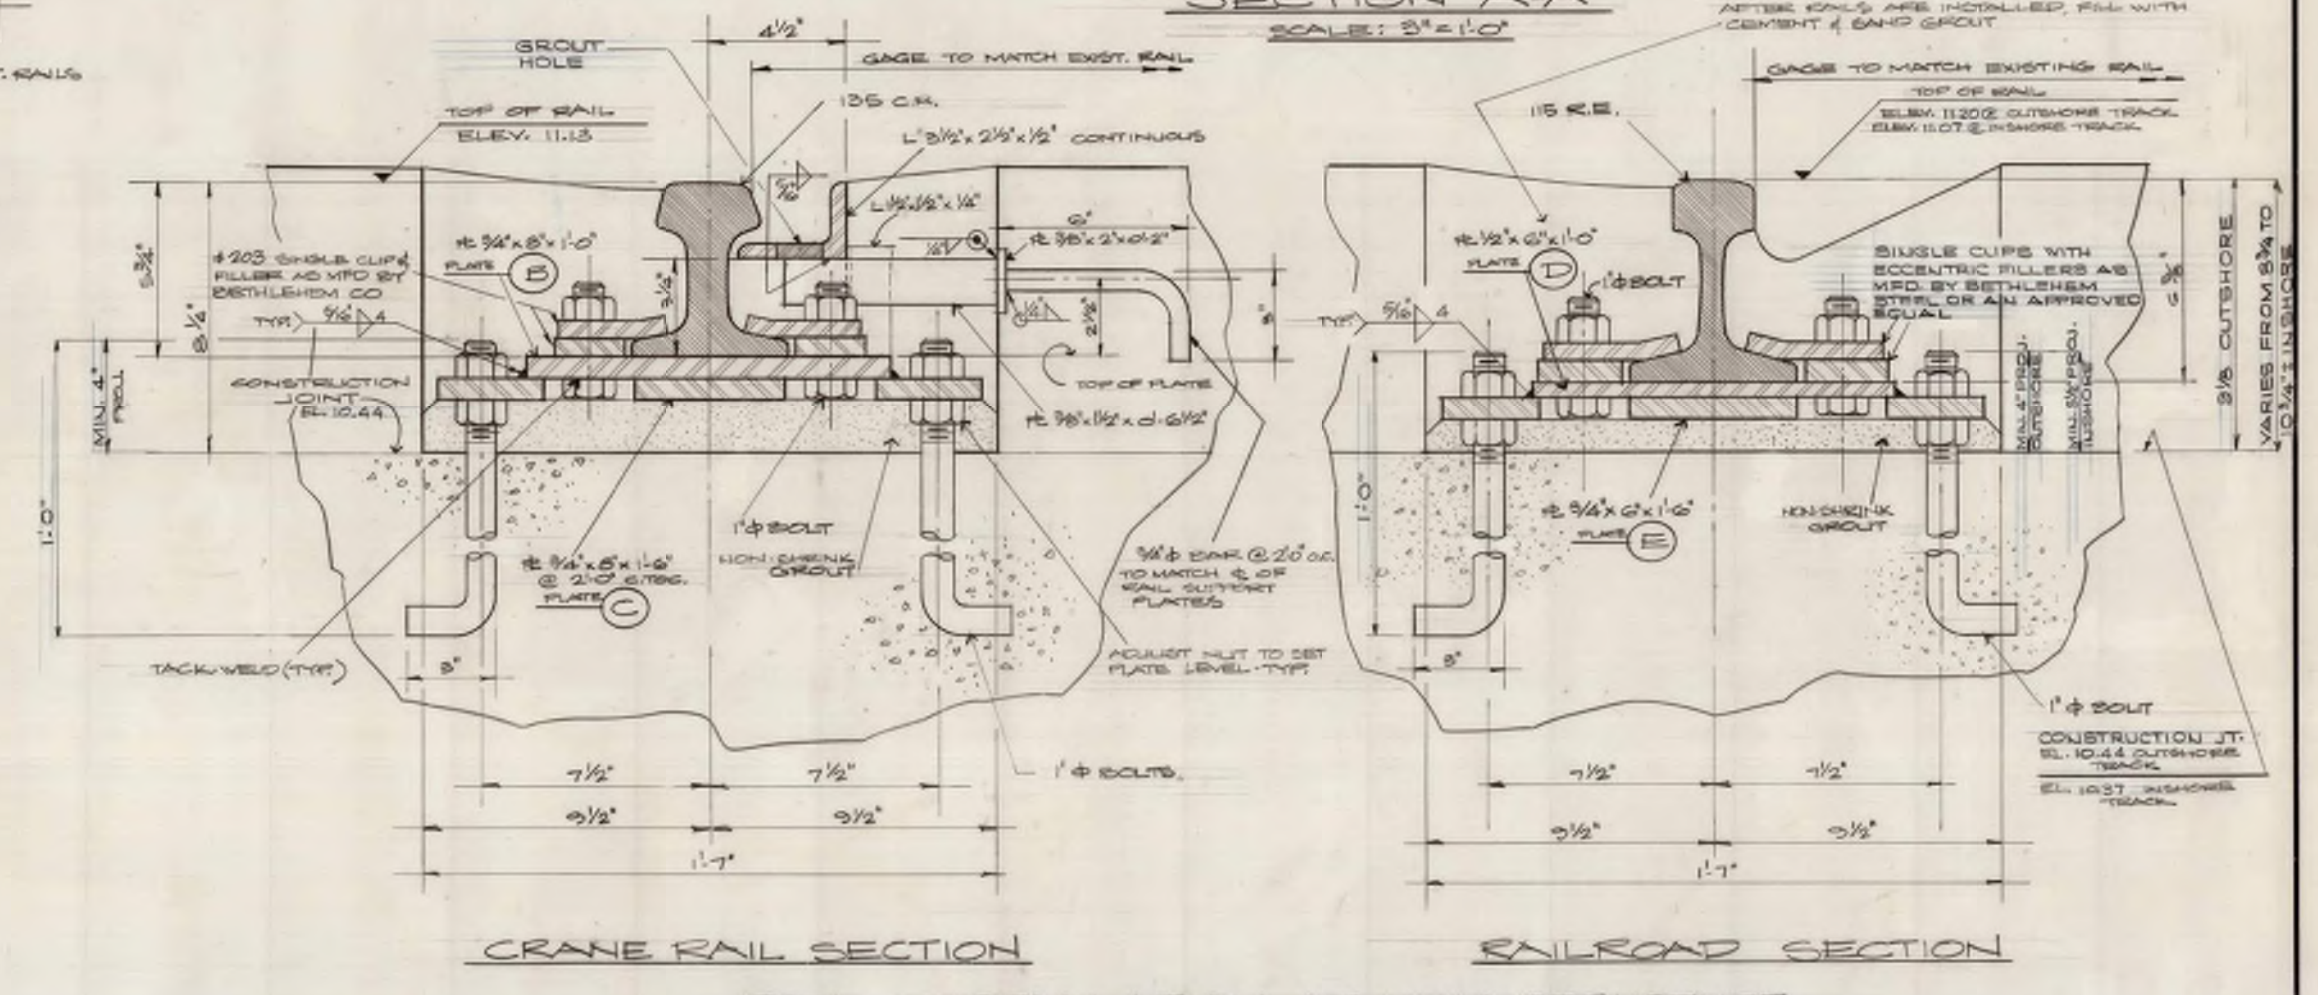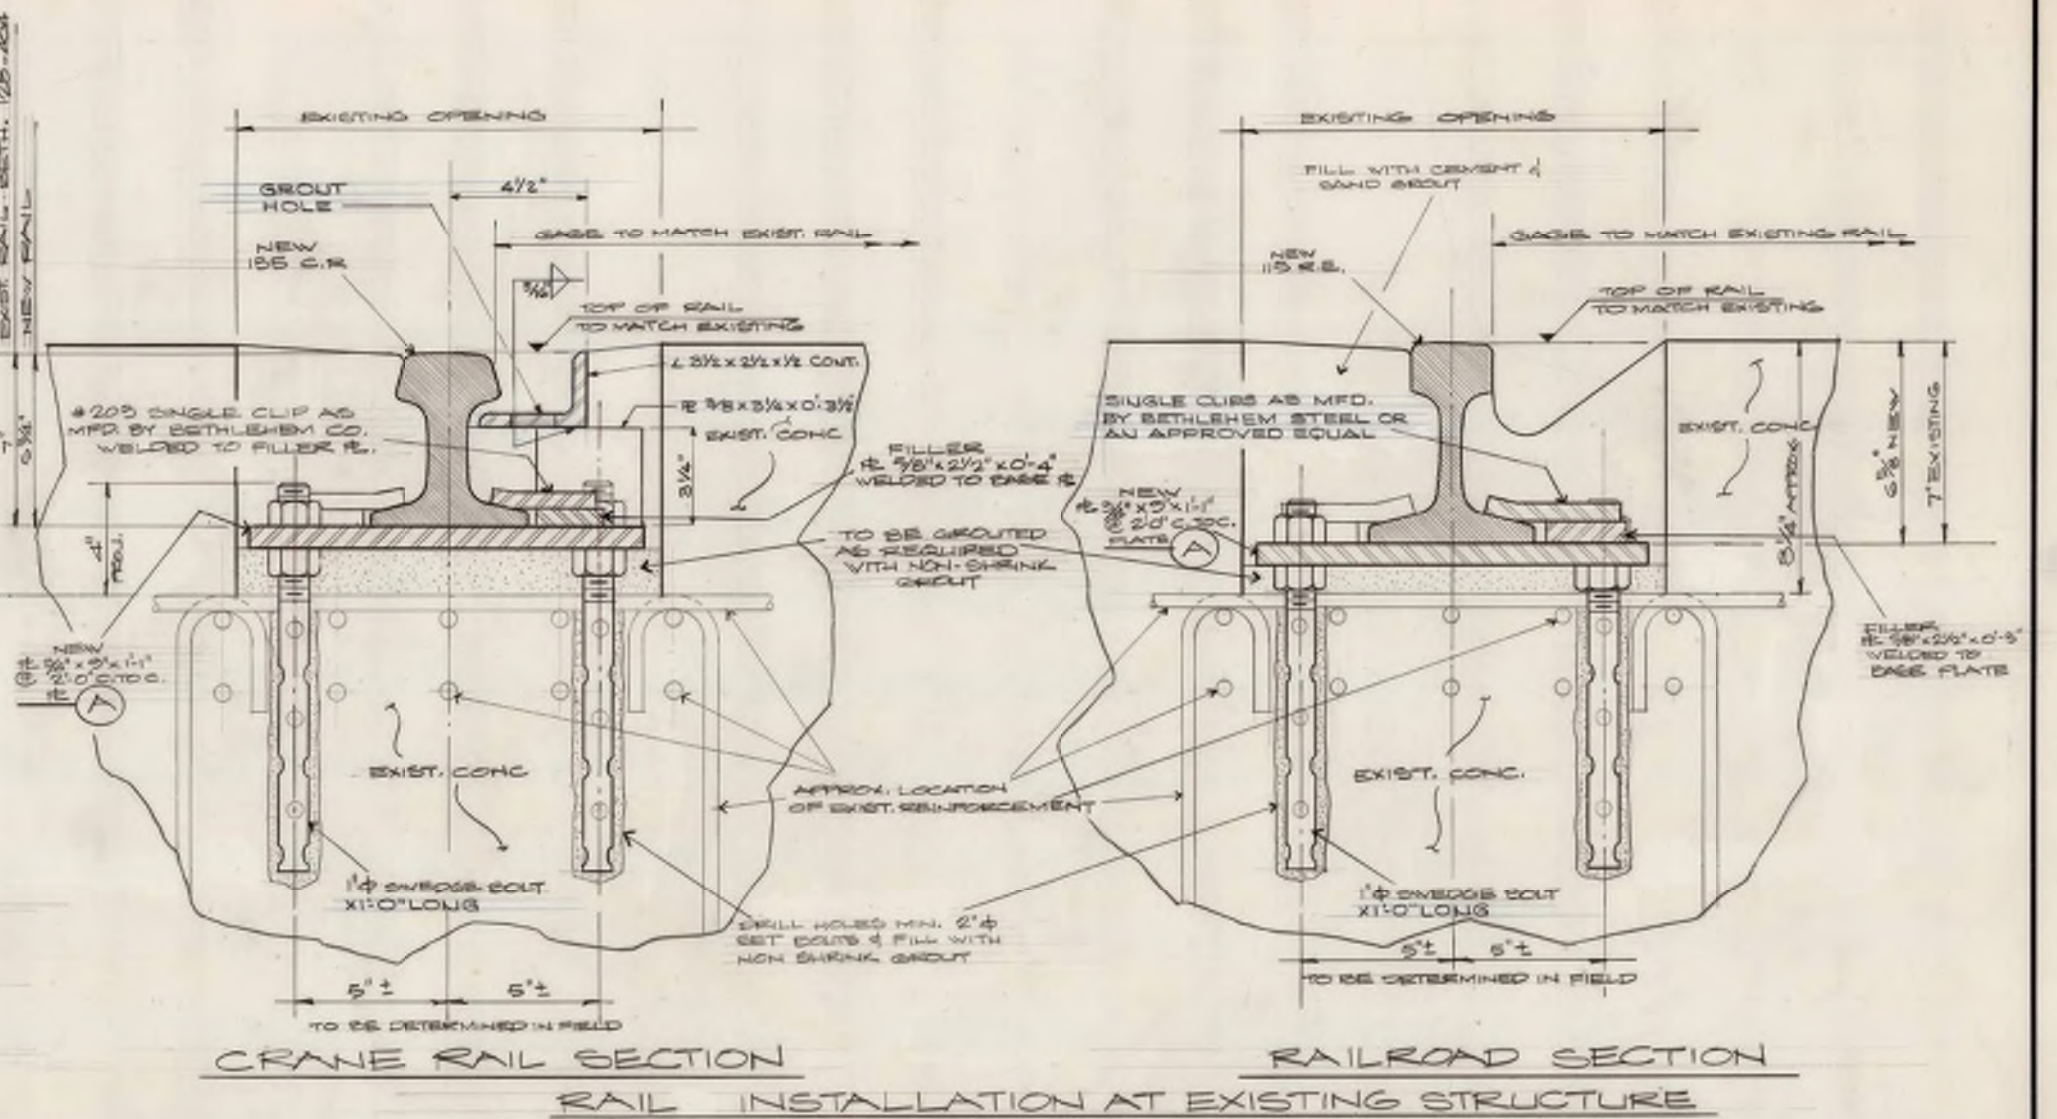

APPROVALS		
APPROVED BY	FOR	DATE
	PROJECT	5-24-75

S. T. HUDSON ENGINEERS, INC.
PROFESSIONAL ENGINEERS & CONSULTANTS
211 South Broad Street
Philadelphia, Pa. 19107

SOUTH JERSEY PORT CORPORATION
BECKETT STREET TERMINAL
CAMDEN, N. J.

drawn by HICKMAN date MARCH 23, 1975 contract
checked by J. V. FILE Sp: 1075 H: C80
drftg. approval HICKMAN

BERTH NO. 4 dwg. no. rev.
RAIL INSTALLATION DETAILS S-6 0


ISSUED FOR BID

URBAN ENGINEERS, INC.
530 Walnut Street
Philadelphia, PA. 19106
(215) 922-8080 Fax (215) 922-8082


LOCATION: CAMDEN, N.J.

TITLE: S.J.P.C. BALZANO MARINE TERMINAL RAIL INFRASTRUCTURE REHABILITATION BERTH 3 - BERTH 4 RAIL CONNECTIONS CONSTRUCTION RECORD DRAWINGS


DWN: FST PROJ: F DRAWING NUMBER:
CRK: DATE: EX-1

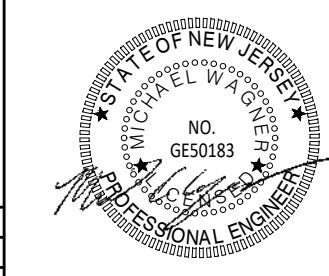


REV	BY	DATE	DESCRIPTION

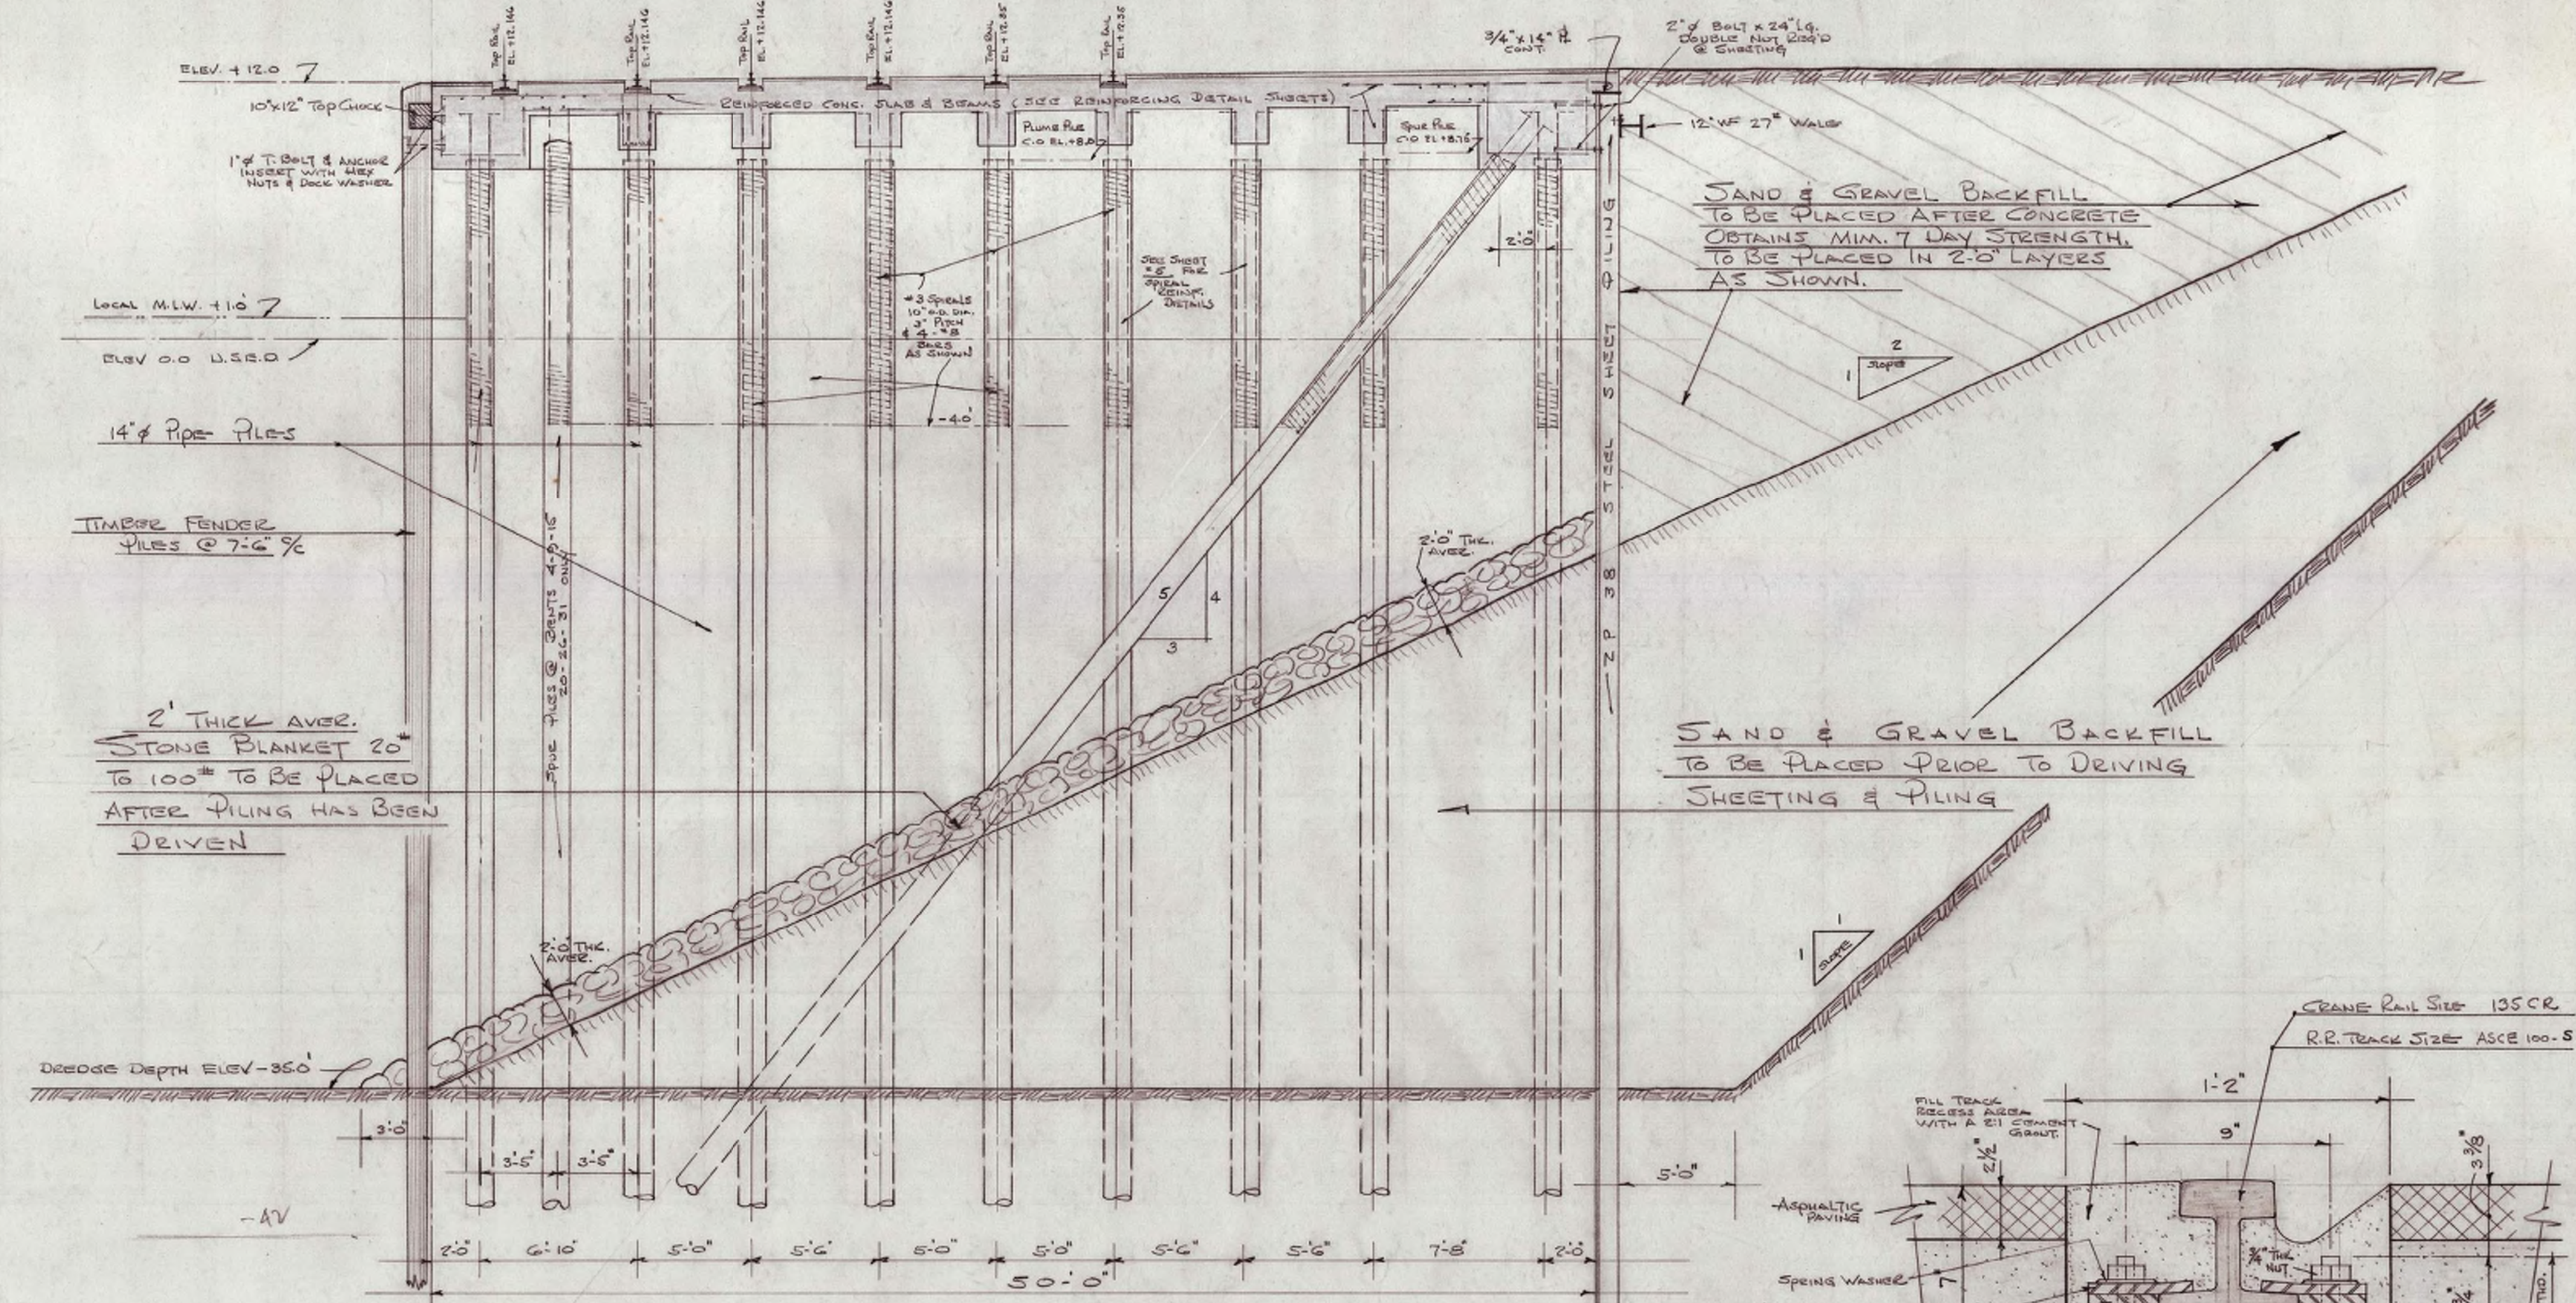

MAIN BENT SECTION
SCALE 1/4" = 1'-0"
ALL PILING & Spue PILES TO BE 14" PIPE PILES

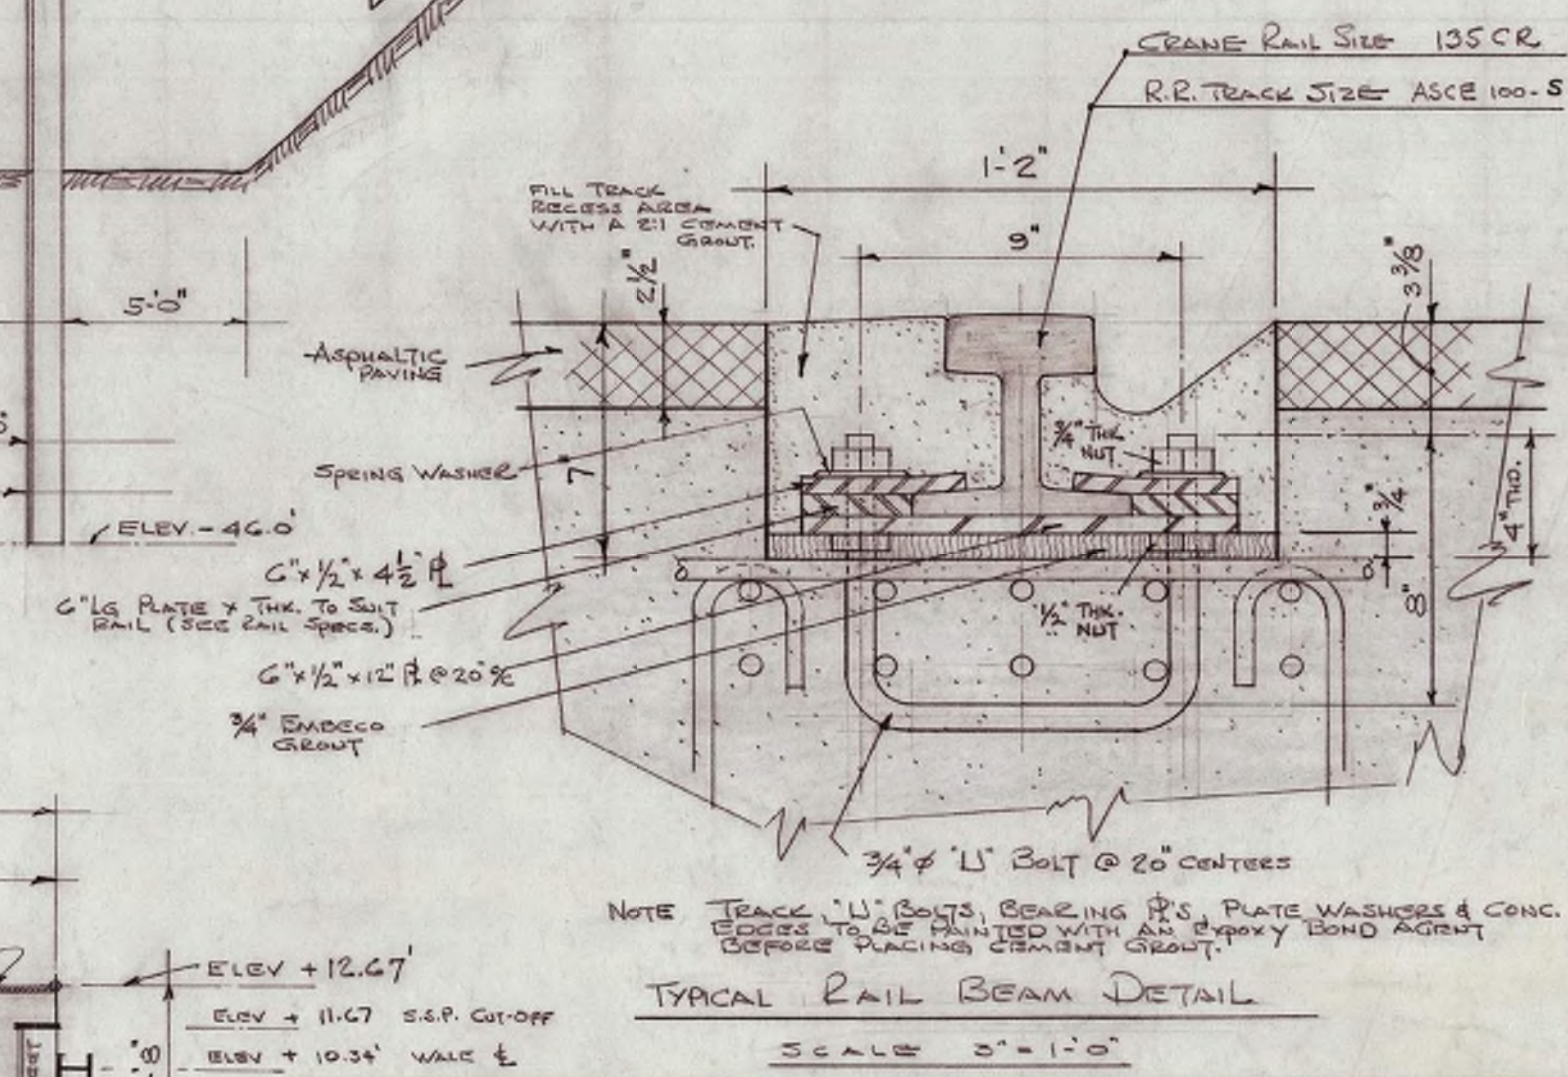

TYPICAL RAIL BEAM DETAIL
SCALE 3" = 1'-0"

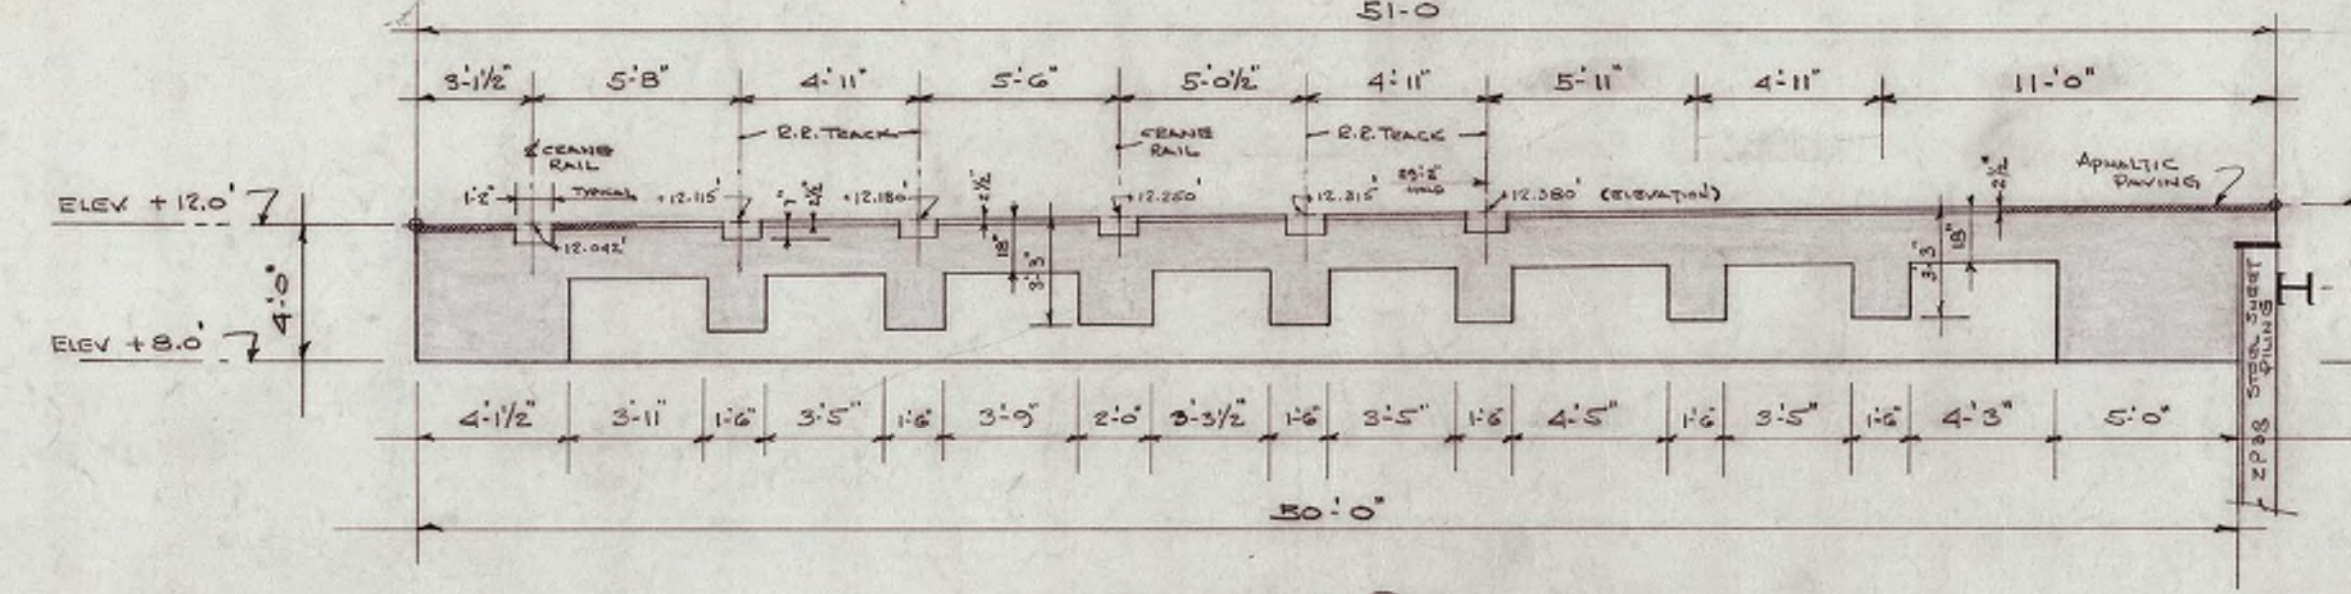

CONCRETE BEAM LAYOUT
SCALE 1/4" = 1'-0"

J. E. BRENNEMAN CO.
CONTRACTING ENGINEERS
121 SO. BROAD STREET
PHILADELPHIA, PENNA.

SOUTH JERSEY PORT COMMISSION
CAMDEN MARINE TERMINAL
RECENT STN. CAMDEN, N.J.

DRAWN BY P. FERMIER DATE JAN. 31, 1966
APPROVED N. D. BELL FILE S-1095
CHECKED [Signature]

TYPICAL PIER SECTION SHEET NO. 3 OF 6



ISSUED FOR BID

URBAN ENGINEERS, INC.
530 Walnut Street
Philadelphia, PA. 19106
(215) 922-8080 Fax (215) 922-8082


LOCATION: **CAMDEN, N.J.**

TITLE: **S.J.P.C. BALZANO MARINE TERMINAL RAIL INFRASTRUCTURE REHABILITATION EXISTING BERTH 3 SECTION & RAIL DETAILS CONSTRUCTION RECORD DRAWINGS**

DATE: _____ DRAWING NUMBER: **EX-2**

REV.	BY	DATE	DESCRIPTION


ISSUED	
PRINTED	

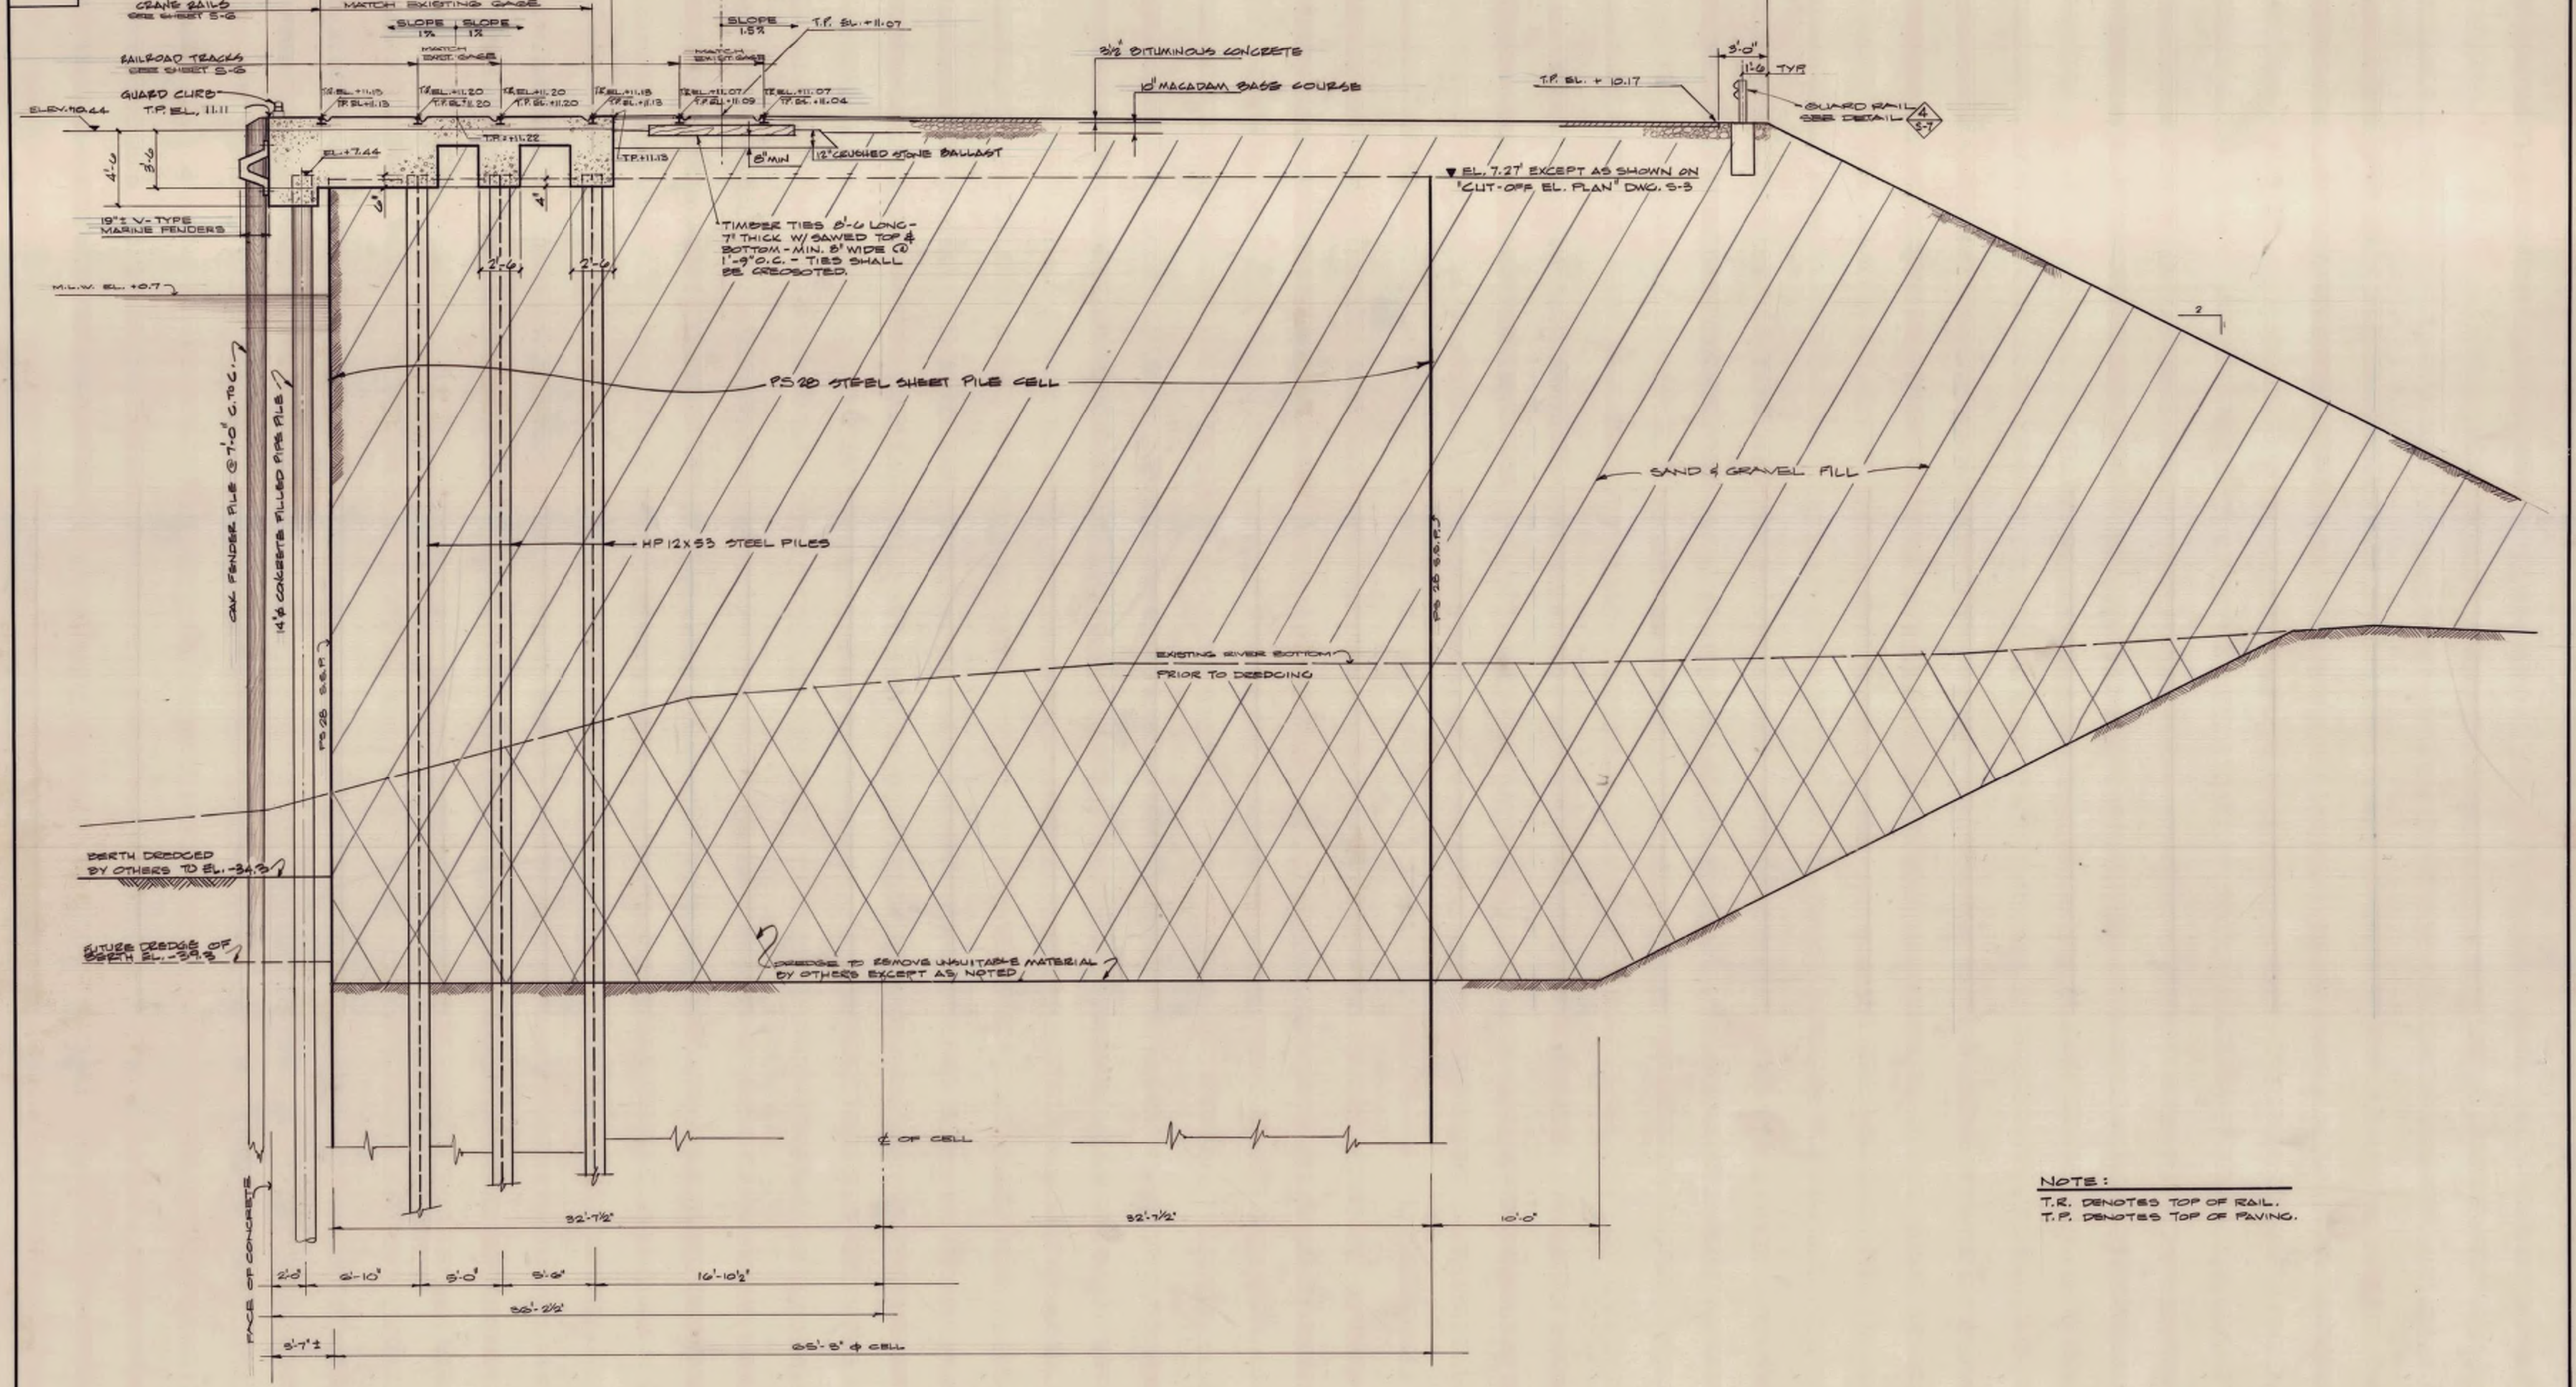

A-A SECTION 'A-A'
 SCALE: 1/2"=1'-0"

NOTE:
 T.R. DENOTES TOP OF RAIL.
 T.P. DENOTES TOP OF PAVING.

APPROVALS APPROVED BY: [Signature] FOR: PROJECT DATE: 3-22-78				S. T. HUDSON ENGINEERS, INC. PROFESSIONAL ENGINEERS & CONSULTANTS 211 South Broad Street Philadelphia, Pa. 19107 SOUTH JERSEY PORT CORPORATION BECKETT STREET TERMINAL CAMDEN, N. J.
DRAWN: H.H. RAE DATE: MARCH 20, 1978 CONTRACT NO.: H-1080 CHECKED: J.V. FILE: Sp-1075 DFTG. APPROVAL: [Signature]				
TYPICAL CROSS SECTION THROUGH NEW EXTENSION BERTH NO. 4 Swg. no. 6-2 Rev. 0				

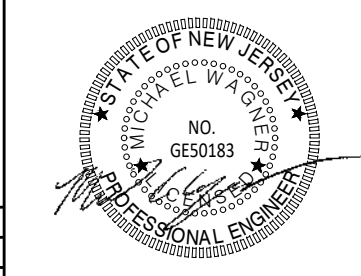

URBAN ENGINEERS, INC.
 530 Walnut Street
 Philadelphia, PA. 19106
 (215) 922-8080 Fax (215) 922-8082

CAMDEN, N.J.
 S.J.P.C. BALZANO MARINE TERMINAL
 RAIL INFRASTRUCTURE REHABILITATION
 EXISTING BERTH 4 CROSS SECTION
 CONSTRUCTION RECORD DRAWINGS

DWN: FST PROJ # []
 CRK: DATE [] DRAWING NUMBER: EX-3

ISSUED FOR BID

REV	BY	DATE	DESCRIPTION